

Drain: ELWOOD WILSON **Drain #:** 126
Improvement/Arm: NOBLESVILLE HIGH SCHOOL AREA
Operator: J. LIVINSTON **Date:** 7-19-04
Drain Classification: Urban/Rural **Year Installed:** 1994

GIS Drain Input Checklist

- Pull Source Documents for Scanning
- Digitize & Attribute Tile Drains
- Digitize & Attribute Storm Drains
- Digitize & Attribute SSD
- Digitize & Attribute Open Ditch
- Stamp Plans
- Sum drain lengths & Validate
- Enter Improvements into Posse
- Enter Drain Age into Posse
- Sum drain length for Watershed in Posse
- Check Database entries for errors

[Handwritten signatures and initials over the checklist items]

Gasb 34 Footages for Historical Cost
Drain Length Log

Drain-Improvement: ELLWOOD WILSON - NOBLESVILLE HIGH SCHOOL AREA

Drain Type:	Size:	Length (ASBUILT)	Length (DB Query)	Length Reconcile	Price:	Cost:
RECP	18"	715'	760'	+45'	10.50/ft	7,980.00
	36"	1139.6'	1139.6'		32.25/ft	36,752.50
	42"	1452.1'	1452.1'		52.65/ft	76,453.07
CMPPA	(4x8') 96"X67"	387	448'	+61'	96.17/ft	43,084.14
CONCRETE BOX CULVERT	96"X48"	6'	45'	+45'	286.67/ft	12,900.00
REGULAR SEWER ** (±2040')	—	0'	0'		19.55/ft	39,882.00

Sum: 3493.7' 3844.7' +151' \$217,051.48
 -2943.7' // DRAIN

Final Report: 3493'

Comments:

* ASBUILTS ? Surveyor's report conflict

** SWALE LENGTH MEASURED IN GIS

*** 45' OF PARALLEL DRAIN


**** ± 285' // DRAIN

***** 22' // DRAIN

This copy is from the Digital Archive of the Hamilton County Surveyor's Office; Noblesville, In 46060

■ 2571.7' // DRAIN

TOTAL 2943.7' // DRAIN

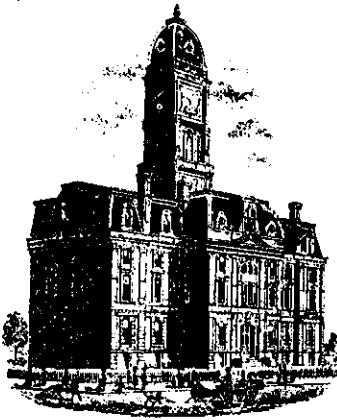

Kenton C. Ward, Surveyor

Suite 146

776-8495

One Hamilton County Square
Noblesville, Indiana 46060-2230

December 13, 1993

TO: Hamilton County Drainage Board

RE: Elwood Wilson Drain

Attached is a petition for the Noblesville School Board for the reconstruction of the Elwood Wilson Drain. The petition is accompanied by plans for both the onsite and offsite work. This proposal was necessitated by the reconstruction of the new Noblesville High School, located on the old county farm property. (Cumberland Road and Monument Street)

The onsite work consists of the relocation of the existing tile at the North West corner of Cumberland Road and Monument Street. Plans showing the relocation are those showing the onsite construction as prepared by the Odle McGuire & Shook Corporation, Sheet SD-5. Approximately 330 feet of 18" tile will be replaced with 710 feet of 18" RCP. This is the portion between Structures 250, 117, 119 and 259. The surface water between Cumberland Road and Monument Street is to be enclosed in pipe. This will consist of 387 feet of 4x8 CMPA. I recommend that this become part of the regulated drain. The Fishers-County Farm arm shall be extended to the existing Gascho-County Farm Drain. This will consist of 300 feet of 18" RCP. The remainder of the Fishers-County Farm Arm will remain as is. The cost for this work is included in the onsite cost for the school construction.

The offsite plans consists of two segments. As shown on the offsite plans by Marchris/Moore Engineers, 1451 feet of 42" RCP and 1113 feet of 36" RCP is to be installed from the outlet of the retention facility to STA 5+40 on Sheet #3. This is to become part of the regulated drain and will serve only the school property.

The second portion of the offsite shall consist of a surface


water swale to be constructed and/or improved between Monument Street and the open Elwood Wilson Drain South of Cherry Street. This portion includes new structures under Conner Street, Monument Street and Cherry Street.

The cost estimate for the project is as follows:

Pipe and Swale	\$ 367,214.00
Conner Street	170,000.00
Monument Street	45,000.00
Cherry Street	56,000.00
TOTAL	\$ 638,214.00

The cost of the crossing under State Road 32/38 (Conner Street) shall be paid by the State of Indiana. The cost of the Monument Street and Cherry Street crossings shall be borne by the City of Noblesville. The remainder of the cost is to be borne by the Noblesville School Corporation.

I recommend a hearing for this item be set for January 27, 1993.

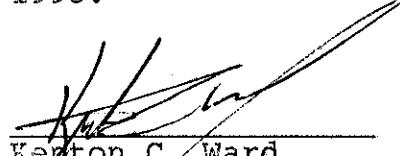

Kenton C. Ward
Hamilton County Surveyor

KCW/no



SURVEYOR'S OFFICE
Hamilton County
Indiana

Kenton C. Ward, Surveyor Suite 146

776-8495

One Hamilton County Square
Noblesville, Indiana 46060-2230

September 7, 1994

To: Hamilton Co. Drainage Board

Re: Elwood Wilson Drain
Noblesville High School Reconstruction

This report is a revision to my original report dated December 13, 1993. The Board at its meeting on January 24, 1994 held a hearing for the reconstruction of the Elwood Wilson Drain per the afore mentioned report. At the hearing the Board approved the new 42" tile from the schools detention facility north of Monument Street to the point the line outlets into the existing surface water swale north of Cherry Street. However, at that time the Board tabled the portion of the project concerning the regrading of the surface water swale between Cherry Street and Monument Street along with new structures under S.R. 32, Monument & Cherry Streets.

After meeting with the parties involved, I have concluded that the State Highway will resist any effort to enlarge the structure for surface water under S.R. 32. Also, the City of Noblesville has pointed out that due to the fact the County has a Cumulative Bridge Fund, per IC 8-16-3-1, the County must fund the replacement structures under Cherry & Monument Streets. During discussions with the County Commissioners and County Highway, I have been informed that these funds are needed elsewhere and there is no interest from the County to replace the two structures for the proposed project.


After several months, I now believe a compromise solution has been reached. This solution revises the plan as submitted in January in regard to the surface water swale and the crossings. The 42" storm sewer will not be affected by the revision.

The revised plan calls for the existing Cherry Street and S.R. 32 crossings to remain unchanged. The regrading of the surface water swale between Cherry Street and S.R. 32 is to be omitted. The Monument Street structure will be installed by the School's contractor. The surface waterway between S.R. 32 and Monument Street will also be constructed by the School's contractor. The waterway as constructed will be modified by decreasing the bottom width 7-8 feet, side slopes laid back to a 4:1, and removing the gabion baskets between Sta. 9+85 to 10+92. Attached is proposal request No. 1 dated 07-20-94 for the NHS off-site drainage contract and proposal request No. 32 dated 07-20-94 for the on-site contract which goes into detail for the changes.

It should be noted that the design for the High School drainage project never addressed increasing or decreasing the flow carrying capabilities of the Elwood Wilson Drain. Only the course of the water-way was altered, maintaining an exact equal drainage cross section. For short lengths on the High School property, the Elwood Wilson Drain was enclosed and made subterranean by using concrete and 60 milvert of the same flow carrying capacity as the open ditch. This encasement was done for cosmetic purposes.

Considering all the above, it should be stated that the drainage ditch still only has the capacity to carry what it could before these improvements. The work being done by the School Corporation's Contractors can only help the flooding situation by improving the profile/pitch of the existing drain route. The improvements do not aggravate the existing condition. Any flooding along the drain way that occurred before the improvements will likely still occur after these improvements. The School Corporation could never be judged responsible for flood damage as a result of these improvements.

I recommend the Board approve the project as revised above.

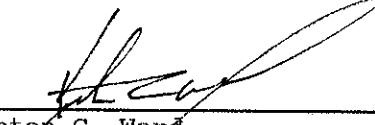

Kenton C. Ward,
Hamilton County Surveyor

CERTIFICATE OF COMPLETION AND COMPLIANCE


To: Hamilton County Surveyor

Re: Noblesville High School
On-Site and Off-Site Improvements - Elwood Wilson Drain Reconstruction

I hereby certify that:

1. I am a Registered Land Surveyor or Engineer in the State of Indiana .
2. I am familiar with the plans and specifications for the above referenced subdivision .
3. I have personally observed and supervised the completion of the drainage facilities for the above referenced subdivision .
4. The drainage facilities within the above referenced subdivision to the best of my knowledge , information and belief have been installed and completed in conformity with all plans and specifications .

Signature:

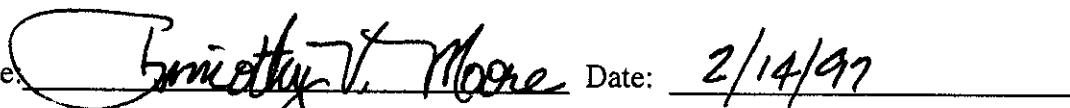

Timothy V. Moore Date: 2/14/97

Type or Print Name: Timothy V. Moore

Business Address: 9245 N. Meridian St., Suite 105

Indianapolis, IN 46260-1812

Telephone Number: (317) 848-5045


SEAL

INDIANA REGISTRATION NUMBER

PE60013815



This document is from the Digital Archive of the Hamilton County Surveyor's Office; Noblesville, In 46060

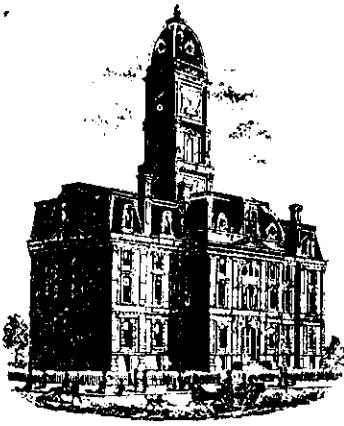

Kenton C. Ward, Surveyor

Phone (317) 776-8495

Fax (317) 776-9628

Suite 146

One Hamilton County Square
Noblesville, Indiana 46060-2230

To: Hamilton County Drainage Board

June 12, 1998

Re: Elwood Wilson Drain: Noblesville High School
Arm

Attached are as-builts, certificate of completion & compliance, and other information for Noblesville High School Arm. An inspection of the drainage facilities for this section has been made and the facilities were found to be complete and acceptable.

During construction, changes were made to the drain which will alter the plans submitted with my report for this drain dated September 7, 1994. The changes are as follows:

ONSITE DRAINAGE				
STR. 1 (EXIST.)	778.37	774.86		
STR. 2 (EXIST.)		774.66		
STR. 274	775.05	771.56		
STR. 271	775.08	771.04		
STR. 3	773.38	769.23		
STR. 259	773.6	764.95	18" RCP	320
STR. 259	774.05	767.56		
STR. 259 A	773.6	764.95	18" RCP	45
STR. 259 A	773.6	764.95		
STR. 260	772.18	764.25	18" RCP	350
OFFSITE DRAINAGE				
STR. 1A		762.3		
STR. 1	768.93	762.4	42" RCP	342
STR. 1	768.93	762.4		
STR. 2	769.61	762.4	42" RCP	102
STR. 2	769.61	762.4		
STR. 3	769.76	762.76	42" RCP	423

STR. 3	769.76	762.81		
STR. 4	769.74	762.89	42" RCP	261.6
STR. 4	769.74	762.89		
STR. 5	768.61	763.02	42" RCP	323.5
STR. 5	768.61	763.21		
STR. 3A	768.77	764.05	36" RCP	577.3
STR. 3A	768.77	764.05		
STR. 6	771.38	764.34	36" RCP	428.3
STR. 6	771.38	764.34		
STR. 253	771.92	766.37	36" RCP	106
STR. 253	771.92	766.37		
STR. 256		766.57	36" RCP	28

Other Drain:	
4X8 CMPA	387
SURFACE SWALE	0 ADDITIONAL


There was approximately 330 feet of existing tile replaced.

The length of the additional drain due to the changes described above is now **3363 feet**.

The non-enforcement for Noblesville H. S. parcel 11-07-31-00-00-009.000 was approved by the Board at its meeting on October 14, 1996 and recorded under instrument #9609644124.


I recommend the Board approve the drains construction as complete and acceptable.

Sincerely,

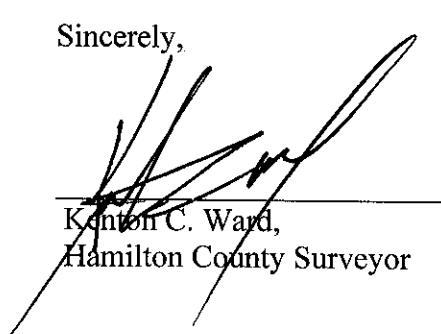


Kenton C. Ward,
Hamilton County Surveyor

KCW/slm

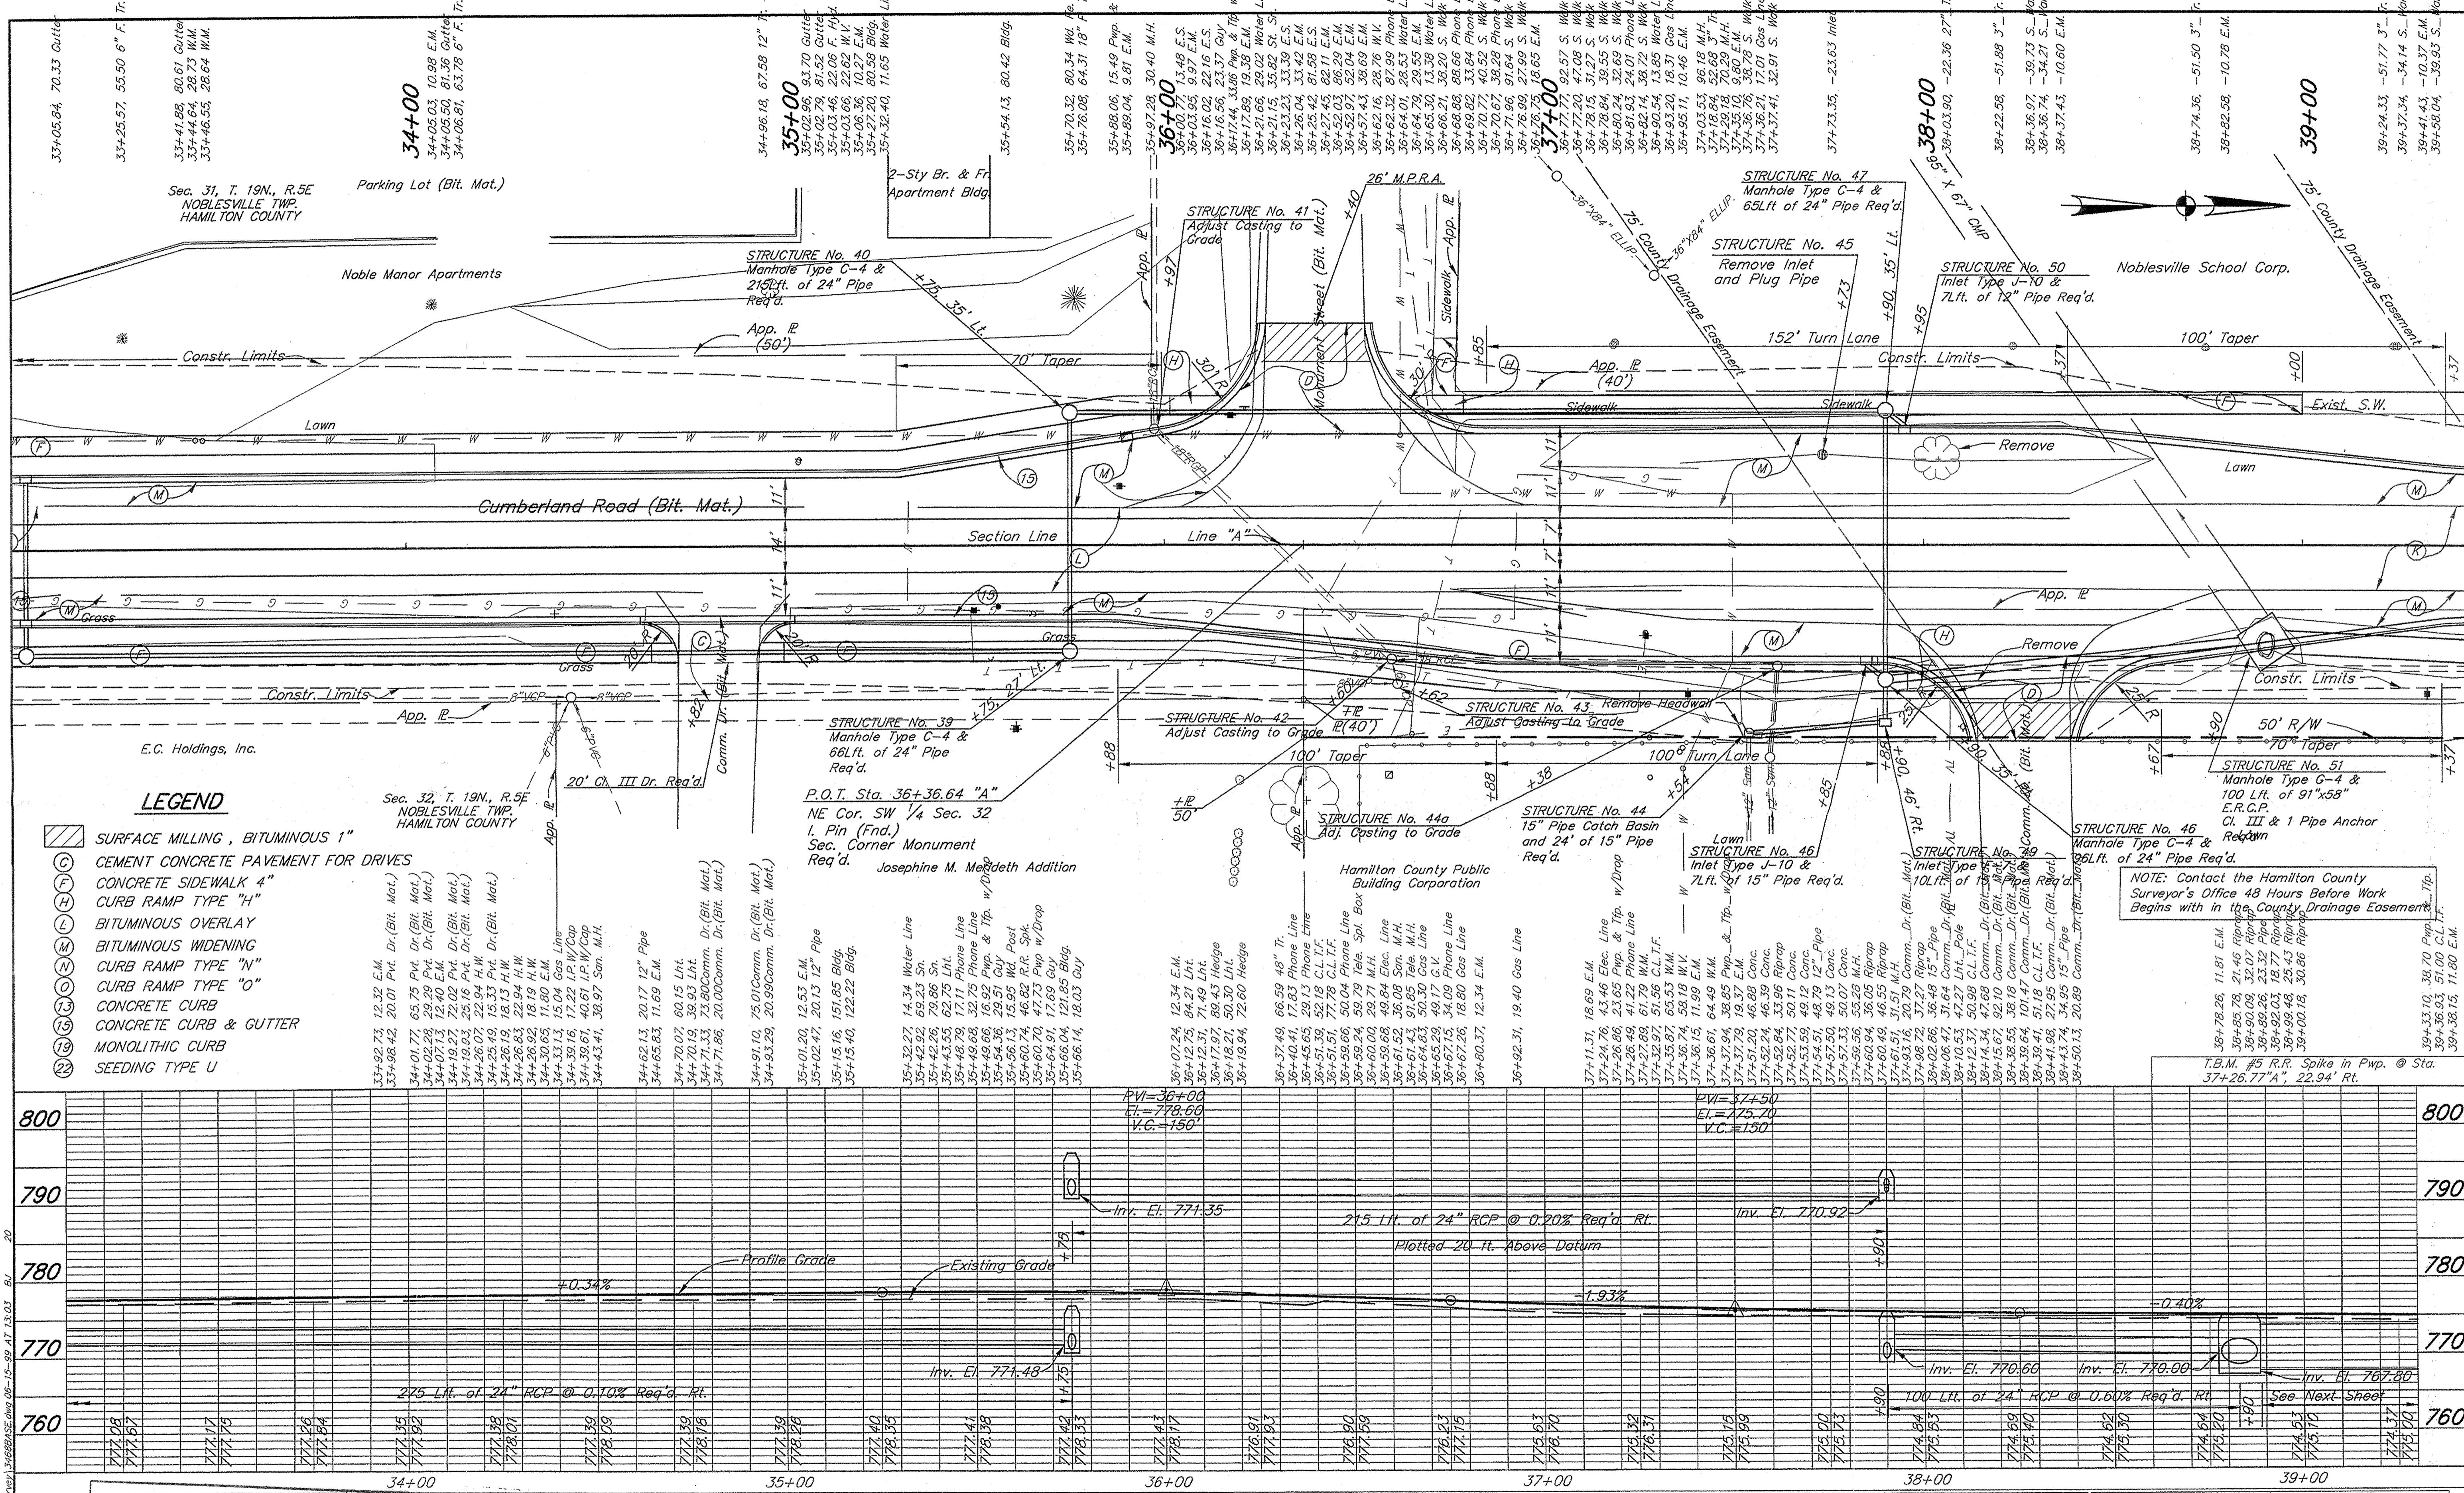

This information was gathered
into the Hamilton County Ge-
ographic Information System. This doc-
ument is considered an official record
of the GIS.

Entered by: JW

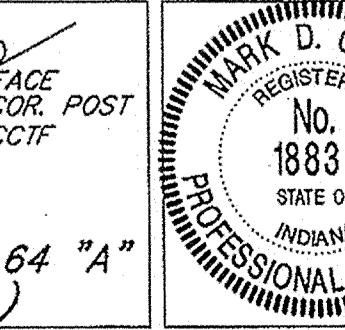

	RECOMMENDED FOR APPROVAL	
	<hr/>	
	DESIGNED:	M.O.
<hr/>		
CHECKED		

CHECKED: _____


HORIZONTAL SCALE	FILE
1"=20'	3468
VERTICAL SCALE	DESIGNATION
1"=20'	
SURVEY BOOK	SHEET
272	9 OF 36
CONTRACT	PROJECT

SITE IMPROVEMENTS

FOR

NOBLESVILLE HIGH SCHOOL OFF-SITE


Post Construction Survey

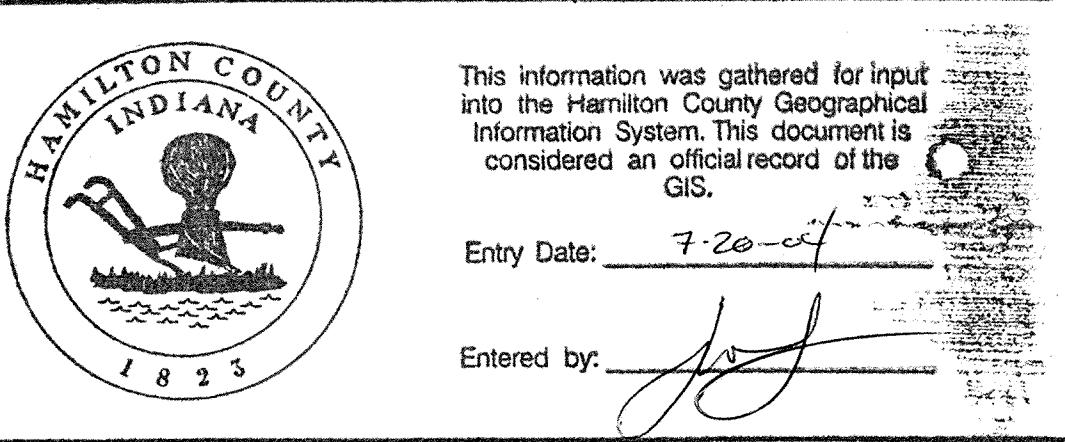


ELWOOD WILSON DRAINAGE EASEMENT
IMPROVEMENTS – CHERRY STREET TO
MONUMENT STREET

NOBLESVILLE, INDIANA

INDEX
1. TITLE SHEET
2. PLAN & PROFILE-STA. 0+00 TO 5+00
3. PLAN & PROFILE-STA. 5+00 TO 10+00
4. PLAN & PROFILE-STA. 10+00 TO 15+00
5. PLAN & PROFILE-STA. 15+00 TO 20+00
6. PLAN & PROFILE-STA. 20+00 TO 25+00
7. PLAN & PROFILE-STA. 25+00 TO 30+00
8. CROSS SECTIONS-STA. 0+00 TO 5+00
9. CROSS SECTIONS-STA. 5+50 TO 10+00
10. CROSS SECTIONS-STA. 10+50 TO 15+00
11. CROSS SECTIONS-STA. 15+50 TO 20+00
12. CROSS SECTIONS-STA. 20+50 TO 25+00
13. CROSS SECTIONS-STA. 25+50 TO 30+00
14. CULVERT AT CHERRY STREET
15. CULVERT AT CONNER STREET
16. CULVERT AT MONUMENT STREET
17. DETAILS & PROJECT SPECIFICATIONS
18. TOPOGRAPHIC SURVEY BY WEIHE ENGINEERS, INC.
19. TOPOGRAPHIC SURVEY BY WEIHE ENGINEERS, INC.
20. TOPOGRAPHIC SURVEY BY WEIHE ENGINEERS, INC.

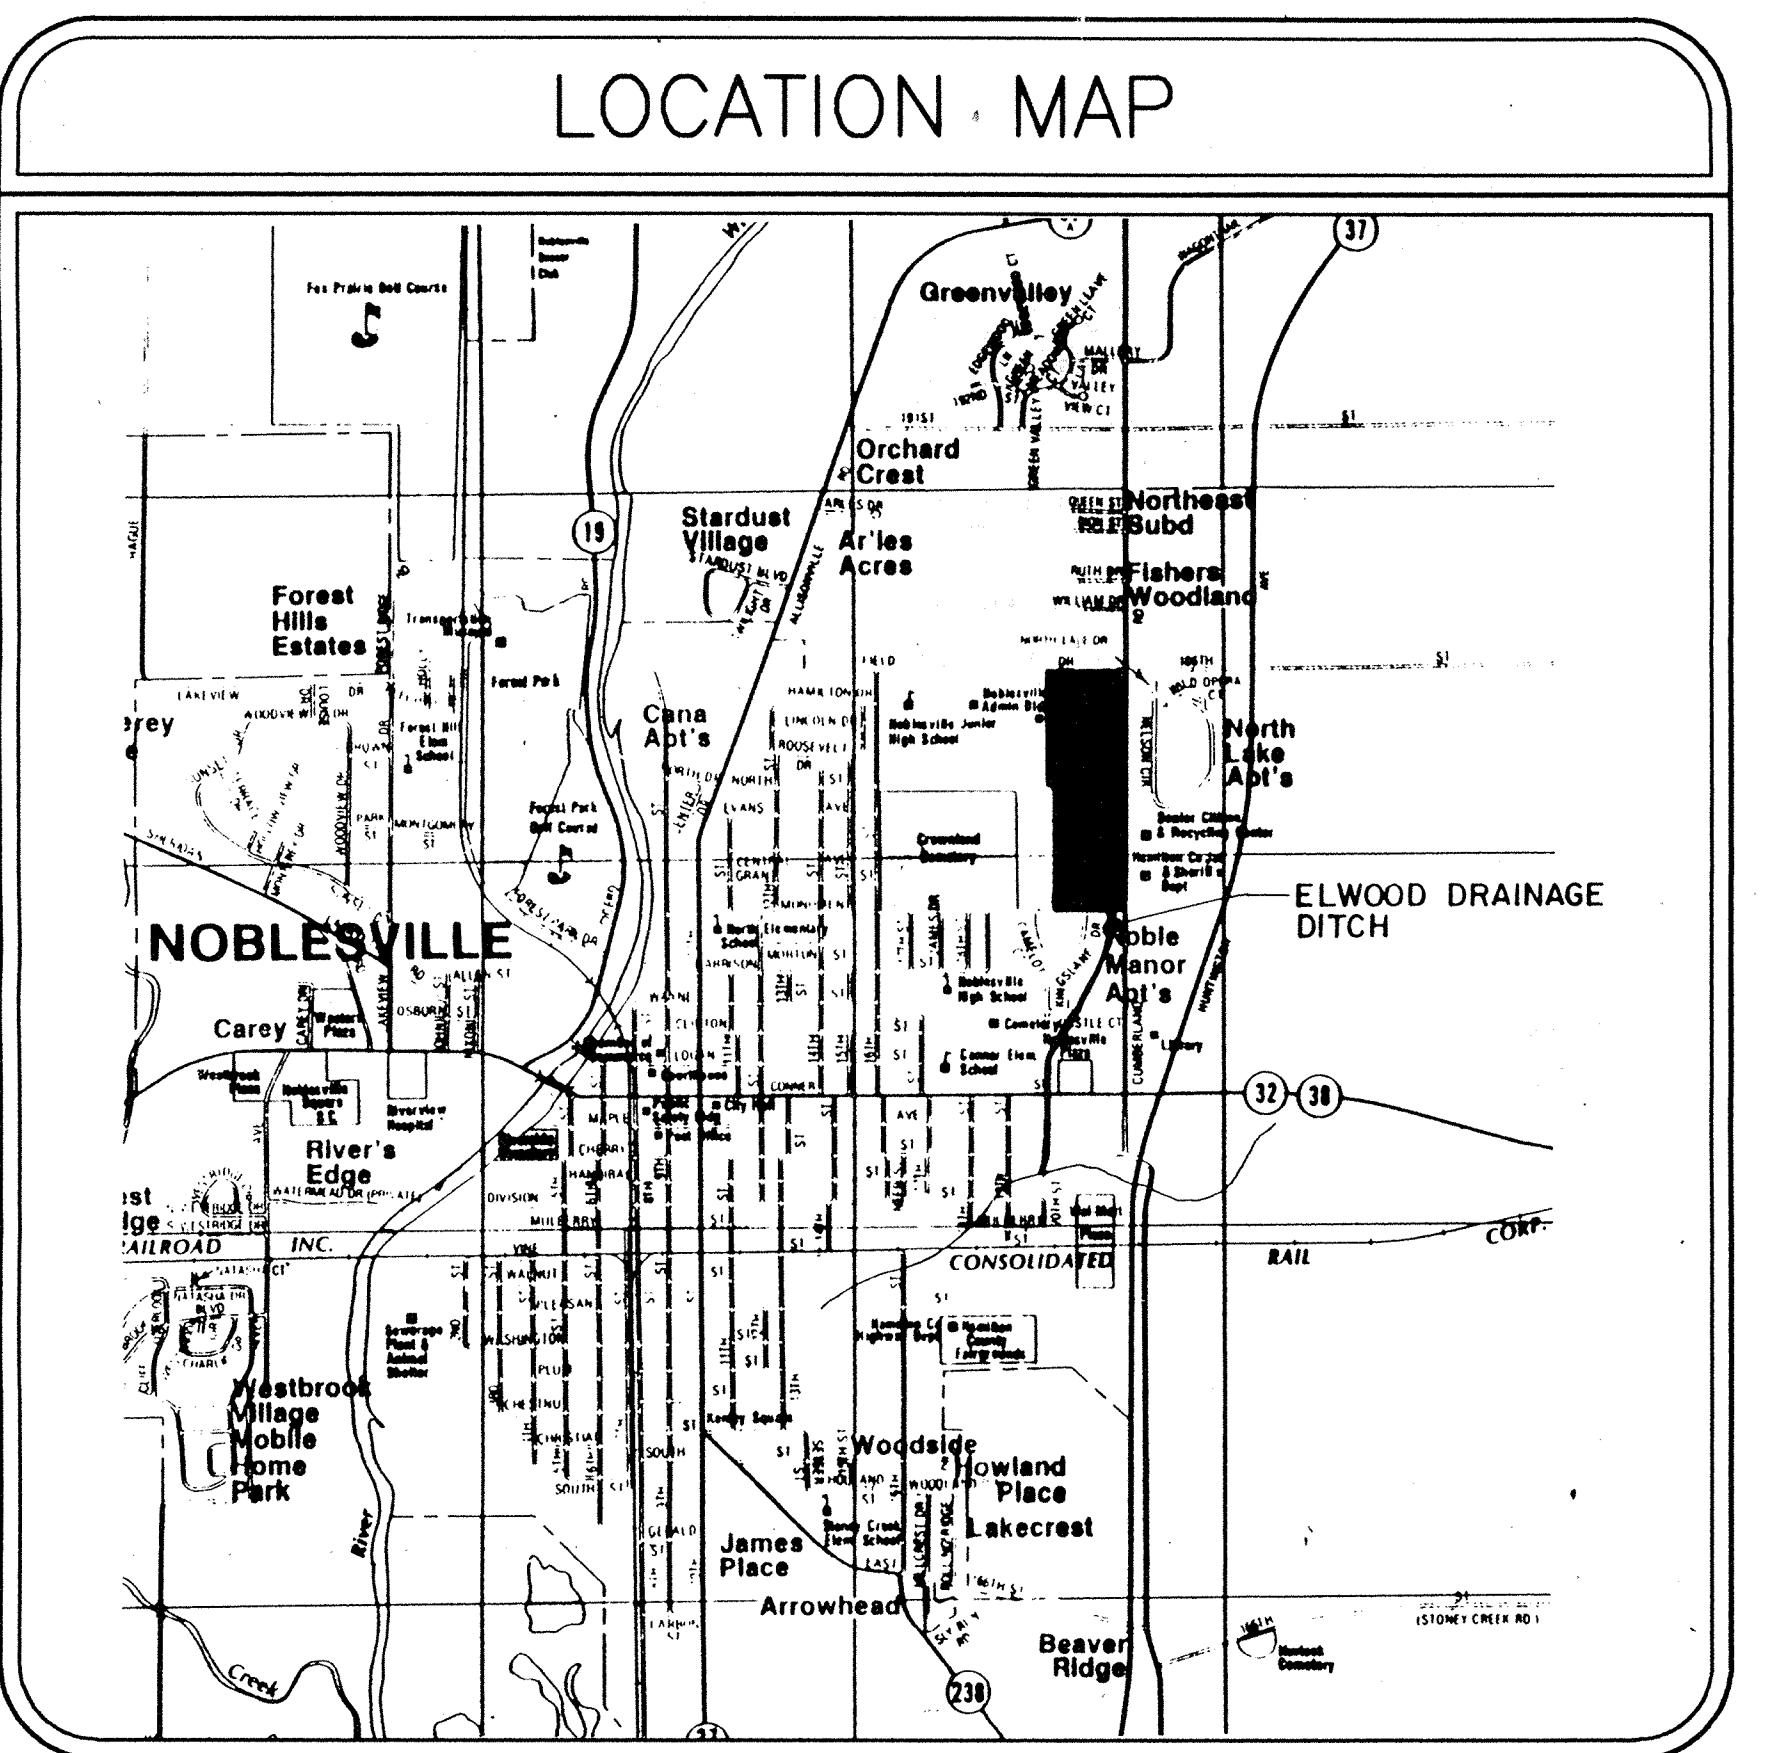

SECTION 31, TOWNSHIP 19 NORTH, RANGE 5 EAST
HAMILTON COUNTY, INDIANA

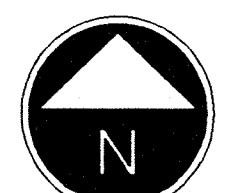

BENCHMARKS
T.B.M. 1 - LARGE NAIL SET IN EAST SIDE OF A POWER POLE LOCATED ON THE SOUTH SIDE OF MONUMENT STREET, 245' WEST OF CUMBERLAND ROAD - ELEVATION 781.69
T.B.M. 2 - LARGE NAIL SET IN 42" HACKBERRY TREE LOCATED 600' SOUTH OF MONUMENT STREET - ELEVATION 772.13
T.B.M. 3 - P.K. NAIL SET IN POWER POLE LOCATED 150' NORTH OF THE DOLLAR GENERAL STORE - ELEVATION 771.47
T.B.M. 4 - SOUTHEAST ANCHOR BOLT ON SELF SERVICE STORAGE METAL/PLASTIC SIGN LOCATED 200' NORTH OF STATE ROAD (38/32) (CONNER STREET) - ELEVATION 774.13

ELWOOD WILSON DRAINAGE EASEMENT
IMPROVEMENTS – CHERRY STREET TO
MONUMENT STREET


Record Drawing only for the top of casting, invert elevations and length of pipe. Slope percentage represents a calculated figure and is for general information only.

Lyle D. Branson

2/11/97
Date

USI Consultants
5332 N. Temple Ave
Indianapolis, IN 46220

Reg. Land Surveyor
No. 9300007
State of Indiana

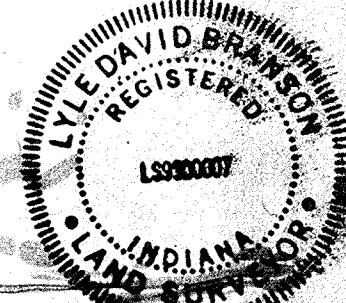

LEGEND	DESCRIPTION	
	EXISTING	PROPOSED
—>	SANITARY SEWER	—>
—<	STORM SEWER	—<
— — —	WATER MAIN	— — —
○	MANHOLE	●
○	CATCH BASIN	●
⊖	VALVE VAULT	●
— — —	PAVEMENT	— — —
Q	CURB & GUTTER	— — —
	FIRE HYDRANT	●
FL800.00	GUTTER FLOWLINE ELEV.	FL800.00
TC800.50	TOP OF CURB ELEV.	TC800.50
▼	FLARED END SECTION	▼
□	CURB INLET	■
800	CONTOURS	800
— — —	STORM CULVERT	— — —
	W/HEADWALL	





STATE OF INDIANA		
PRINCIPAL CERTIFIED BY		
PROJECT ENGINEER CERTIFIED BY		
PROJECT DESIGNER		
REVISIONS		
MARK	DATE	DESCRIPTION
91-93	PER OFFICE REVIEW	
II-15-93	OFFICE REVIEW	
I-18-97	RECORD DRAWINGS	
NOBLESVILLE HIGH SCHOOL OFF-SITE		ELWOOD WILSON DRAINAGE EASEMENT IMPROVEMENTS – CHERRY STREET TO MONUMENT STREET NOBLESVILLE, INDIANA
marchris/moore associates of indiana consulting engineers		9245 North Meridian Street Suite 105 Indianapolis, In 46260-1812 (317) 843-2520 FAX 848-2765
FILED FEB 19 1997 OFFICE OF HAMILTON COUNTY SURVEYOR		
TITLE: TITLE SHEET		
DATE	7-22-93	SHEET NO.
SCALE	NO SCALE	
JOB NO.	93-011	
DRAWN BY	S. WEBER	
1 of 20		

SOPH. E. ZONE
STATE OF INDIANA
REGIONAL ENGINEER

PRINCIPAL	PROJECT ENGINEER	
CERTIFIED BY		
PRINCIPAL		
PROJECT ENGINEER		
CERTIFIED BY		
PROJECT DESIGNER		
REVISIONS		
MARK	DATE	DESCRIPTION
SJW	9-1-93	OFFICE REVIEW
II-15-93	OFFICE REVIEW	
△ 6-2-94	REVISED FOR NEW STATIONING.	
△ 1-28-97	RECORDED DRAWINGS	

NOBLESVILLE HIGH SCHOOL OFF-SITE
ELWOOD WILSON DRAINAGE EASEMENT
IMPROVEMENTS - CHERRY STREET TO
MONUMENT STREET
NOBLESVILLE, INDIANA

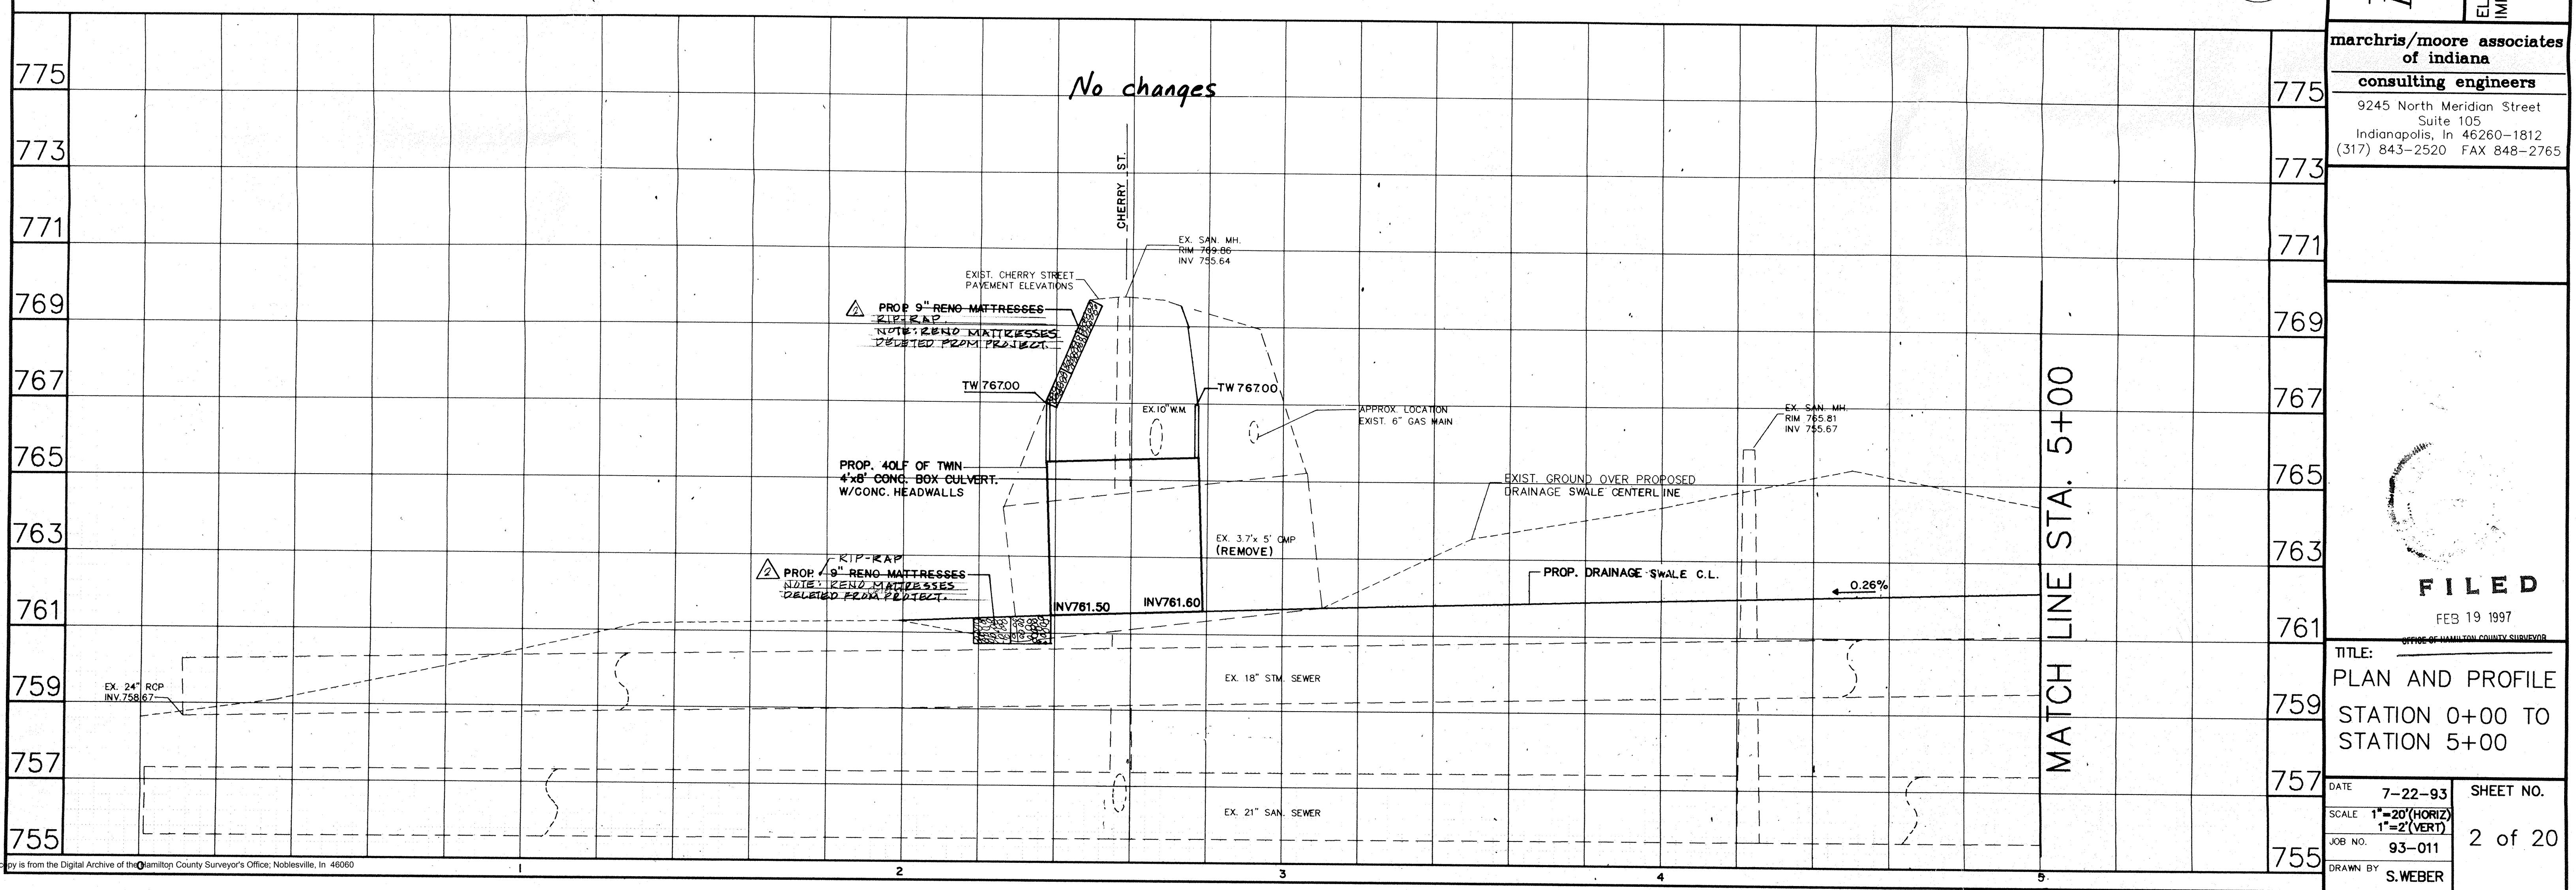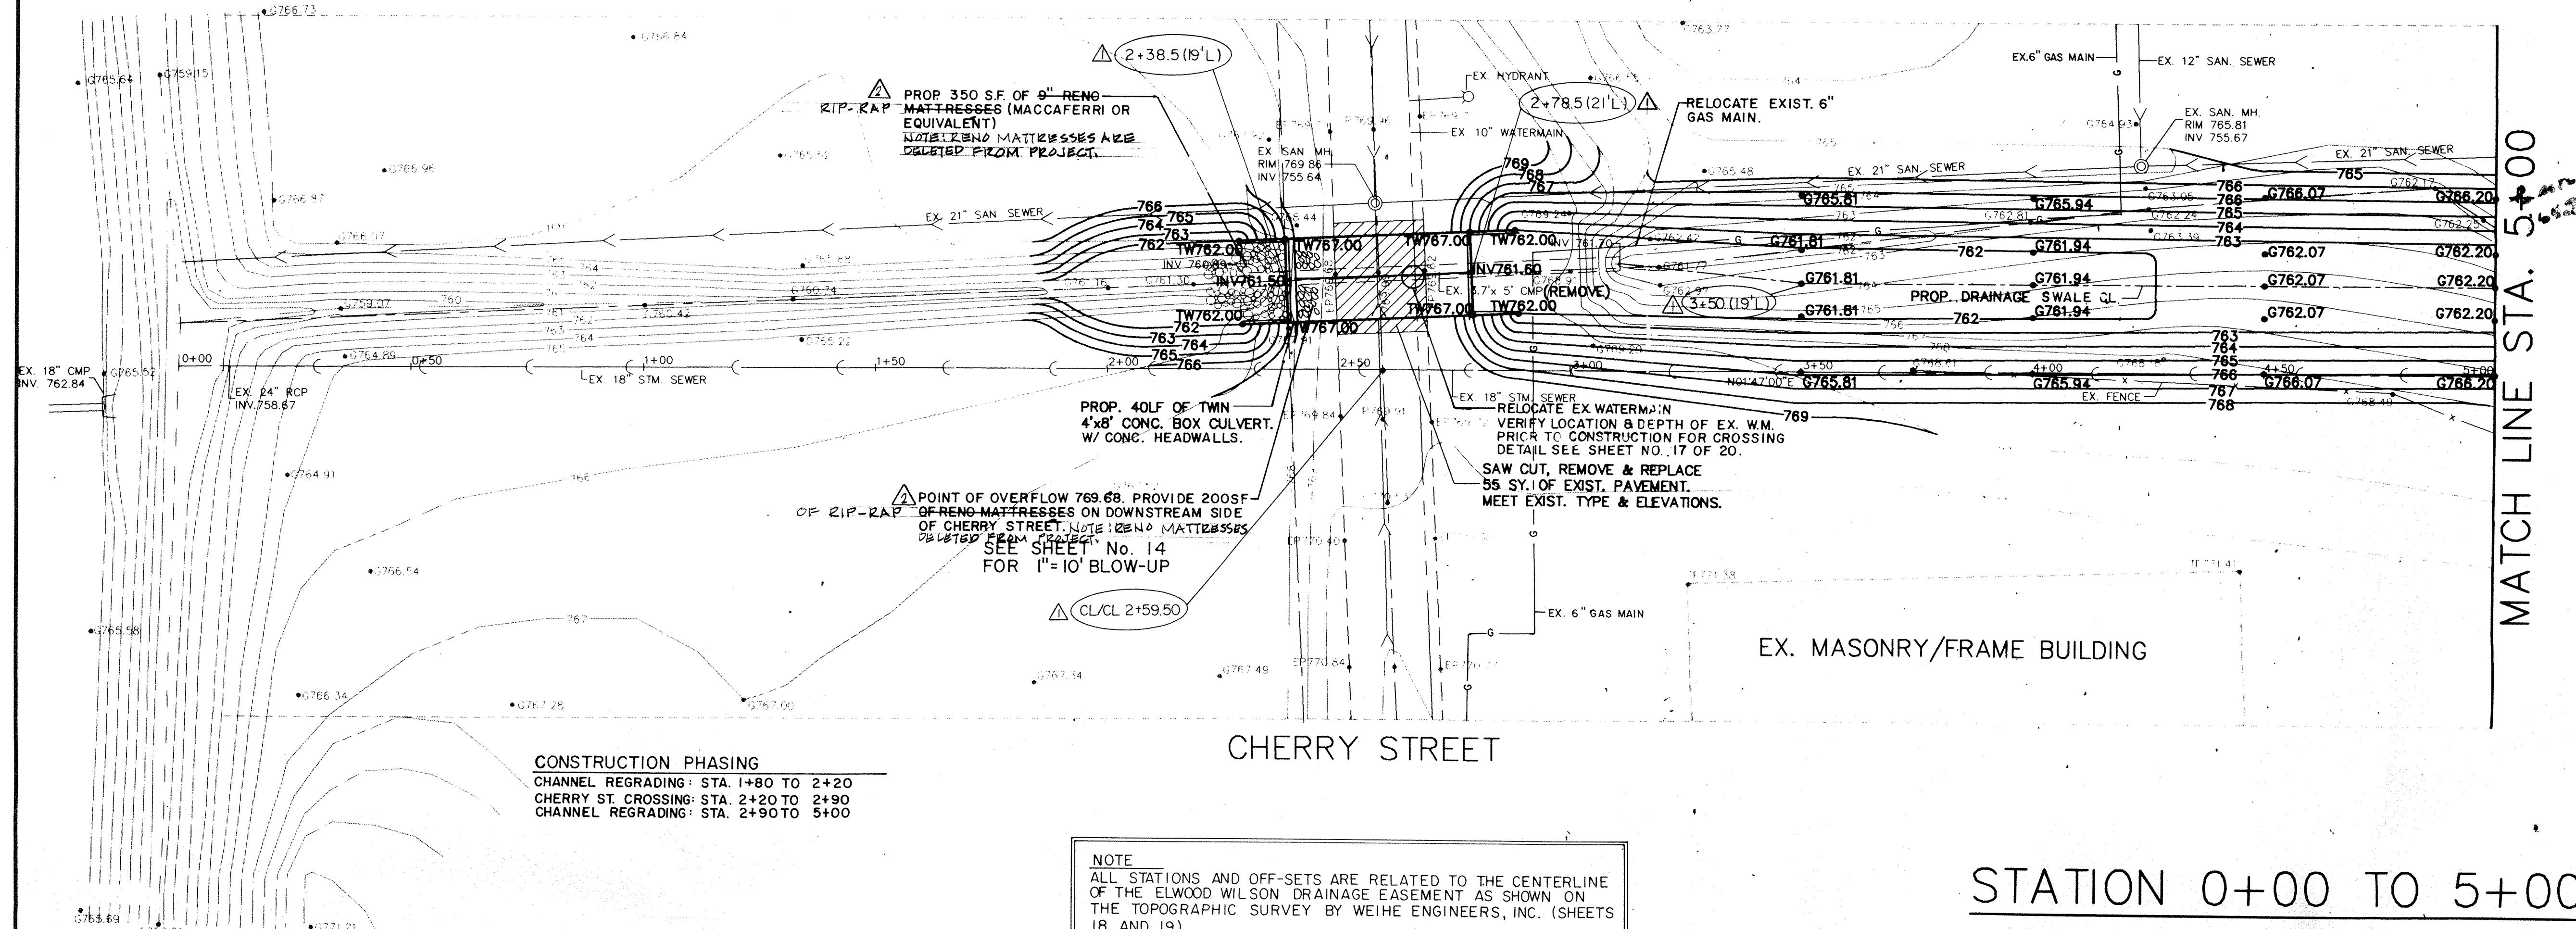

MATCH LINE STA. 5+00

CONSTRUCTION PHASING

CHANNEL REGRADING : STA. 5+0 TO 8+50
 CONNER ST. CROSSING : STA. 8+50 TO 9+85
 CHANNEL REGRADING : STA. 9+85 TO 10+0

*See Cross Sections
For Asbuilt ditch Elevation:*


EX. MASONRY BLDG

POINT OF OVERFLOW 769.80. PROVIDE
600 SF OF RENO-MATTRESSES ON DOWN
STREAM SIDE OF CONNER ST.
NOTE: RENO-MATTRESSES ARE DELETED
FROM PROJECT.

CONNER STREET

STATION 5+00 TO 10+00

NOBLESVILLE HIGH SCHOOL OFF-SITE
ELWOOD WILSON DRAINAGE EASEMENT
IMPROVEMENTS - CHERRY STREET TO
MONUMENT STREET
NOBLESVILLE, INDIANA

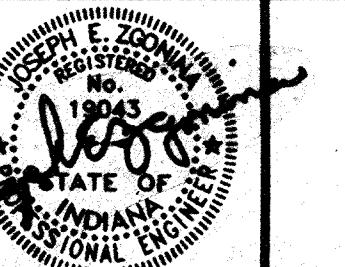

PRINCIPAL PROJECT ENGINEER

CERTIFIED BY

PRINCIPAL

PROJECT ENGINEER

CERTIFIED BY

PROJECT DESIGNER

REVISIONS

MARK DATE DESCRIPTION

SJW 9-1-93 OFFICE REVIEW

II-15-93 OFFICE REVIEW

△ 6-2-94 REVISED FOR NEW STATIONING


△ 1-28-97 RECORD DRAWINGS

END CONCRETE WALL, BEGIN
GABION WALL STA. 9+85 (BOTH
SIDES OF THE CHANNEL)

RELOCATE EX. GAS

RELOCATE EX. GAS METER

RELOCATE EX. GAS

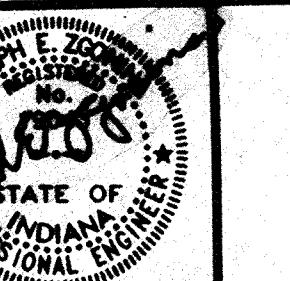

PROJECT ENGINEER

CERTIFIED BY

PRINCIPAL

PROJECT ENGINEER


CERTIFIED BY

PROJECT DESIGNER

REVISIONS

MARK	DATE	DESCRIPTION
SJW	9-1-93	OFFICE REVIEW
II-15-93	OFFICE REVIEW	
△	6.2.94	REVISED FOR NEW STATIONING.
△	12-28-97	RECORD DRAWINGS

NOBLESVILLE HIGH SCHOOL OFF-SITE
ELWOOD WILSON DRAINAGE EASEMENT
IMPROVEMENTS - CHERRY STREET TO
MONUMENT STREET
NOBLESVILLE, INDIANA

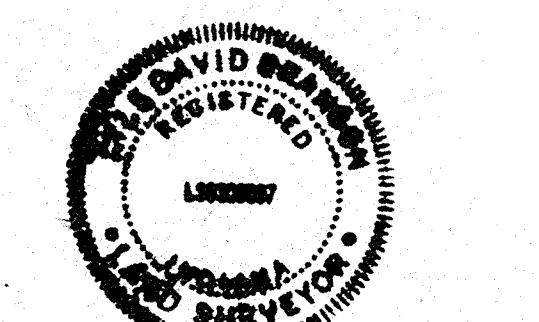marchris/moore associates
of indianaconsulting engineers
9245 North Meridian Street
Suite 105
Indianapolis, In 46260-1812
(317) 843-2520 FAX 848-2765POST CONSTRUCTION
SURVEY

FILED

FEB 19 1997
OFFICE OF HAMILTON COUNTY SURVEYOR

TITLE:
PLAN AND PROFILE
STATION 10+00 TO
STATION 15+00

DATE 7-22-93 SHEET NO.


SCALE 1"-20'(HORIZ)
1"-2'(VERT)

JOB NO. 93-011


DRAWN BY S.WEBER

4 of 20


MATCH LINE STA. 10+00

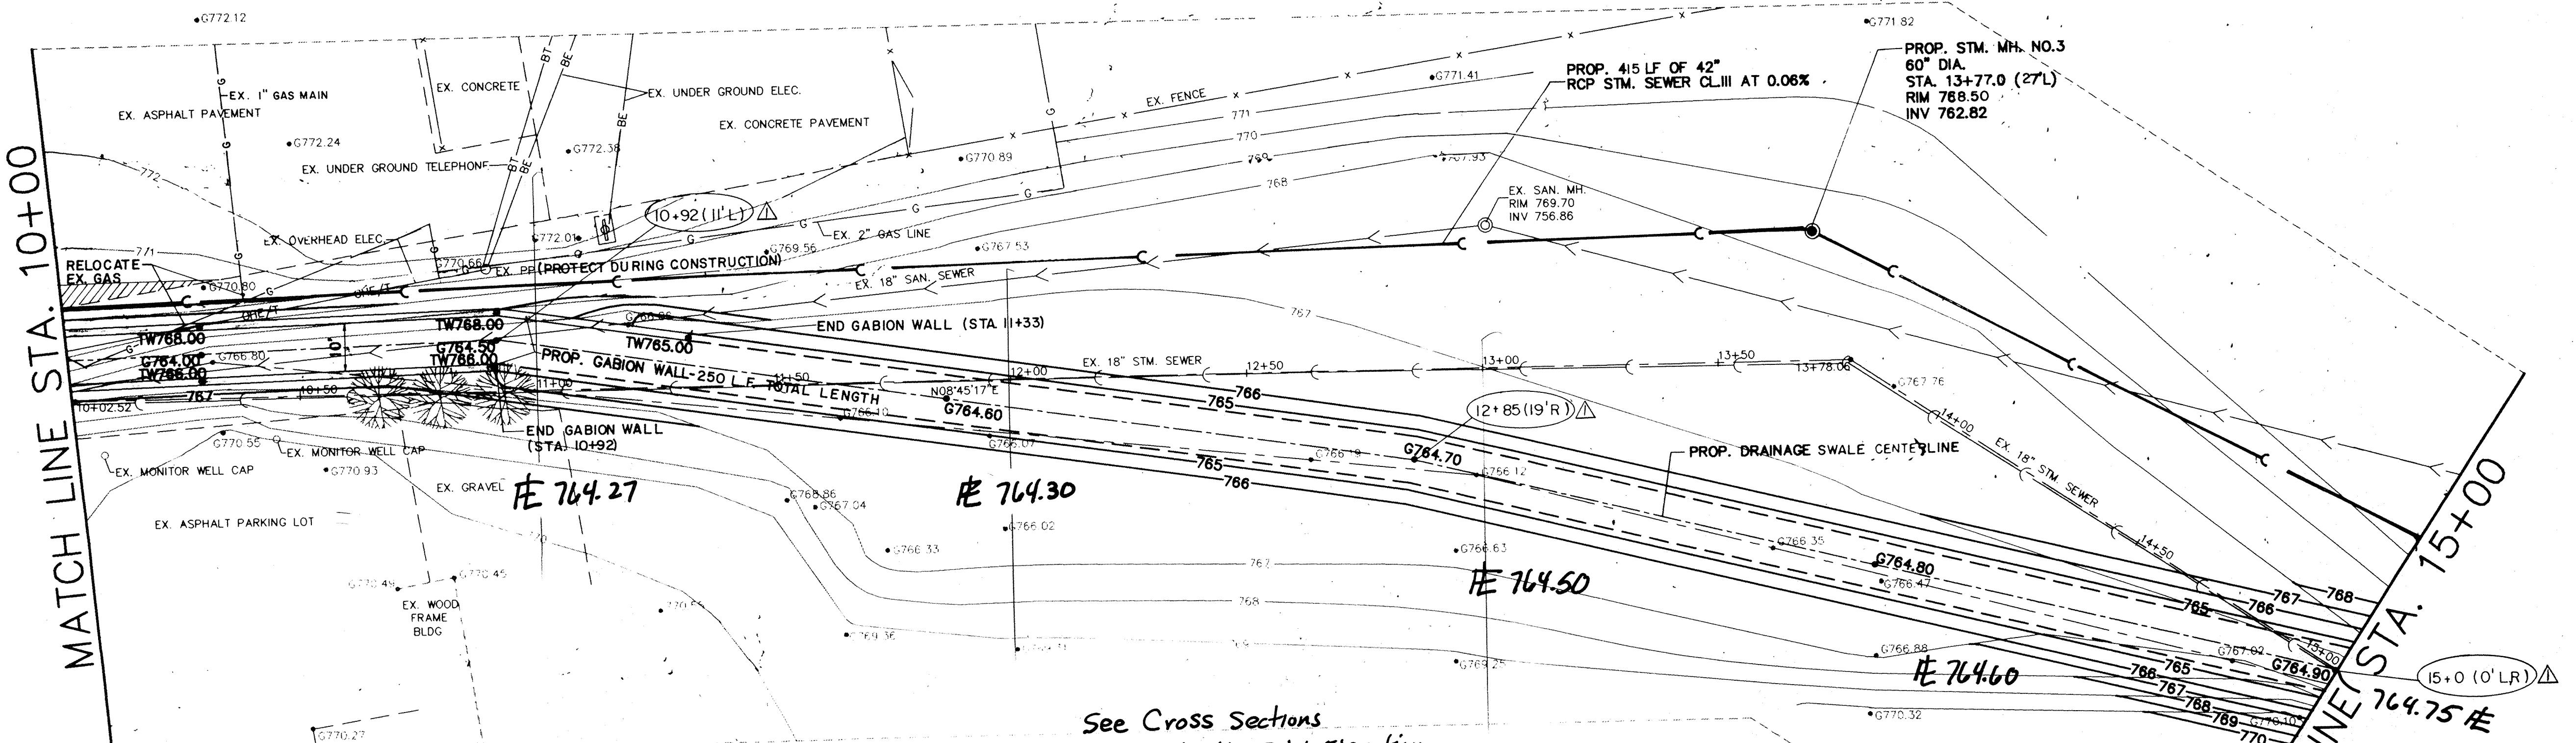


STATION 10+00 TO 15+00

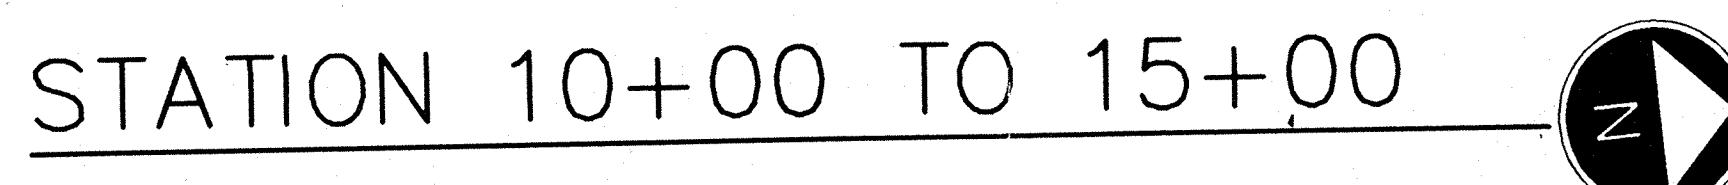

MATCH LINE STA. 10+00

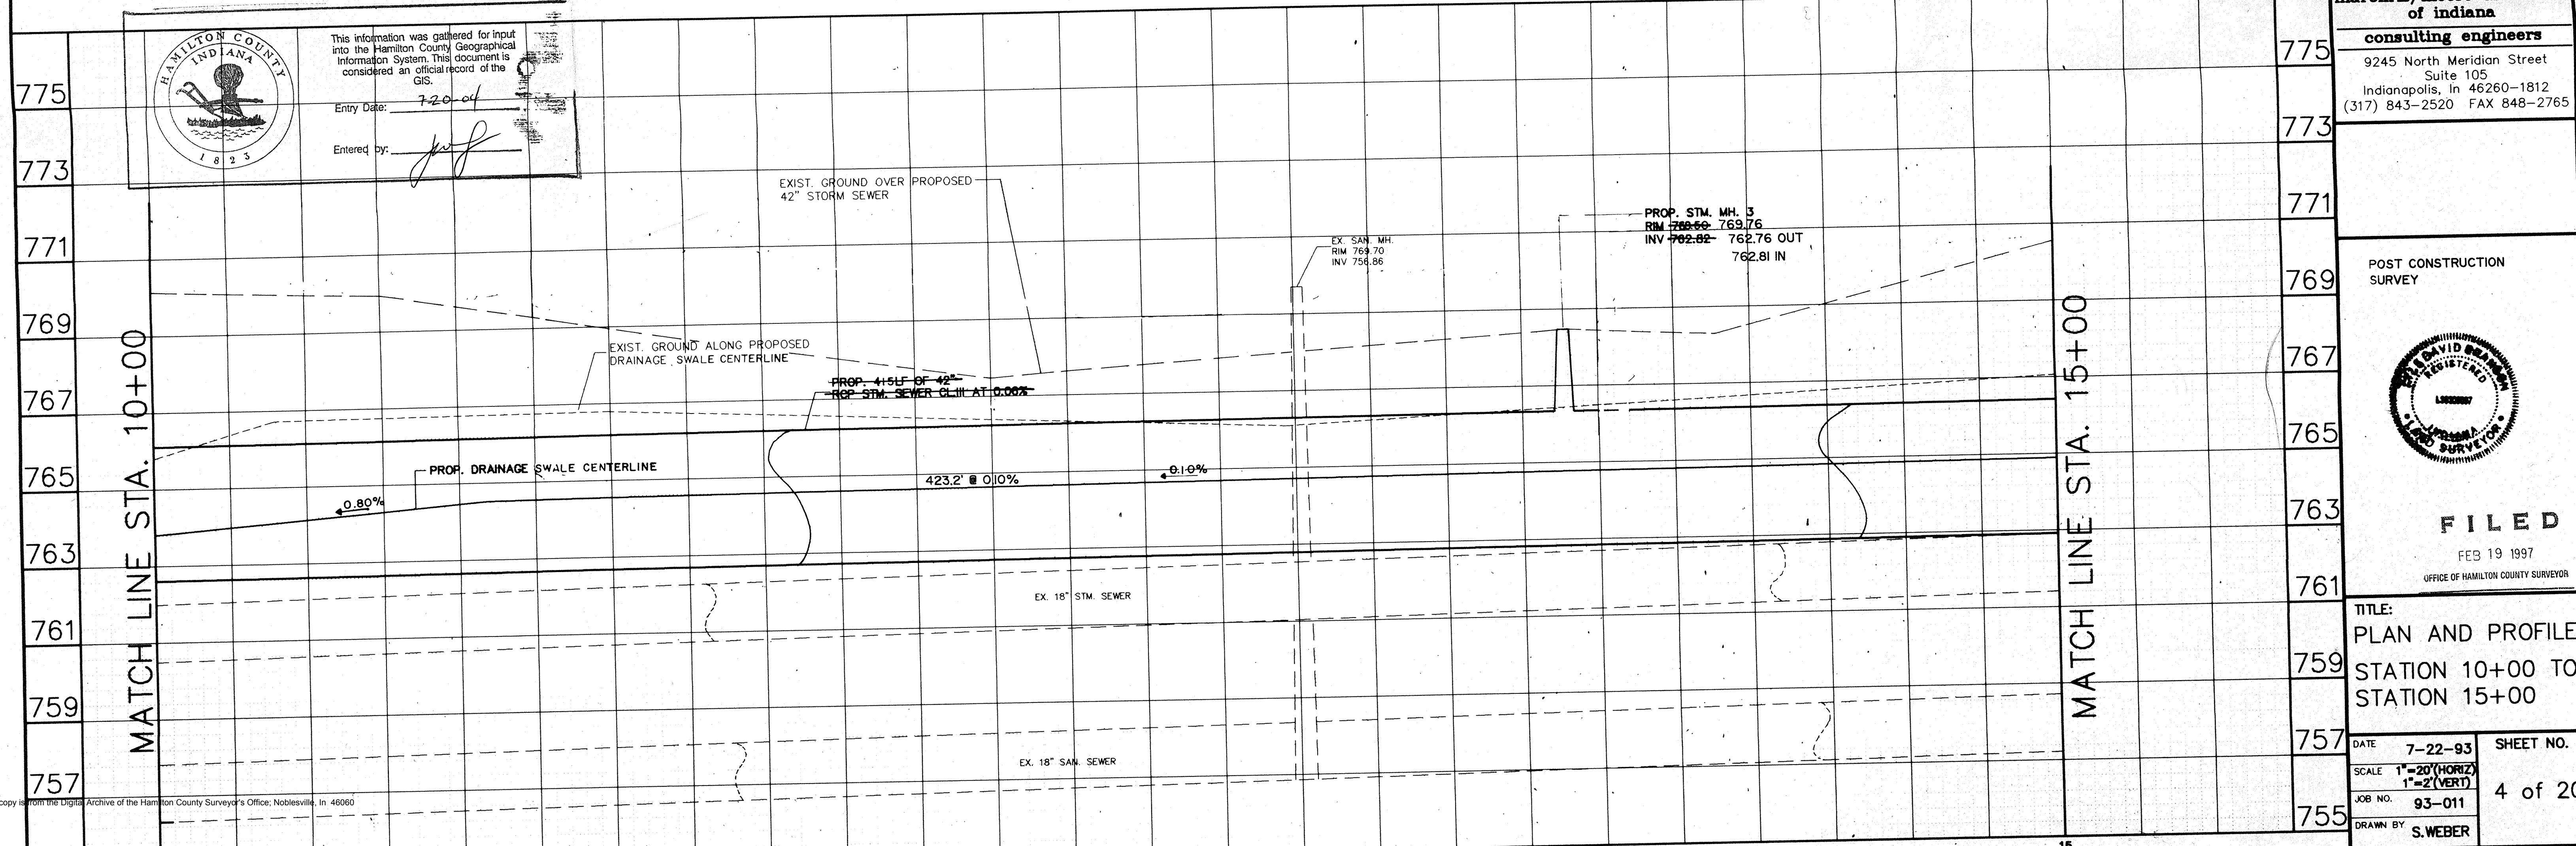

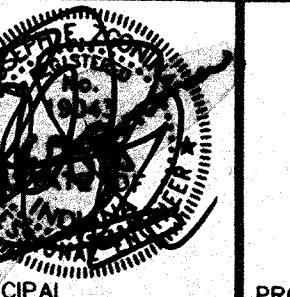

PRINCIPAL PROJECT ENGINEER

CERTIFIED BY

PRINCIPAL

PROJECT ENGINEER

CERTIFIED BY

PROJECT DESIGNER

REVISIONS

MARK DATE DESCRIPTION


9-1-93 PER OFFICE REVIEW

8-15-93 PER OFFICE REVIEW

△ 6-2-94 AMENDED FOR NEW STATIONING

△ 1-2-97 RECORDED DRAWINGS

NOBLESVILLE HIGH SCHOOL OFF-SITE
 ELWOOD WILSON DRAINAGE EASEMENT – CHERRY STREET TO MONUMENT STREET
 NOBLESVILLE, INDIANA

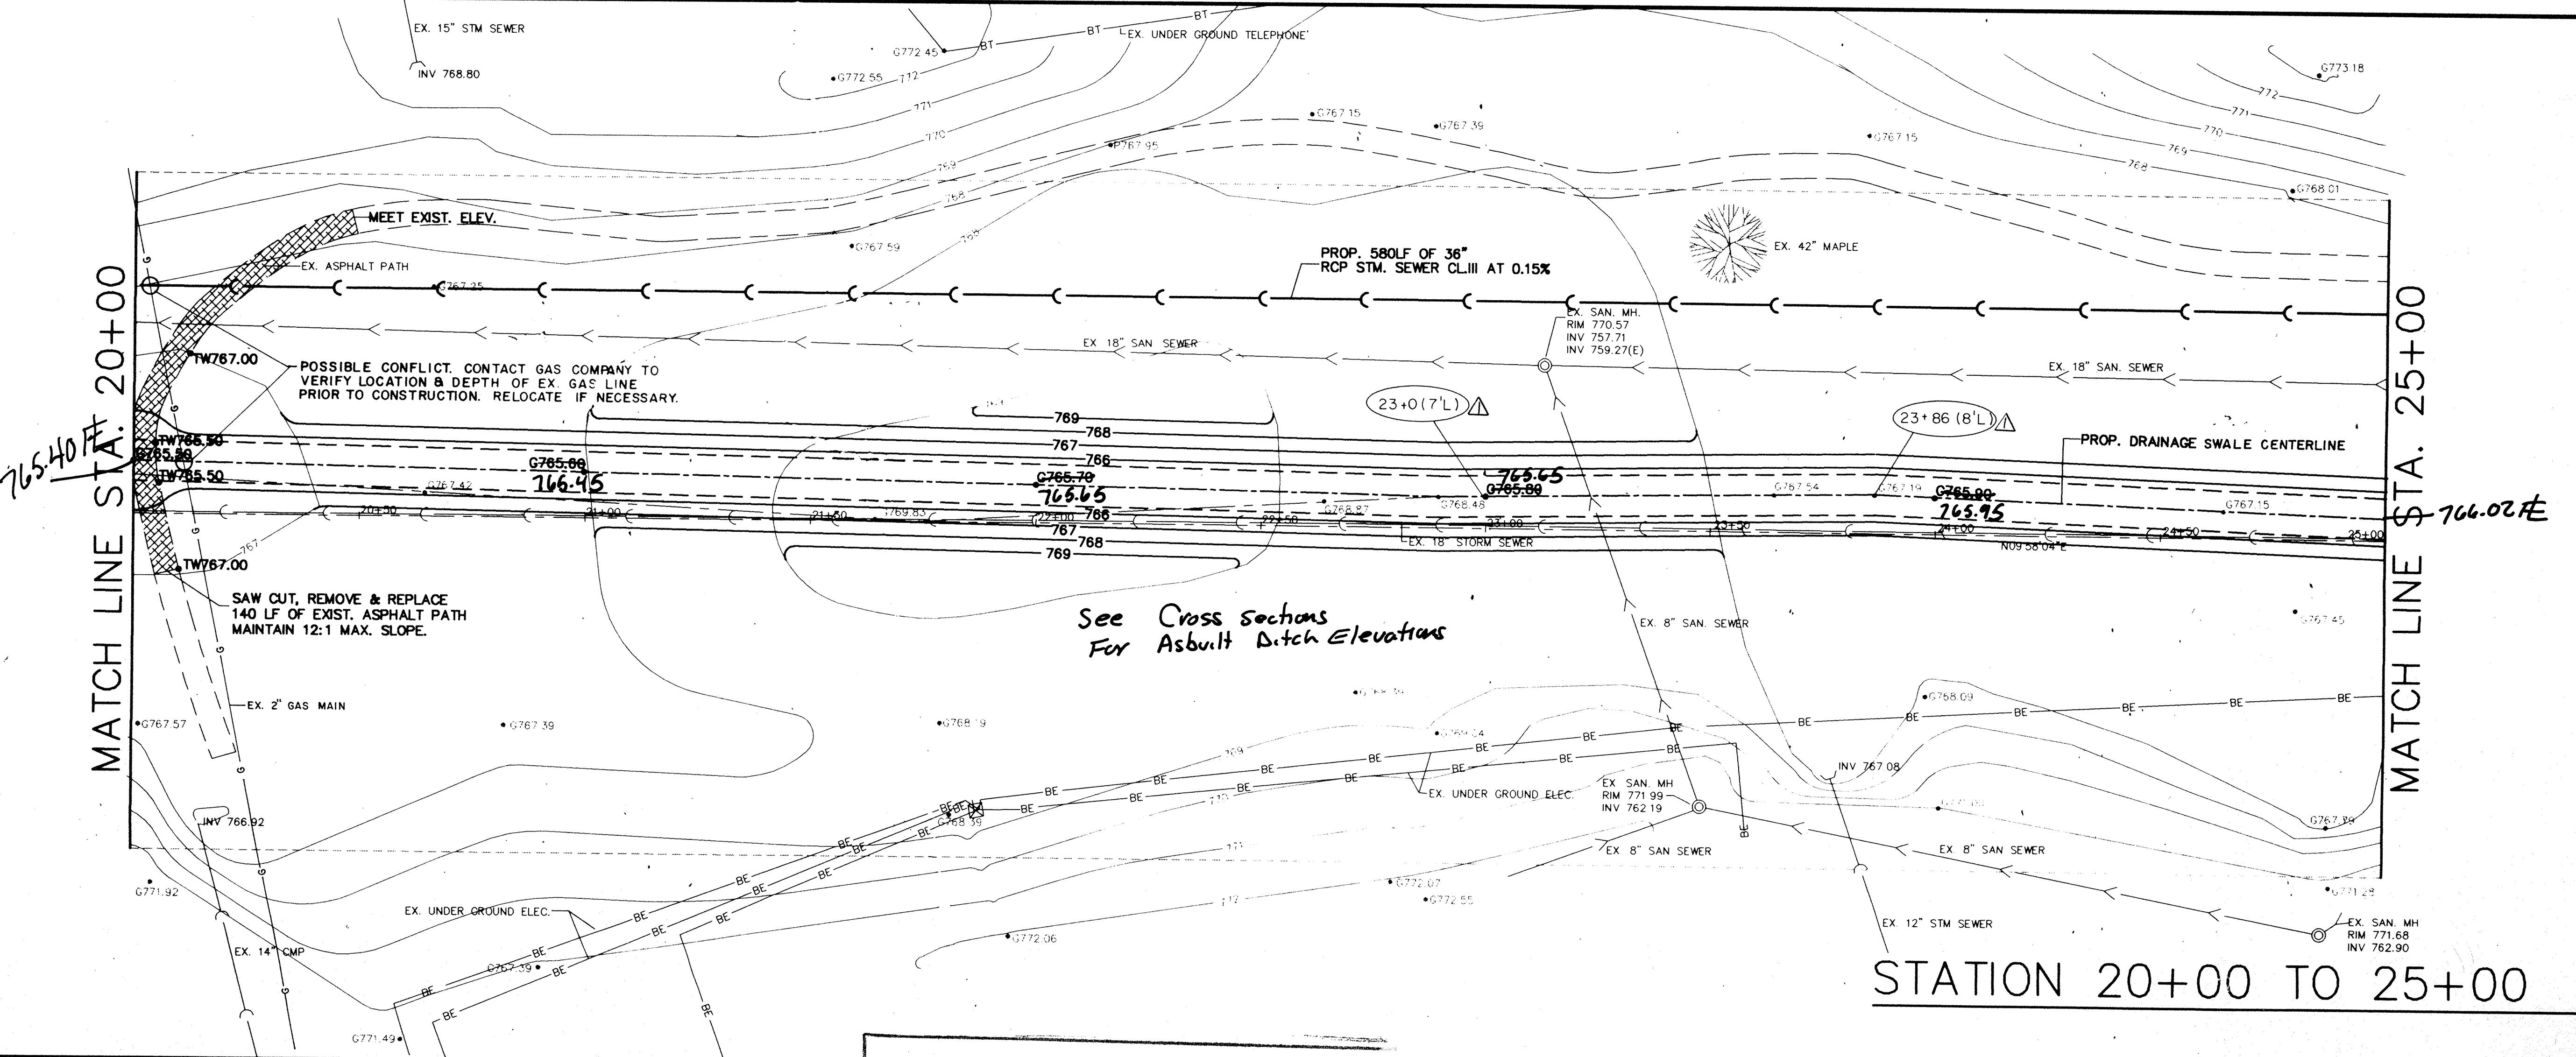

This information was gathered for input into the Hamilton County Geographical Information System. This document is considered an official record of the GIS.
 Entry Date: 7-20-97
 Entered by: [Signature]

MATCH LINE STA. 20+00

This copy is from the Digital Archive of the Hamilton County Surveyor's Office - Noblesville, IN 46060

20

EXIST. GROUND OVER

36"

STORM SEWER

PROPOSED

577.3

PROP. 36" RCP

STM. SEWER CL.III AT 0.15%

PROPOSED DRAINAGE SWALE CENTERLINE

EX 18" STM. SEWER

APPROX. LOCATION

EXIST. 8" SAN. SEWER


EX 18" SAN. SEWER

MATCH LINE STA. 25+00

25

marchris/moore associates
of indiana

consulting engineers

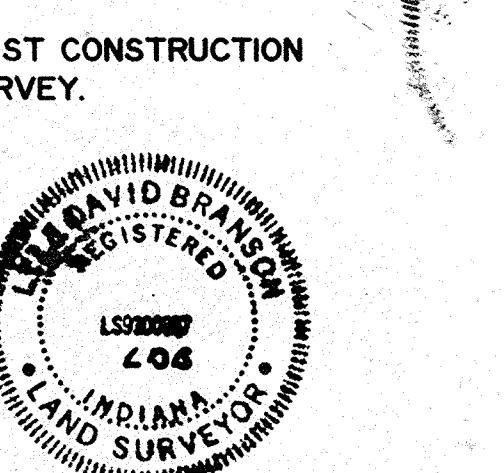9245 North Meridian Street
Suite 105
Indianapolis, IN 46260-1812
(317) 843-2520 FAX 848-2765FILED
FEB 19 1997
OFFICE OF HAMILTON COUNTY SURVEYOR

TITLE:
PLAN AND PROFILE
 STATION 20+00 TO
 STATION 25+00


DATE 7-22-93 SHEET NO.

SCALE 1"-20' (HORIZ)
1"-2' (VERT)

JOB NO. 93-011

DRAWN BY S.WEBER

6 of 20

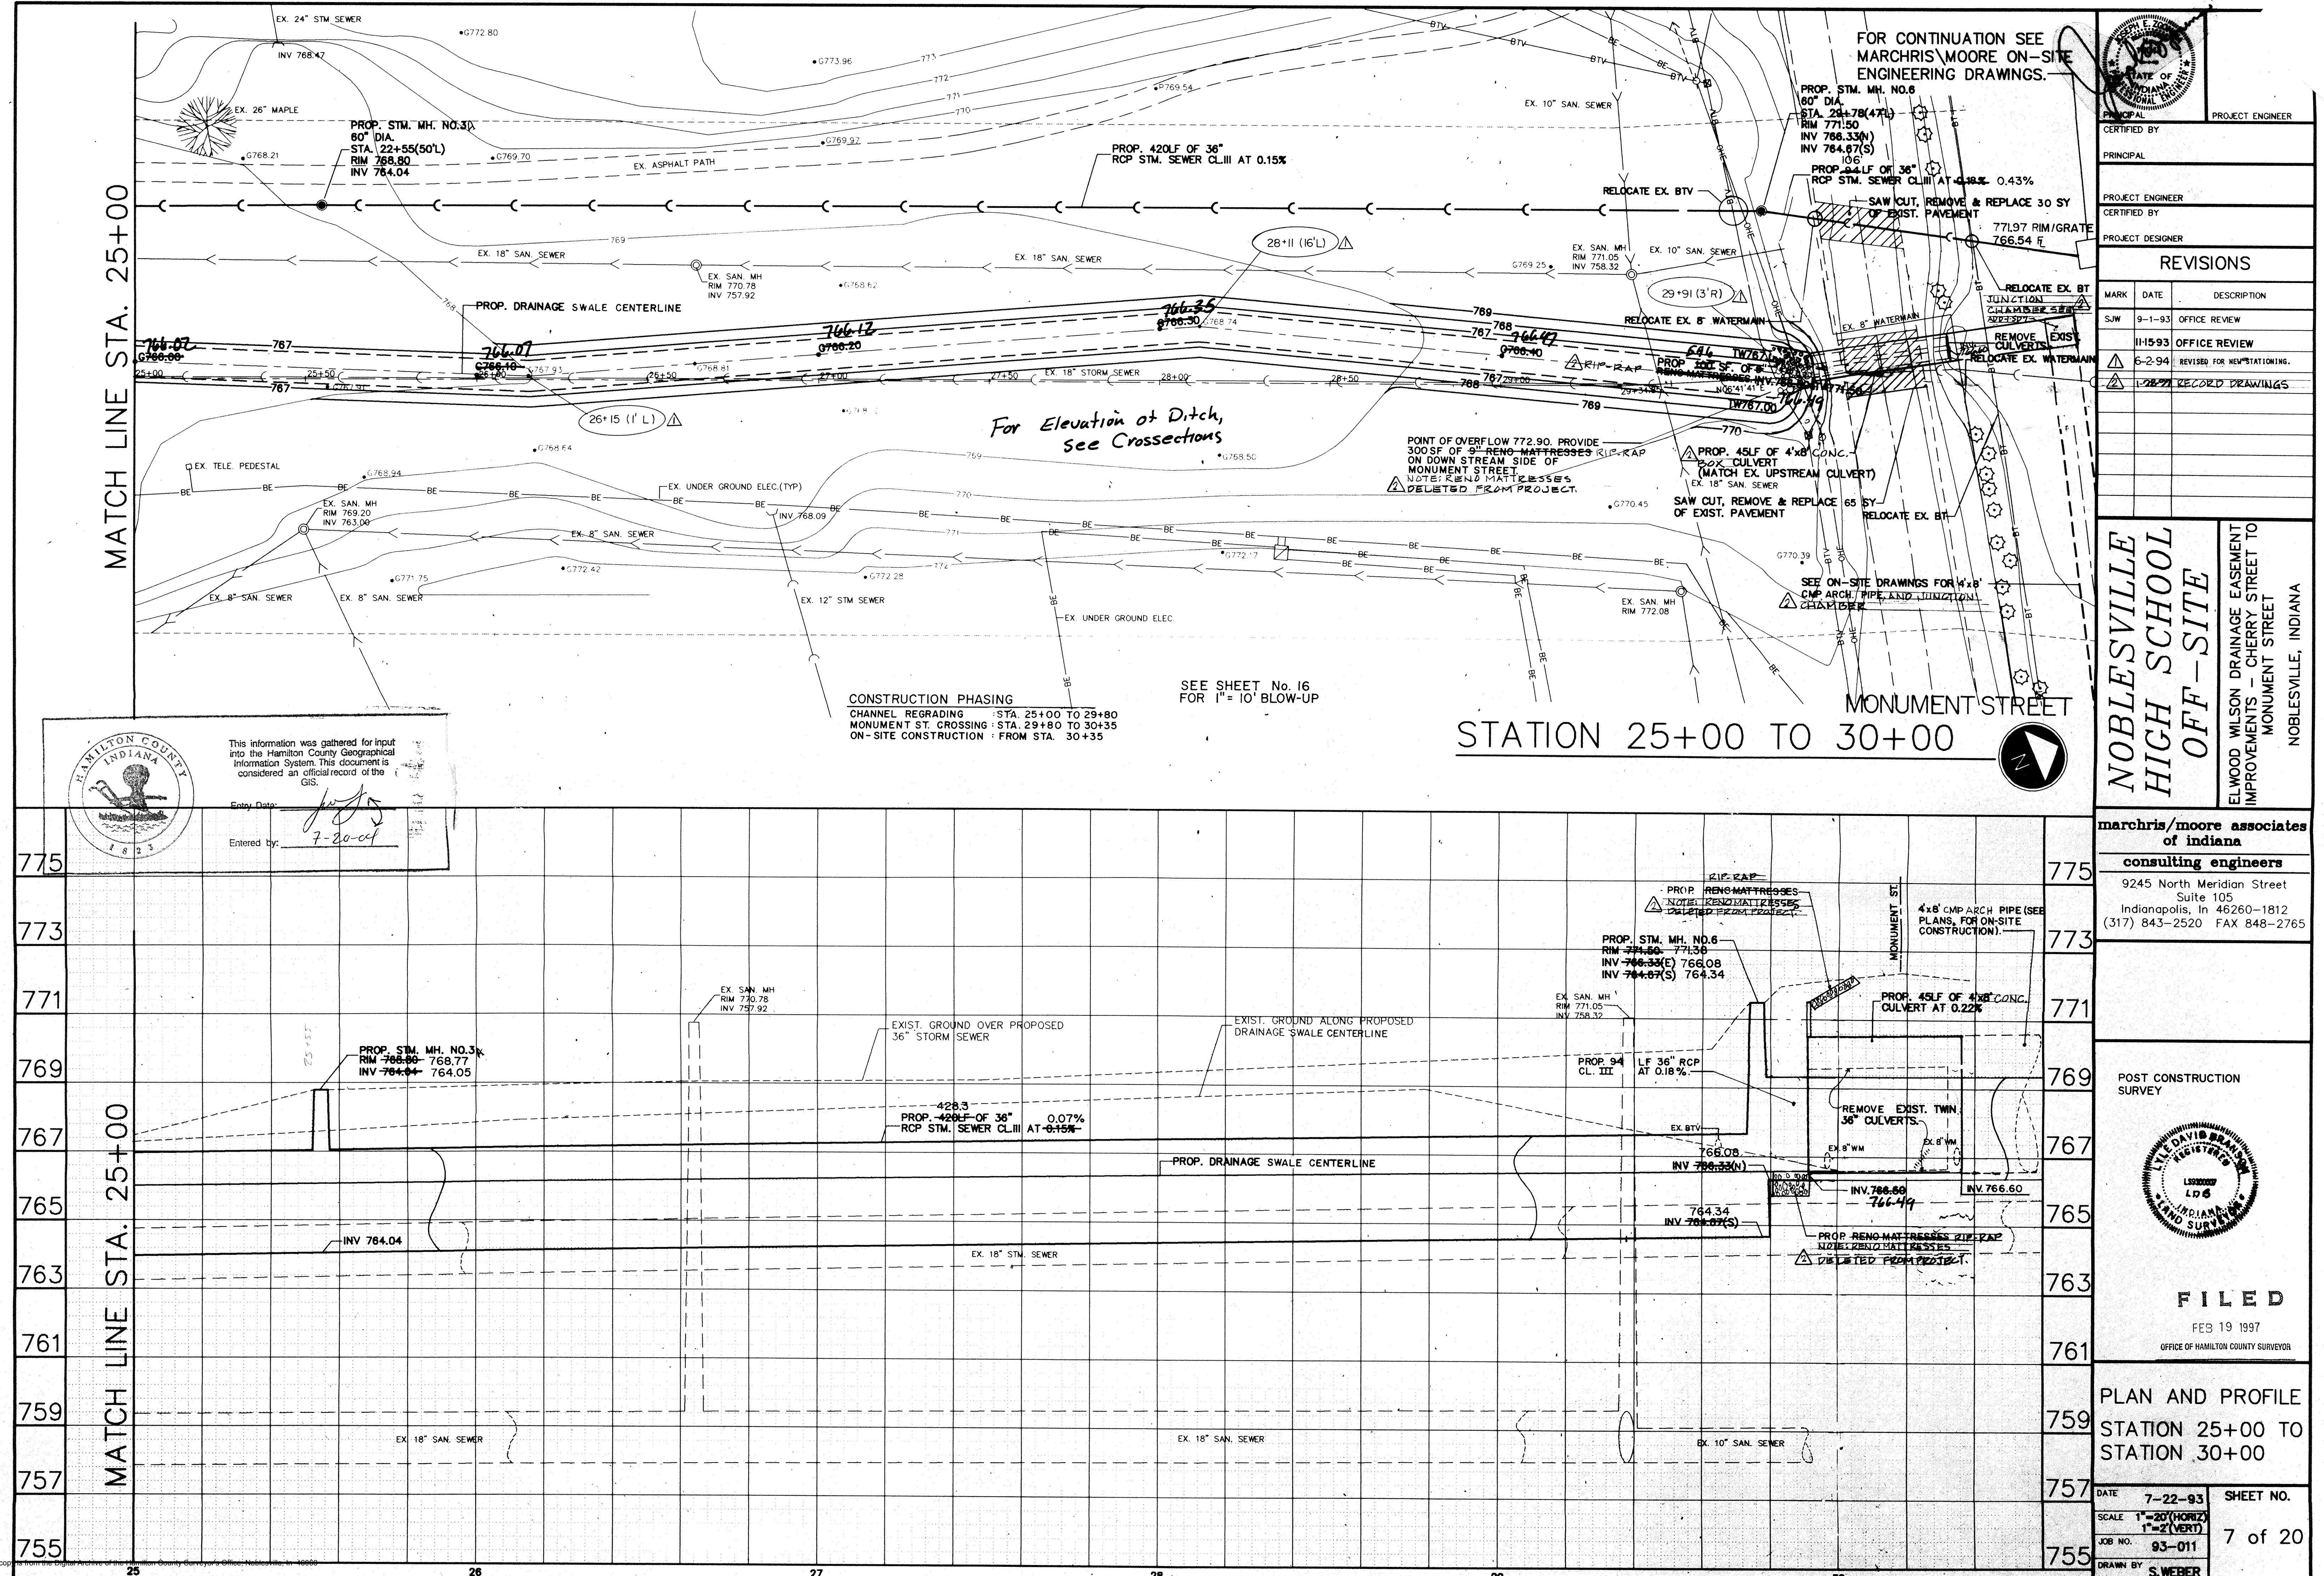












This copy is from the Digital Archive of the Hamilton County Surveyor's Office, Noblesville, IN 10000.

		PROJECT ENGINEER
PRINCIPAL CERTIFIED BY		
PRINCIPAL		
PROJECT ENGINEER CERTIFIED BY		
PROJECT DESIGNER		
REVISIONS		
MARK	DATE	DESCRIPTION
9-1-93		PER-OFFICE REVIEW
11-15-93		OFFICE REVIEW
1-26-97		RECORD DRAWINGS


NOBLESVILLE HIGH SCHOOL OFF-SITE
ELWOOD WILSON DRAINAGE EASEMENT IMPROVEMENTS - CHERRY STREET TO MONUMENT STREET NOBLESVILLE, INDIANA

marchris/moore associates of indiana consulting engineers
9245 North Meridian Street Suite 105 Indianapolis, In 46260-1812 (317) 843-2520 FAX 848-2765

FILED
FEB 19 1997
OFFICE OF HAMILTON COUNTY SURVEYOR
TITLE:
CROSS SECTIONS
STATION 0+00 TO STATION 5+00
DATE 7-22-93 SHEET NO.
**SCALE 1"-20'(HORIZ)
1"-4'(VERT)**
JOB NO. 93-011
DRAWN BY S.WEBER
8 of 20

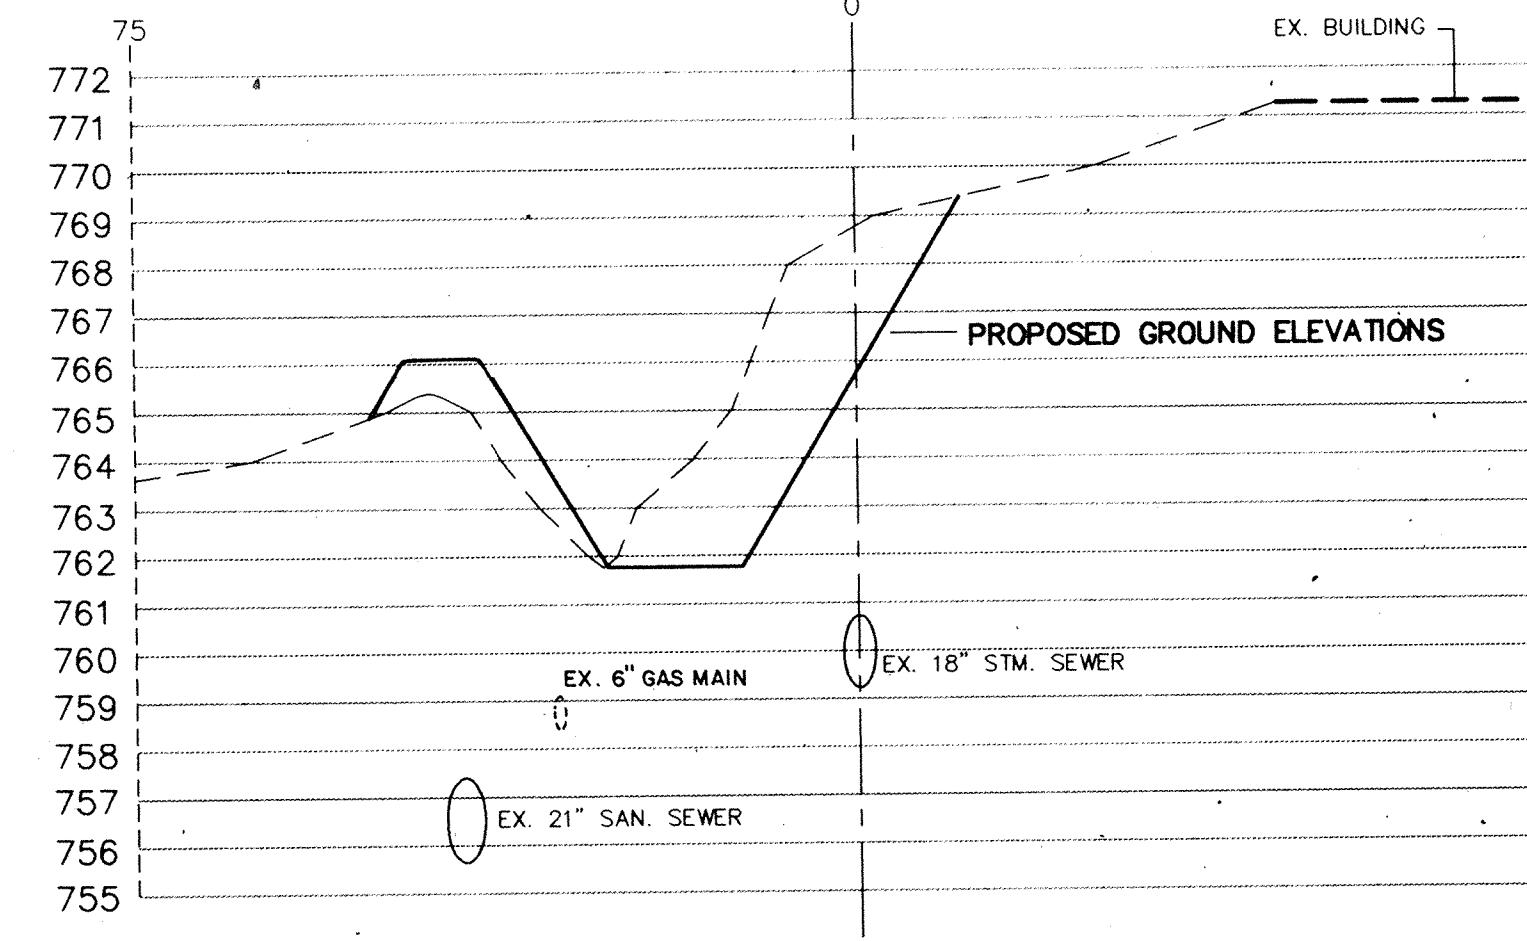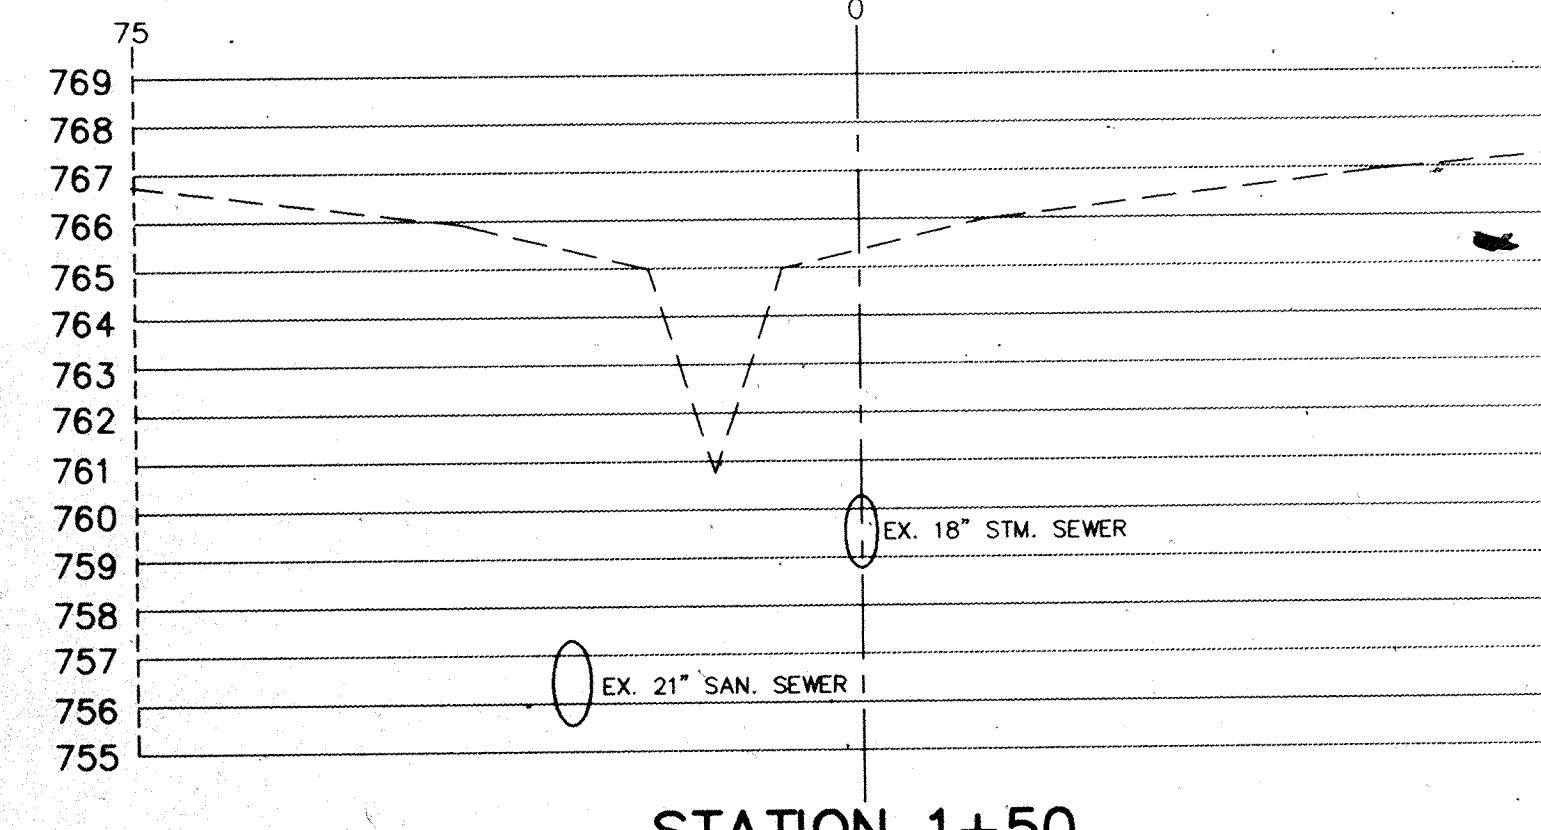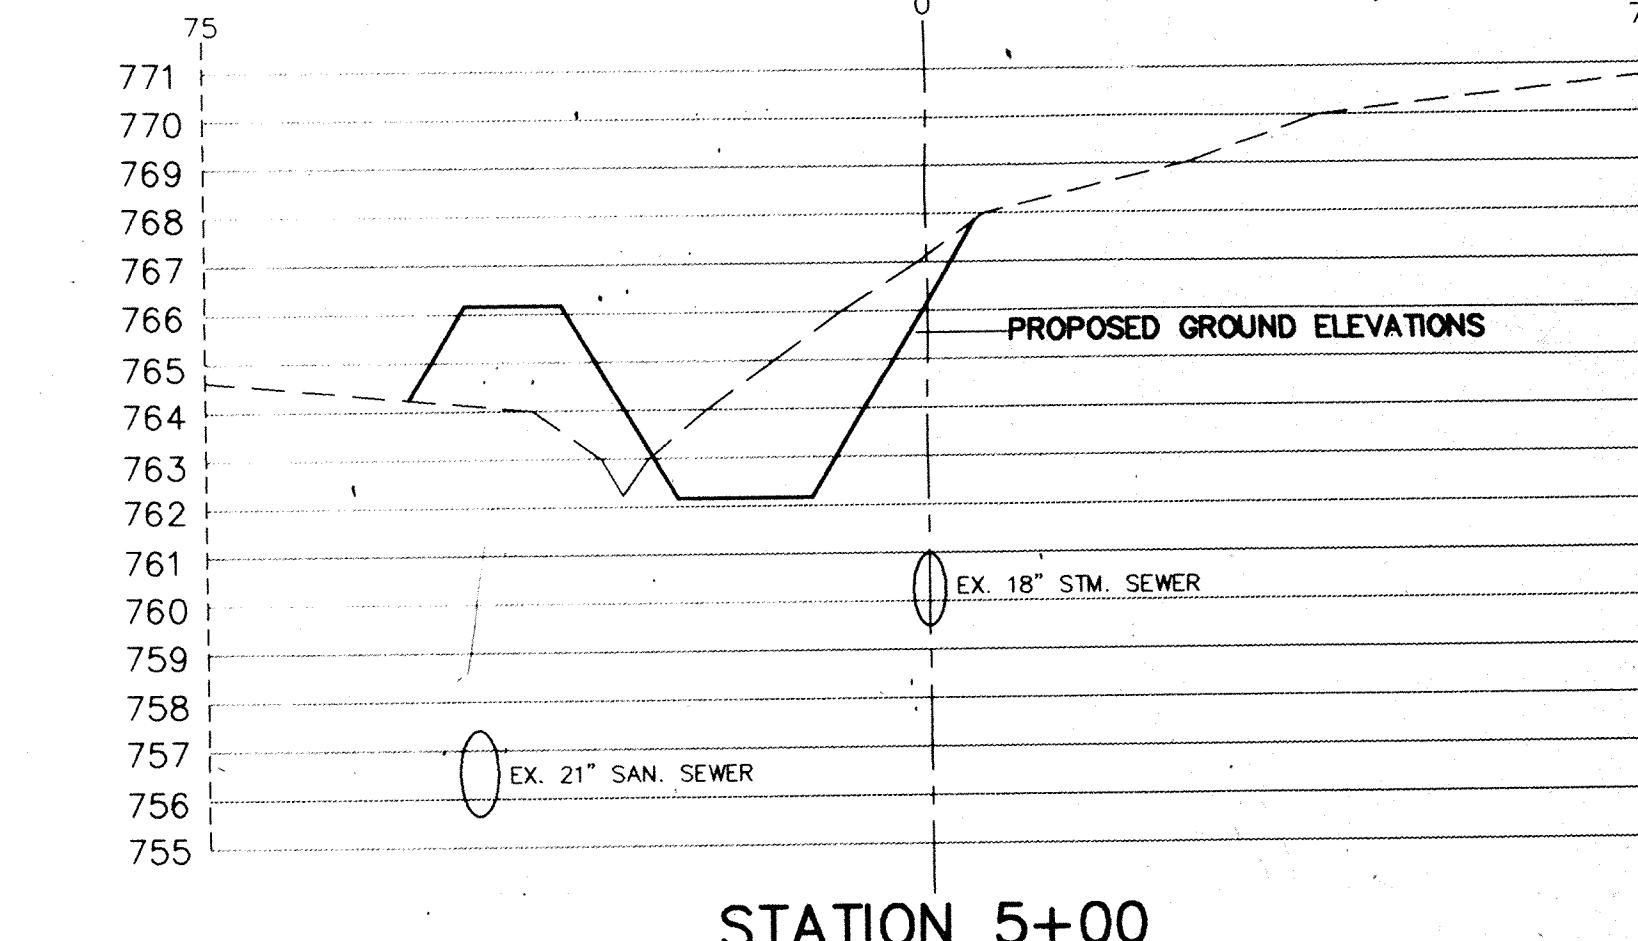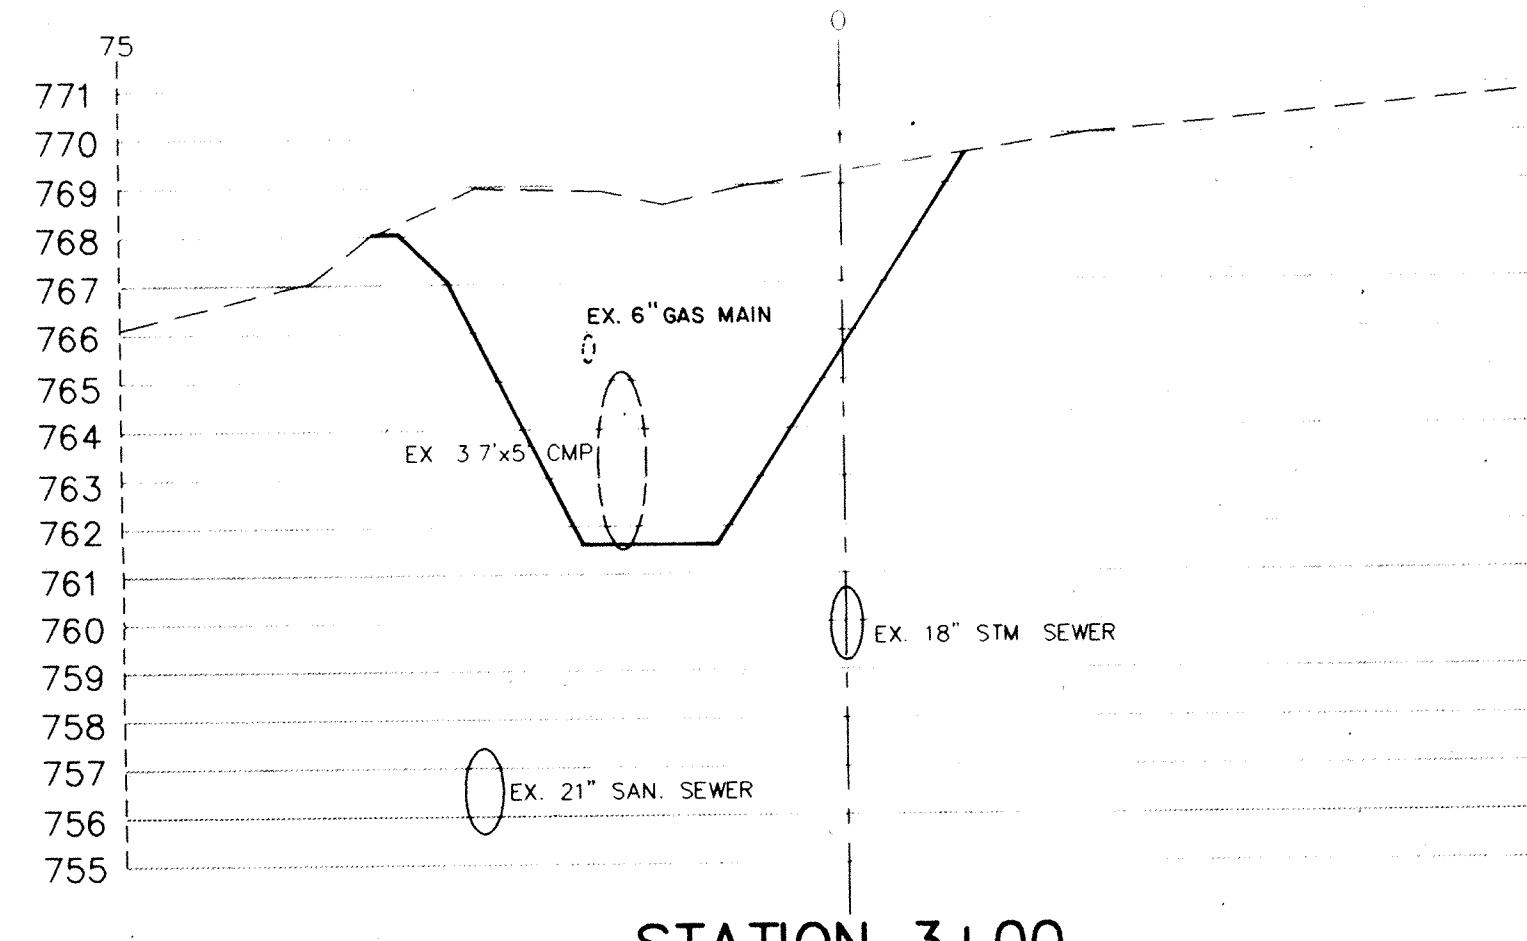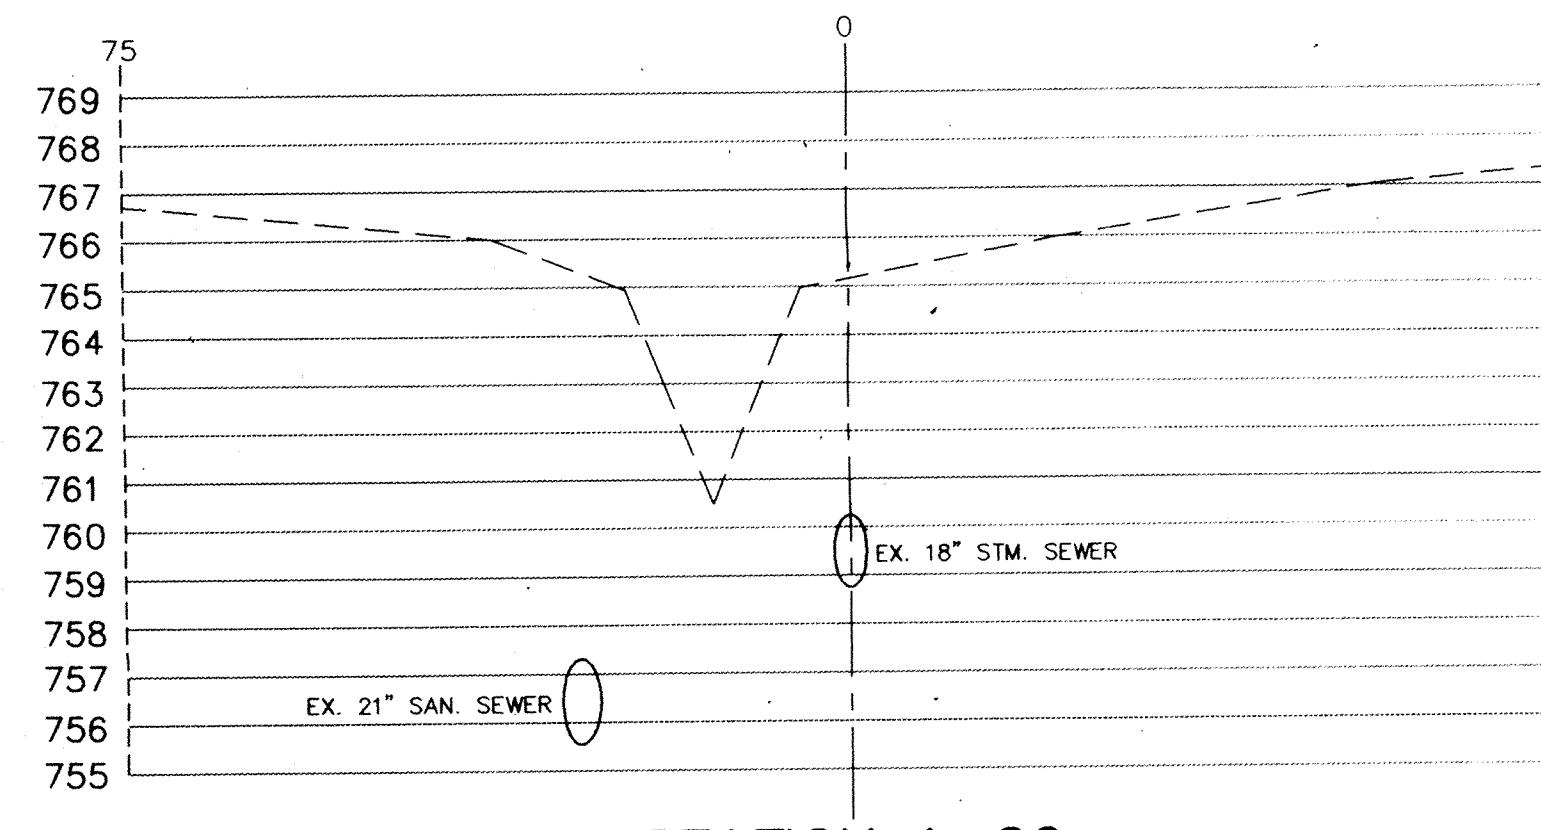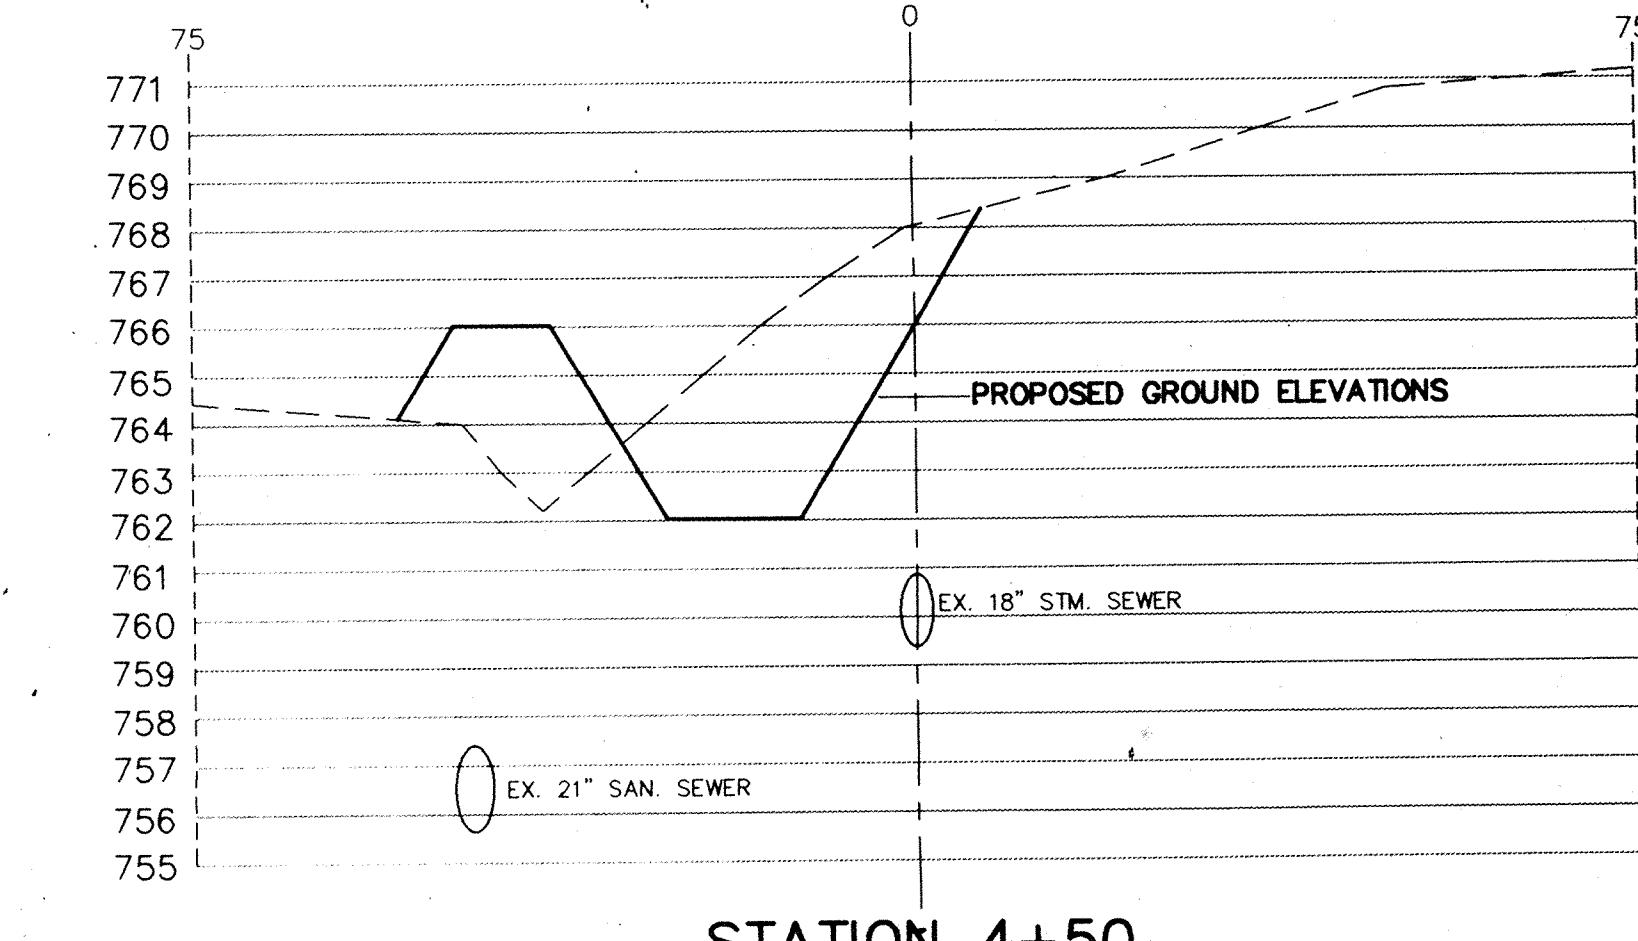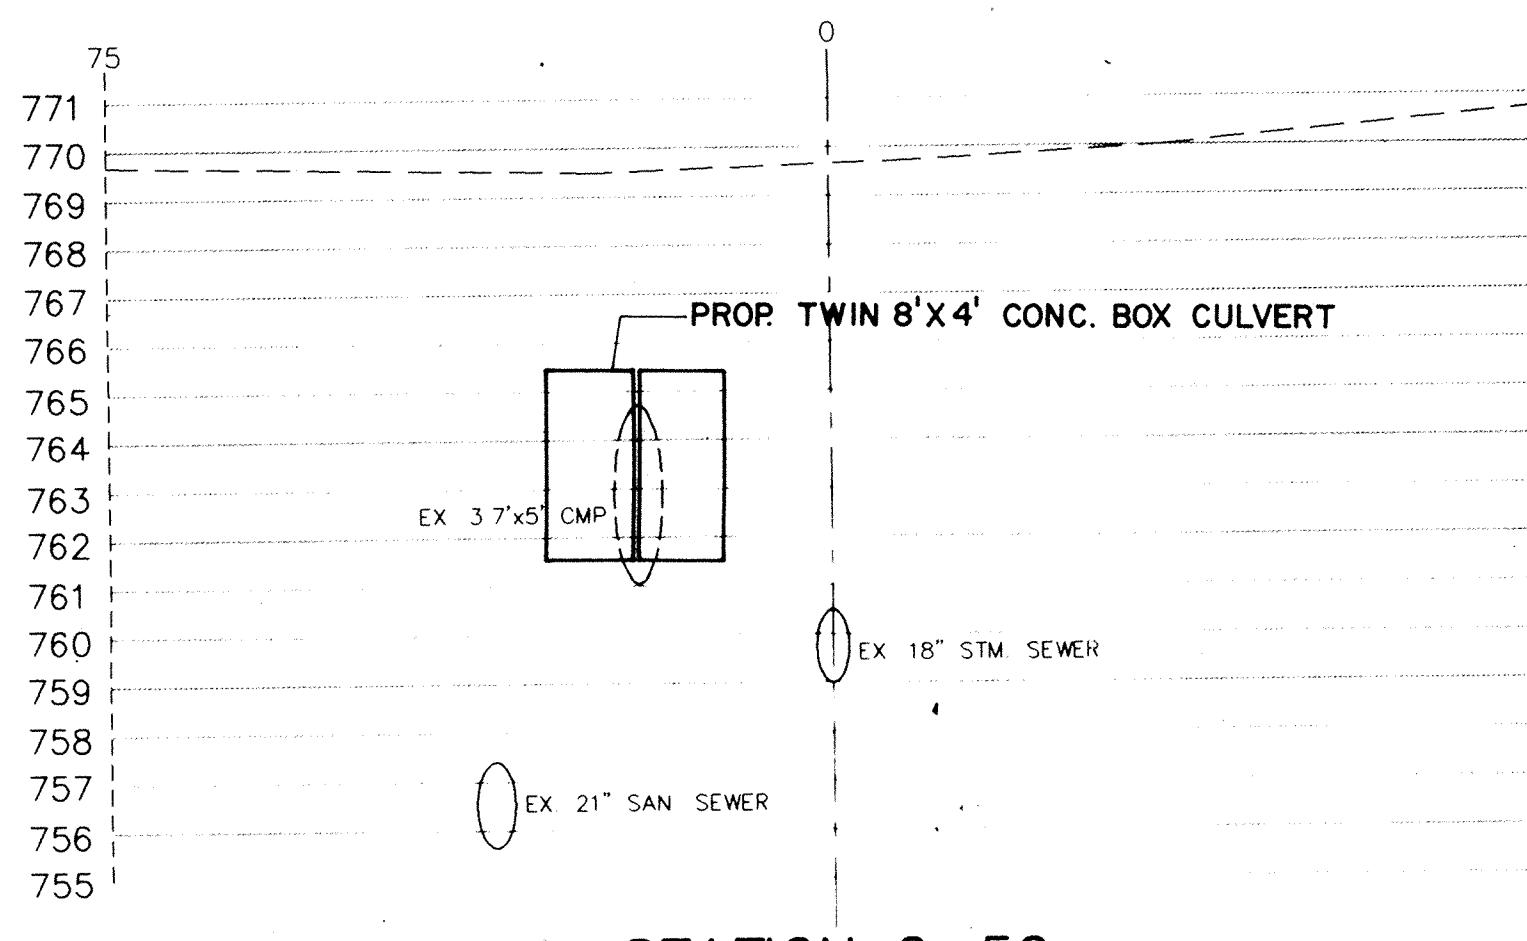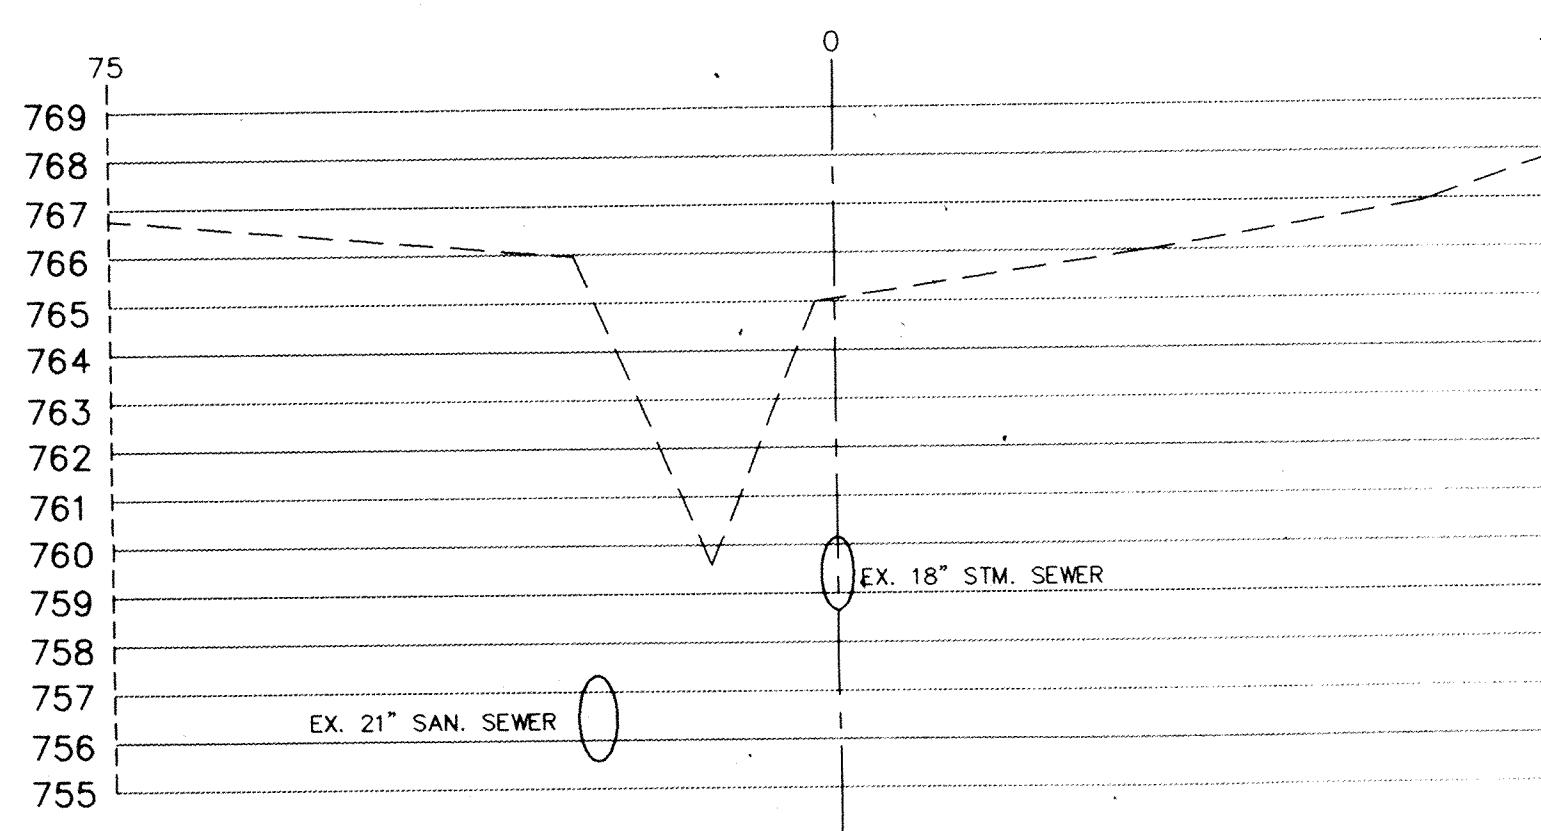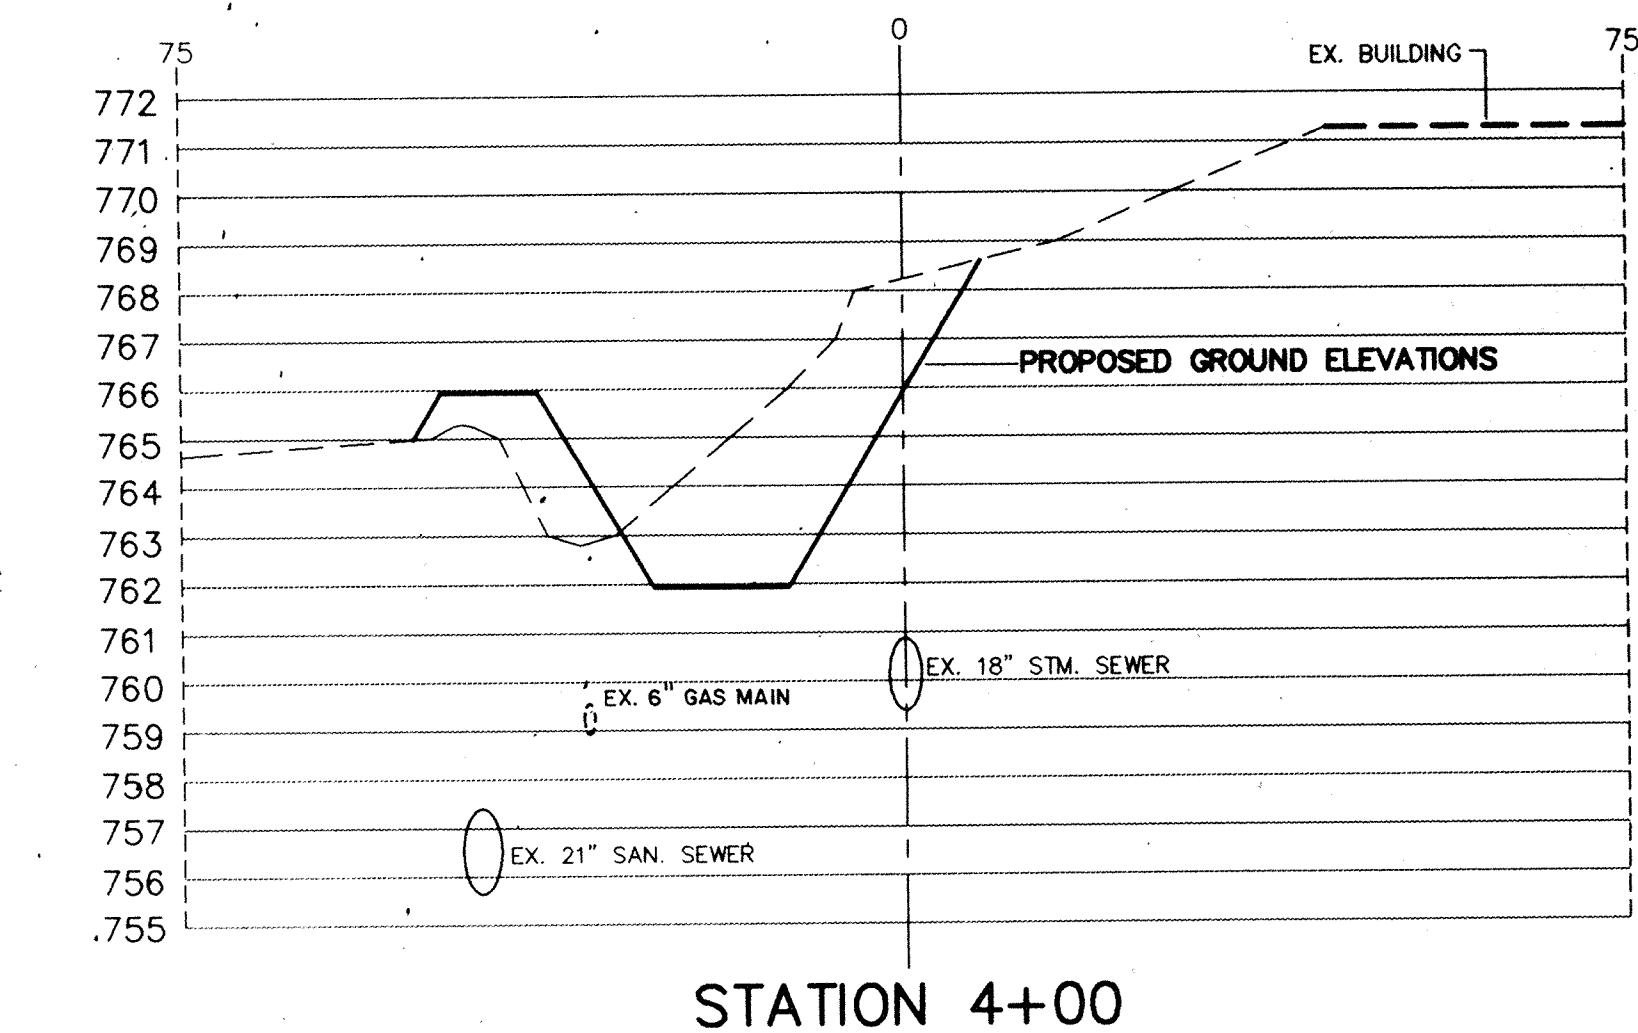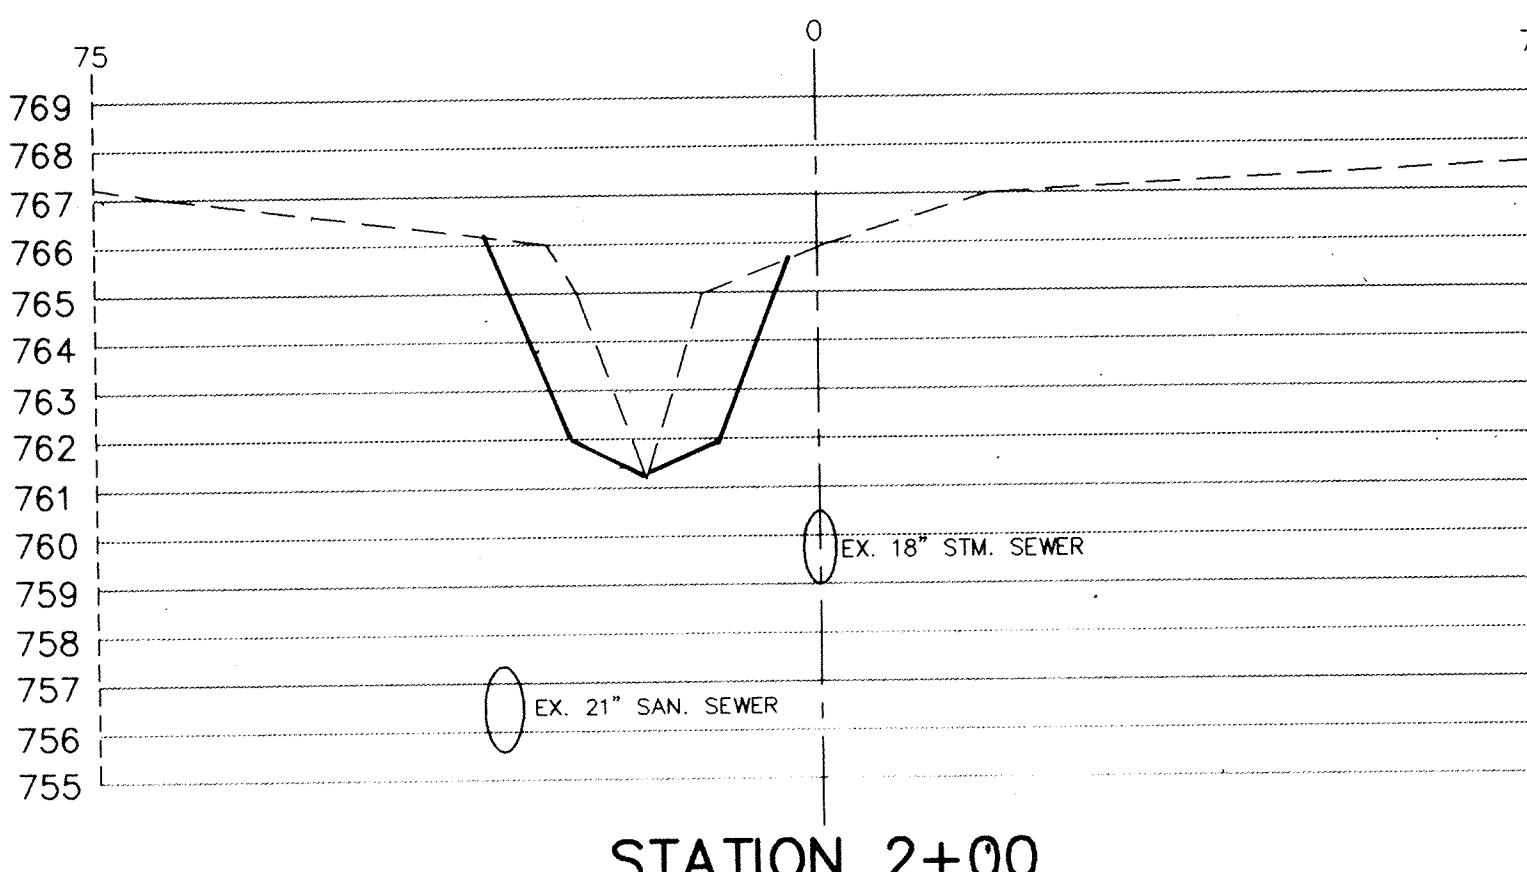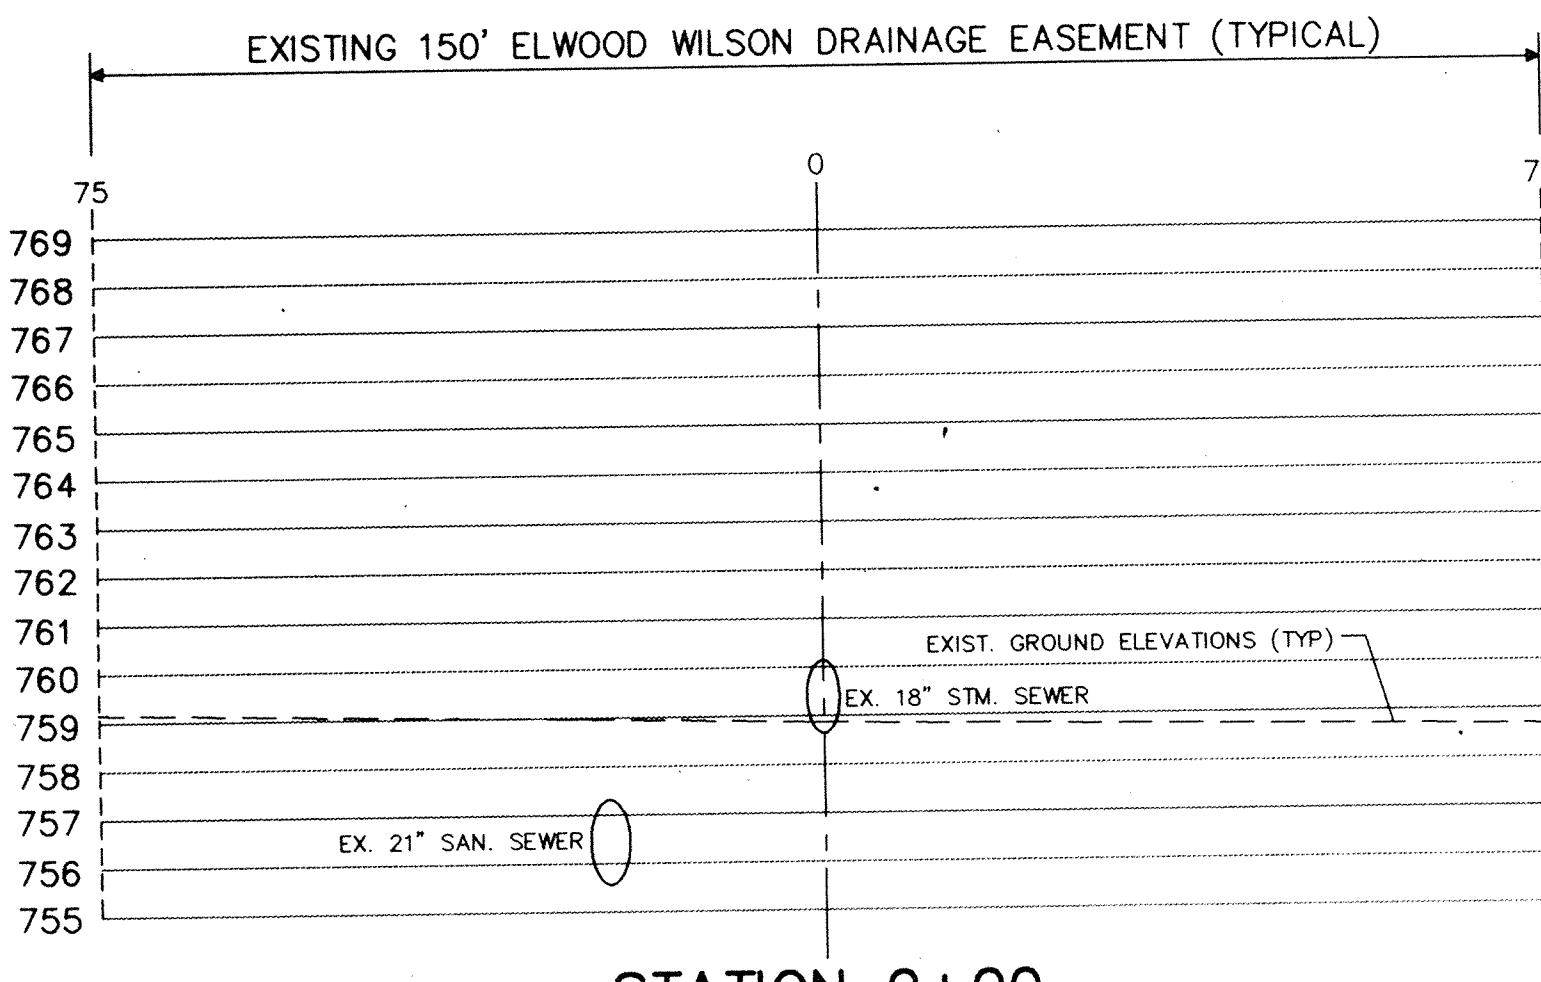

No changes this page

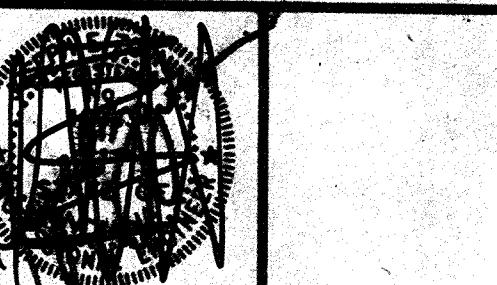

PRINCIPAL

PROJECT ENGINEER

CERTIFIED BY

PRINCIPAL

PROJECT ENGINEER

CERTIFIED BY

PROJECT DESIGNER

REVISIONS

MARK DATE DESCRIPTION

9-1-93 PER OFFICE REVIEW

II-15-93 OFFICE REVIEW

I-28-97 RECORD DRAWINGS

NOBLESVILLE HIGH SCHOOL OFF-SITE
ELWOOD WILSON DRAINAGE EASEMENT IMPROVEMENTS - CHERRY STREET TO MONUMENT STREET
 NOBLESVILLE, INDIANA

marchris/moore associates
of indiana

consulting engineers

9245 North Meridian Street
Suite 105
Indianapolis, In 46260-1812
(317) 843-2520 FAX 848-2765

Post Construction Survey



FILED

FEB 19 1997
OFFICE OF HAMILTON COUNTY SURVEYORTITLE:
CROSS SECTIONS
STATION 5+50 TO
STATION 10+00


DATE 7-22-93 SHEET NO.

SCALE 1"-20'(HORIZ)
1"-4"(VERT)


JOB NO. 93-011

DRAWN BY S.WEBER



9 of 20

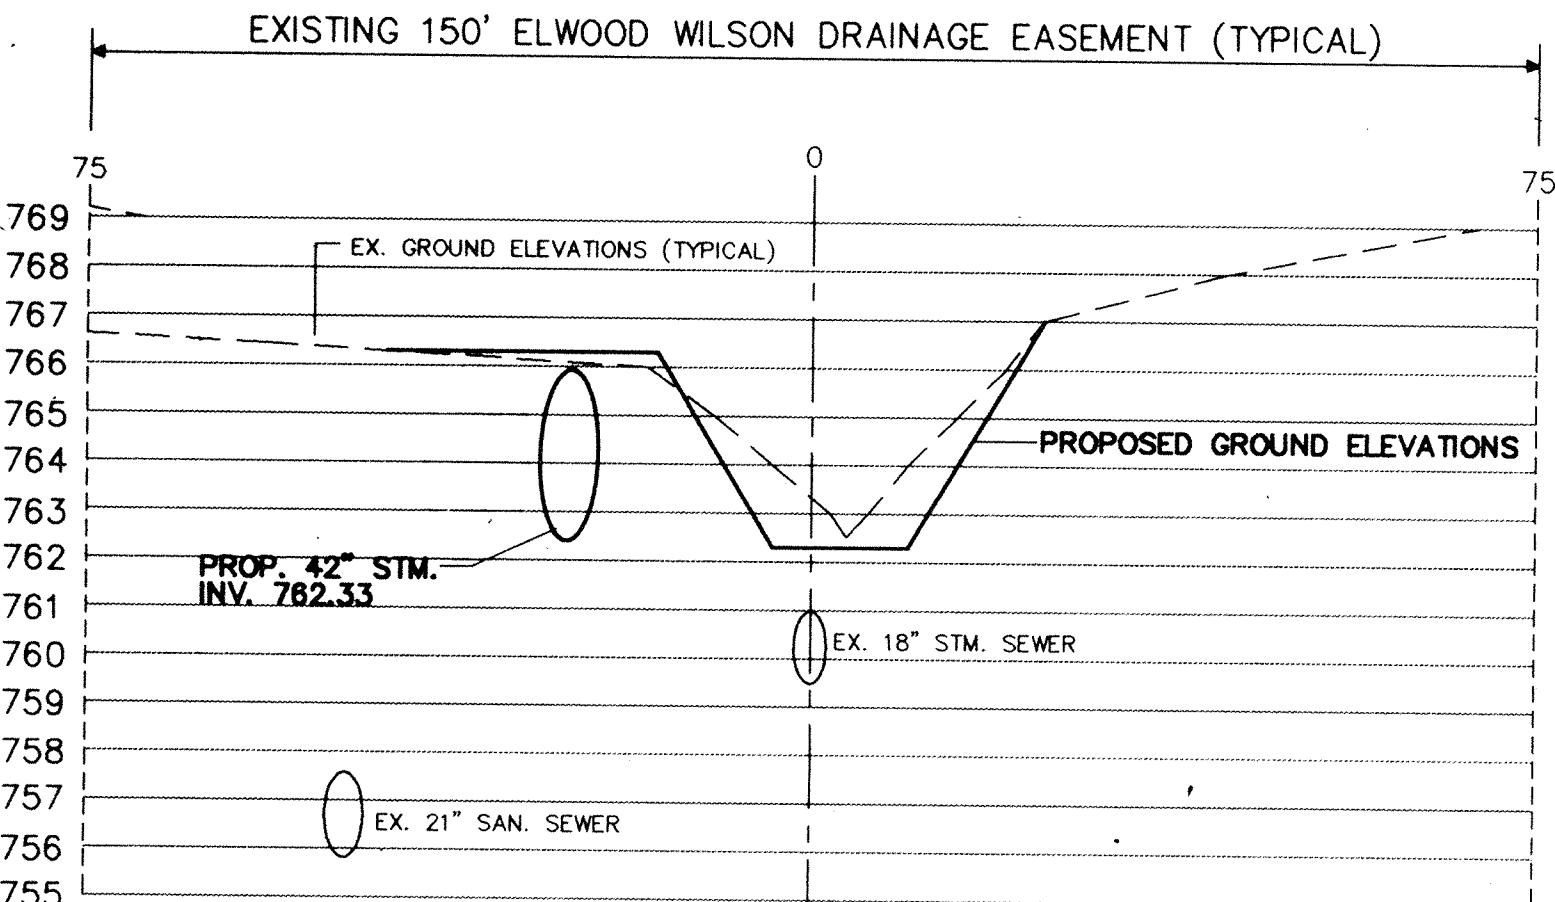


STATION 5+50

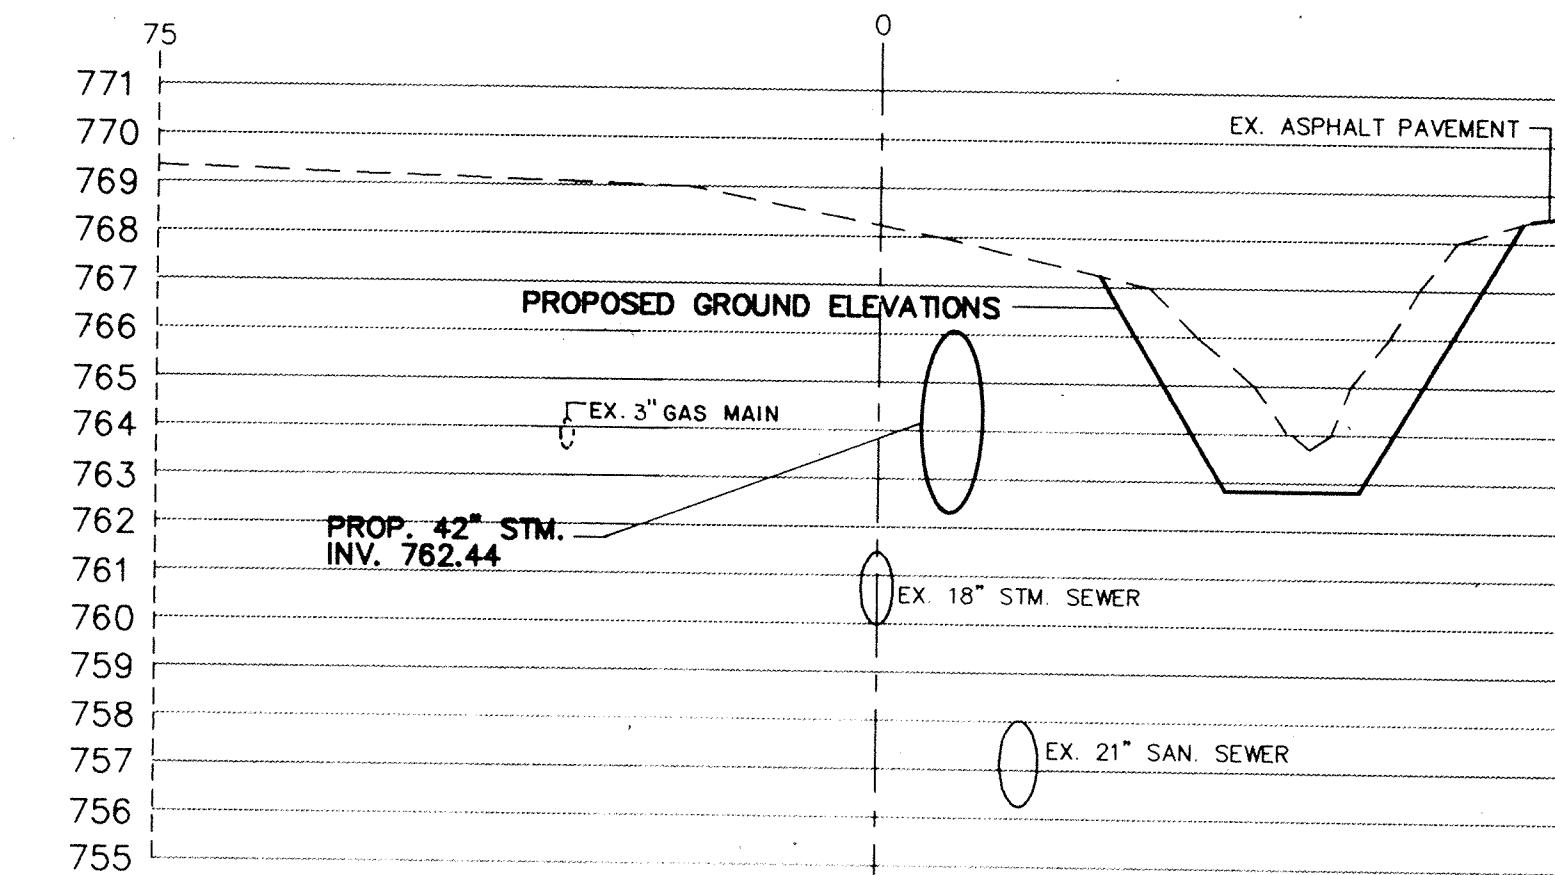


STATION 7+50

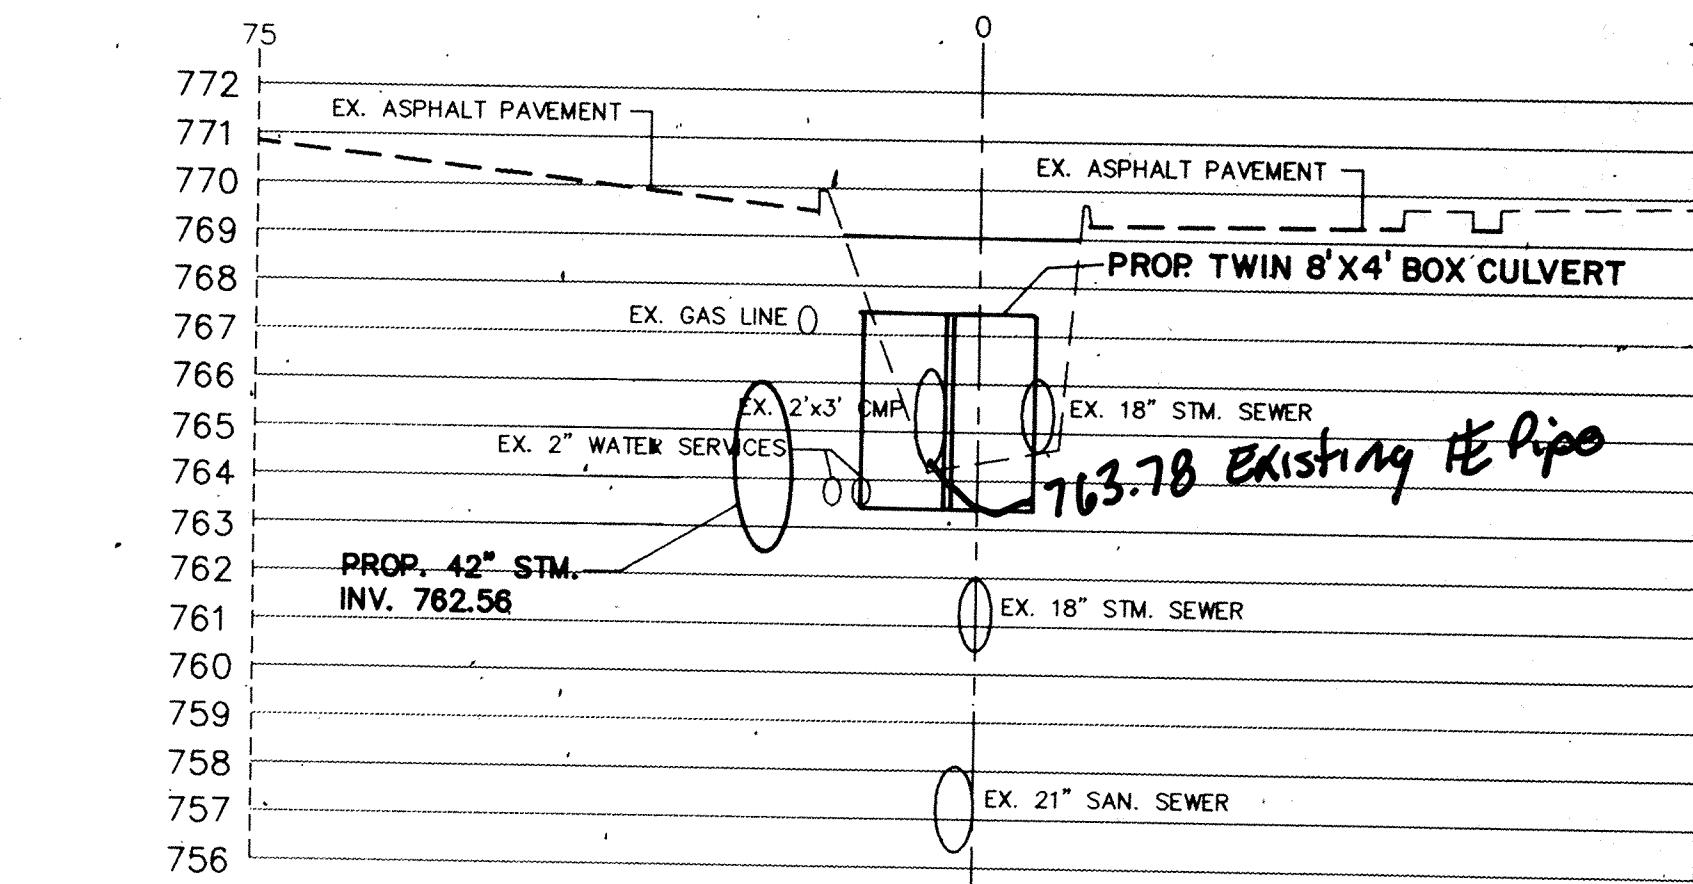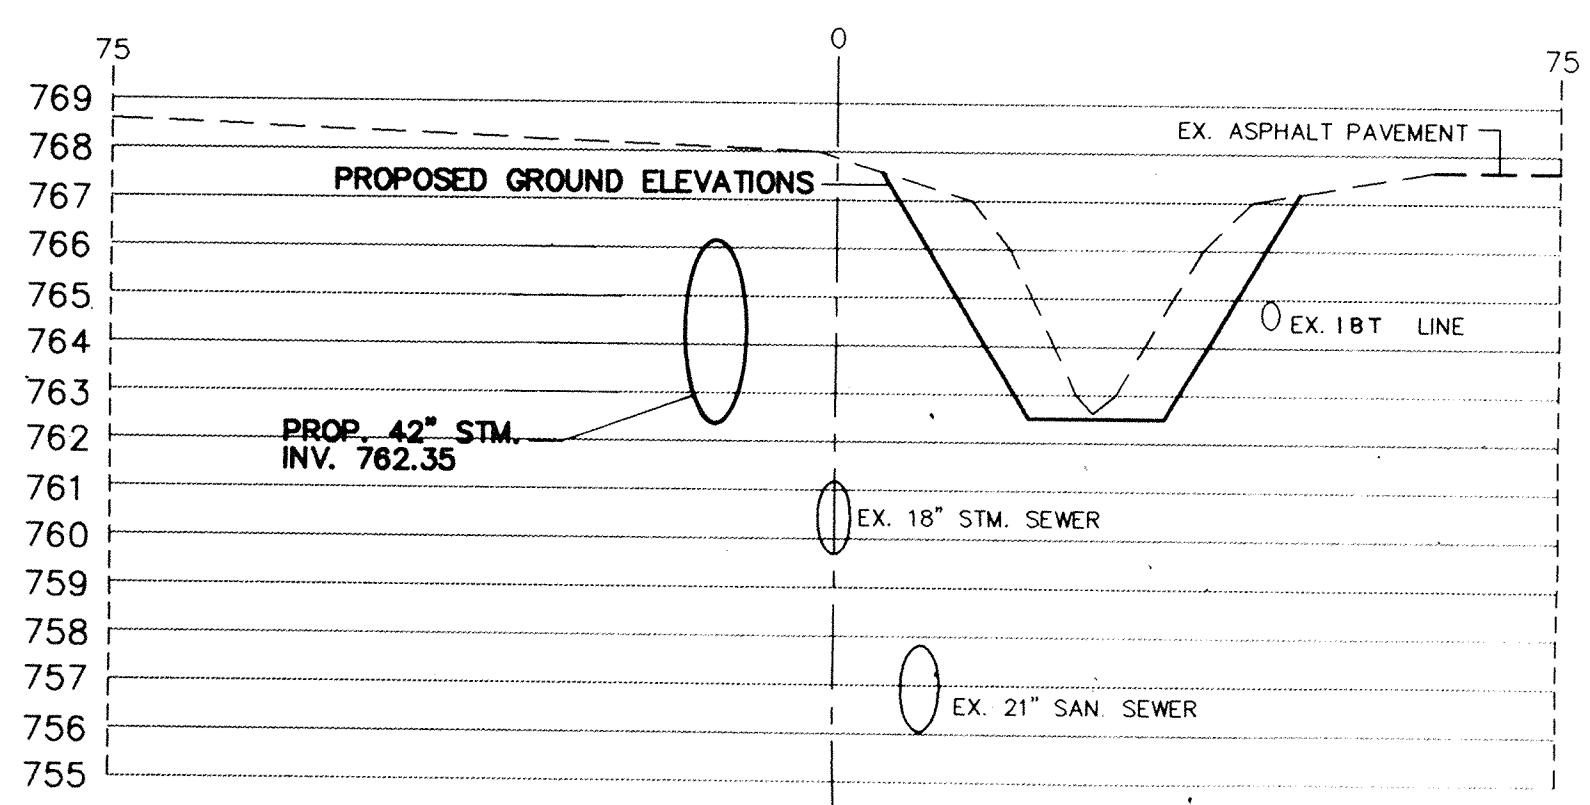STATION 9+50
9+56


STATION 6+00

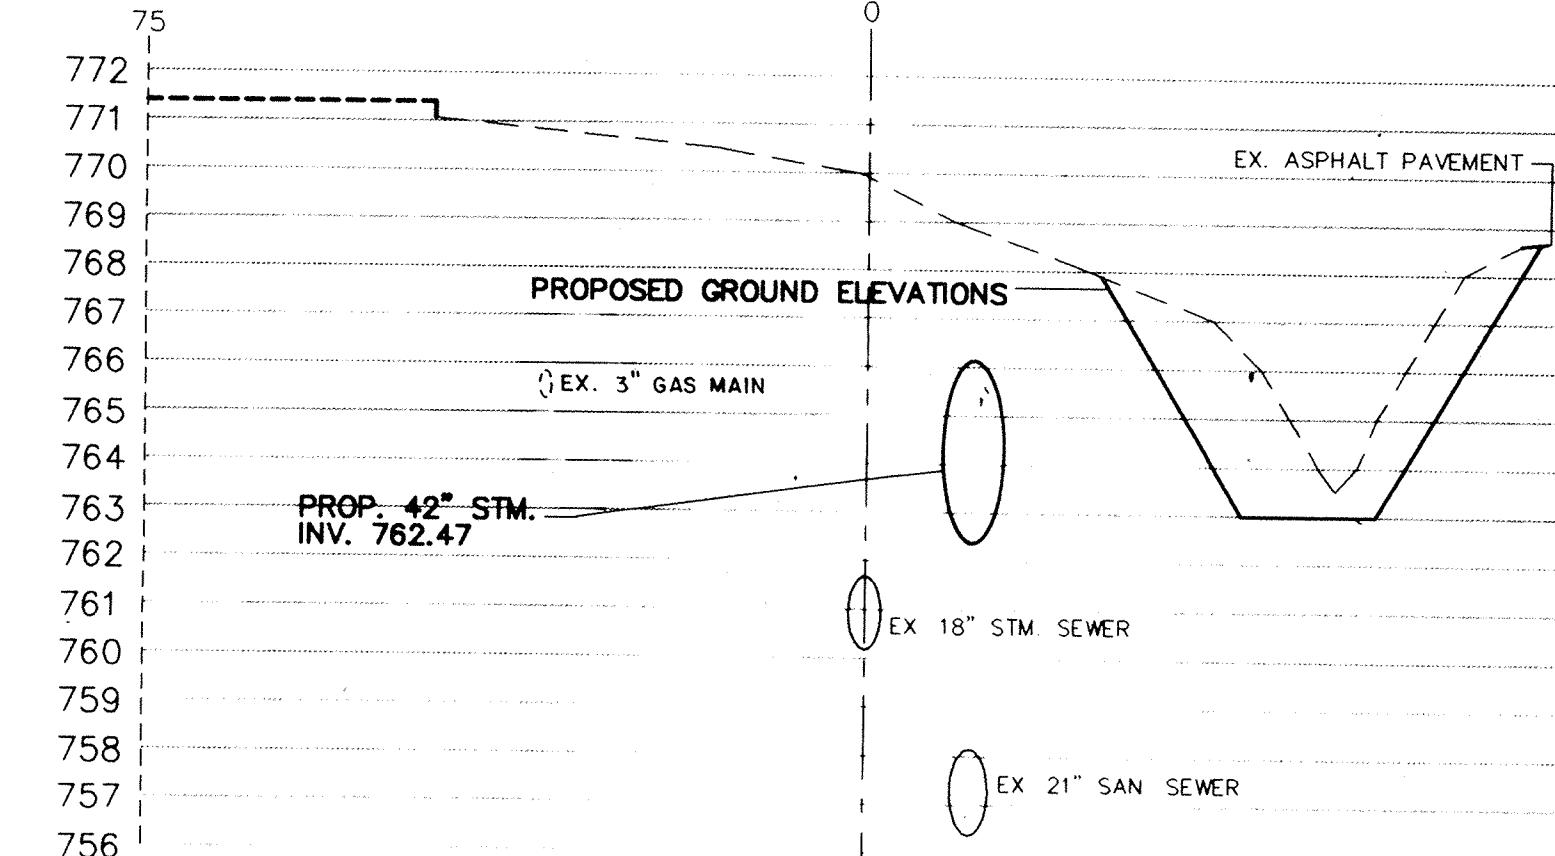


STATION 8+00

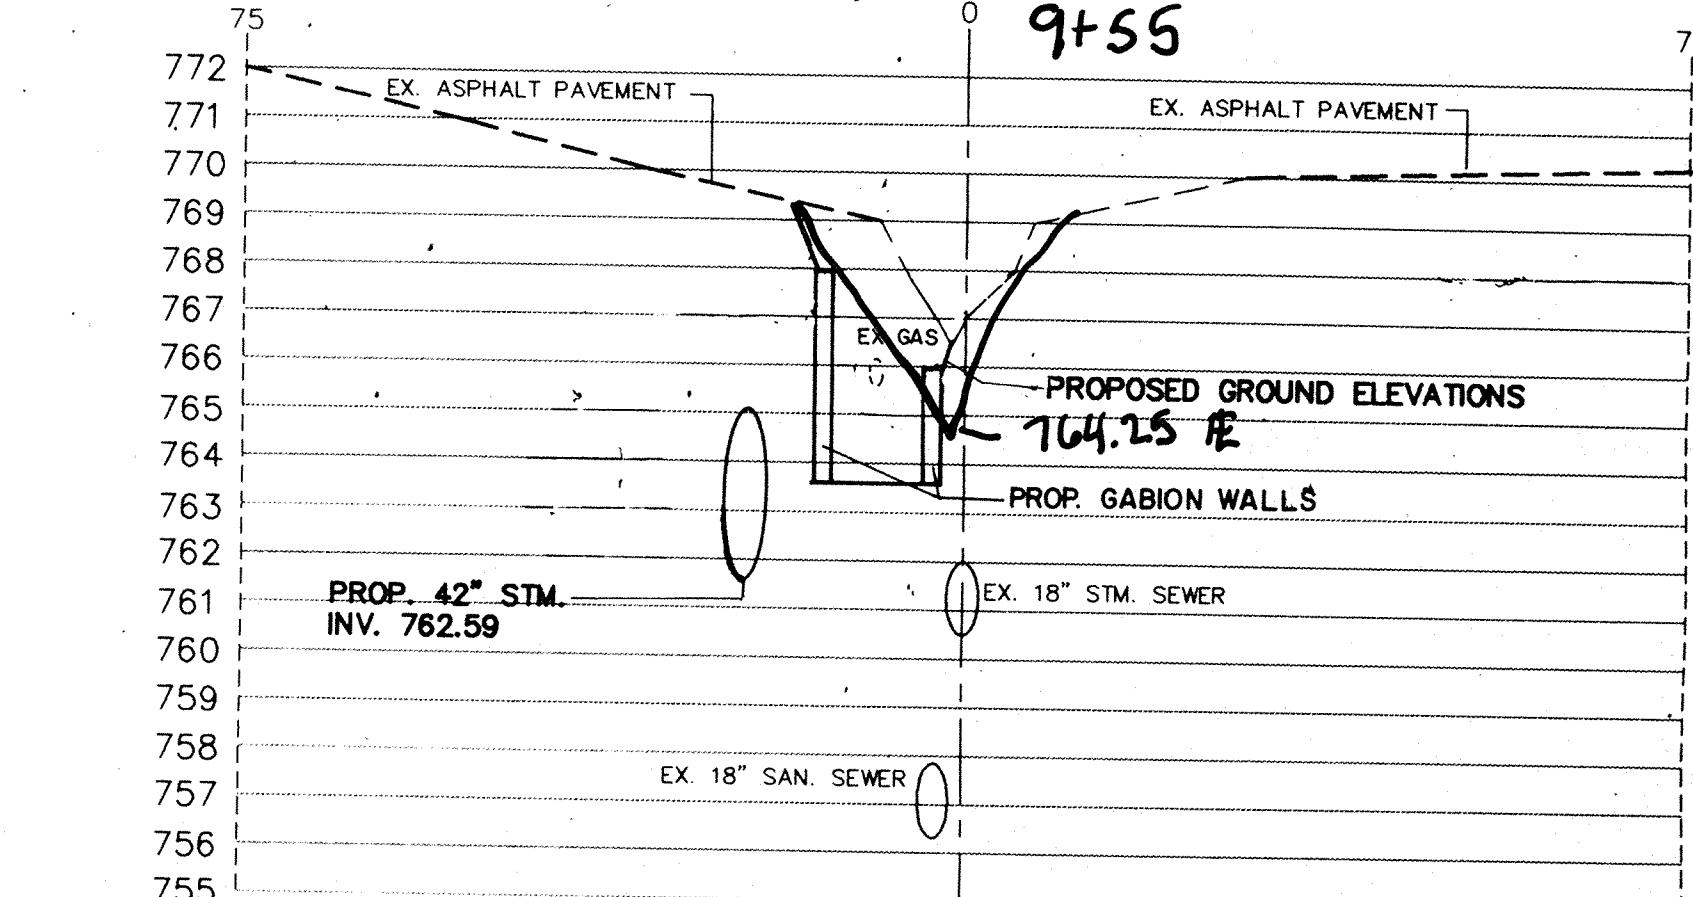


STATION 10+00

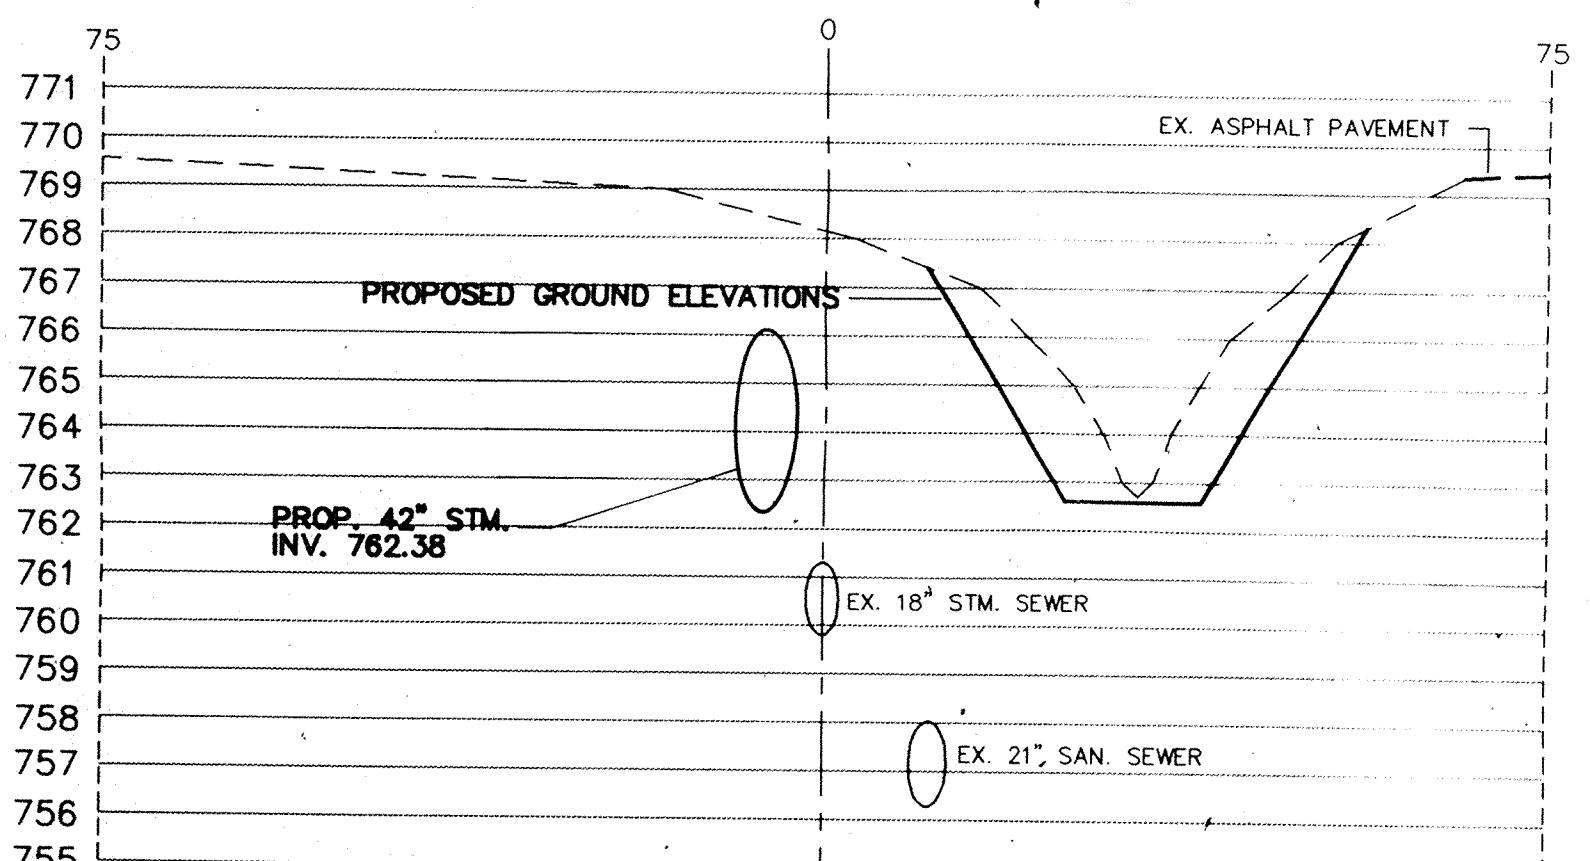


STATION 6+50

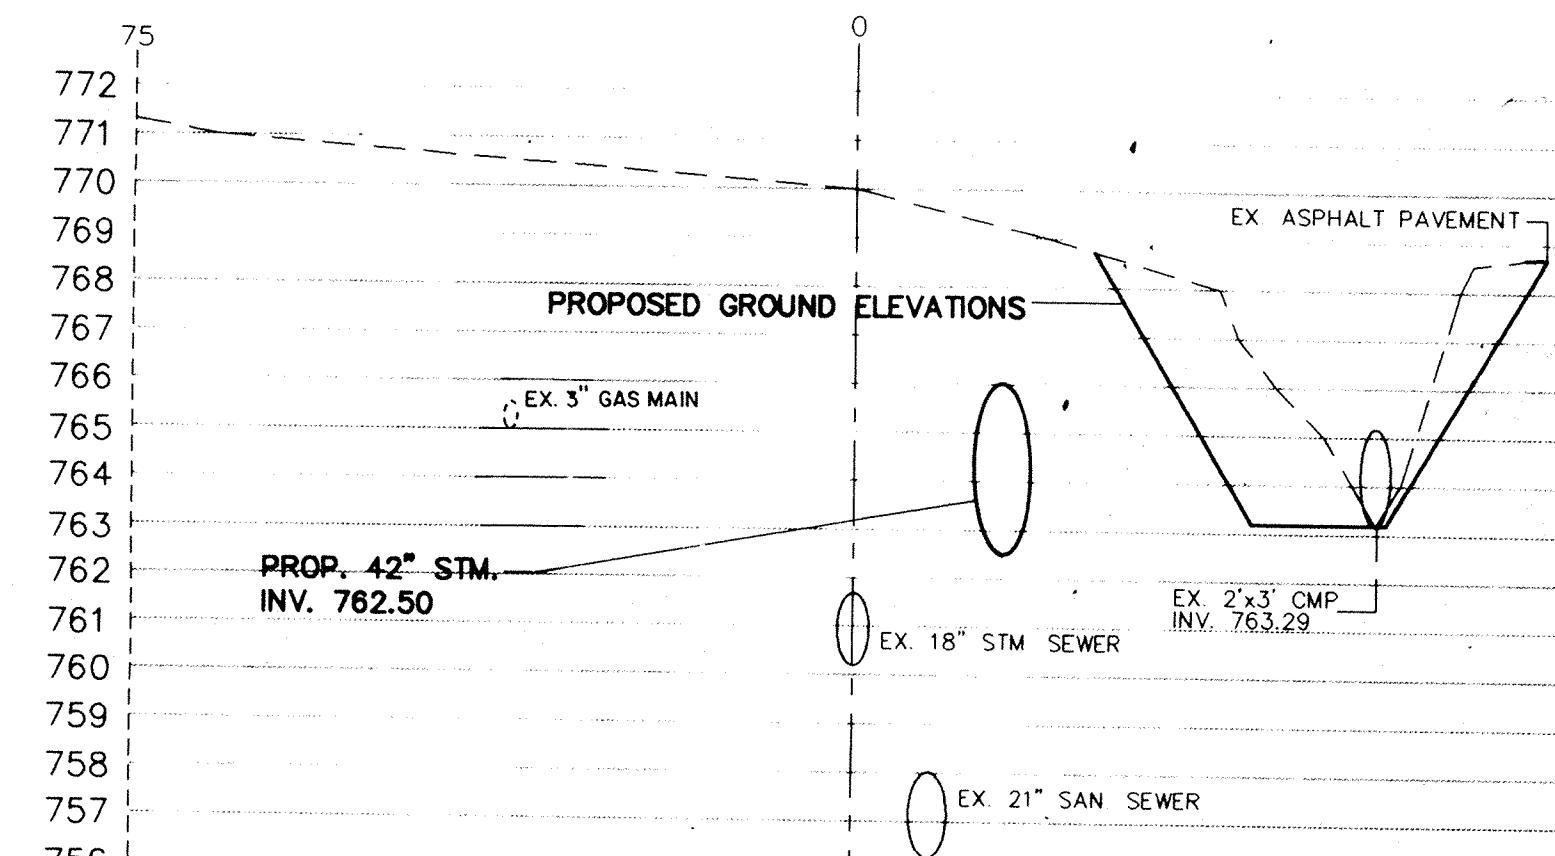

STATION 8+50

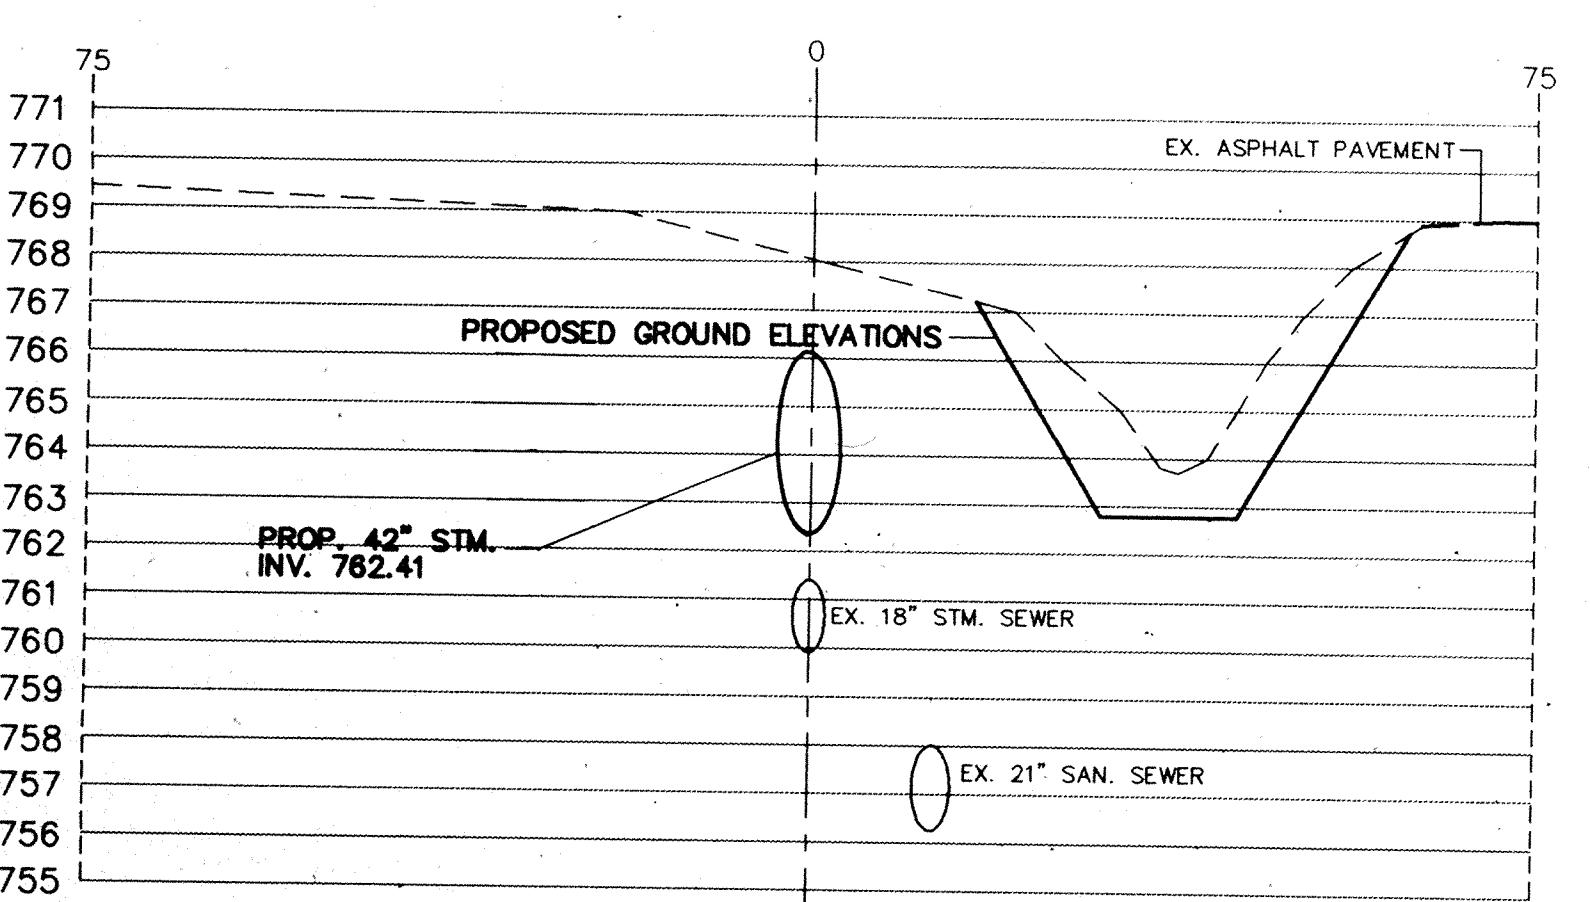

STATION 7+00

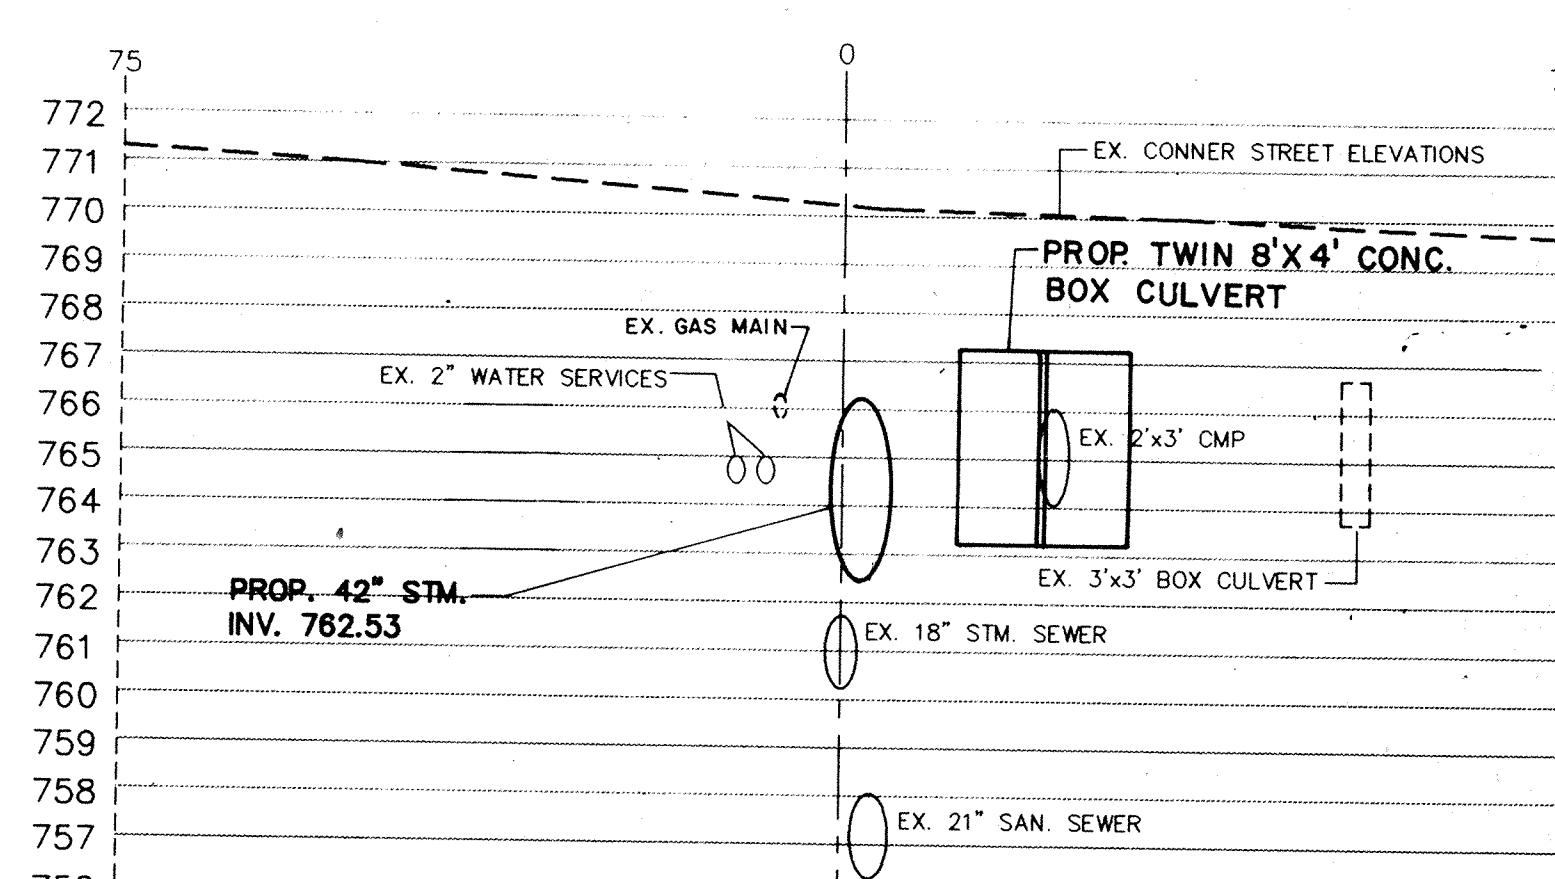

STATION 9+00



PROJECT ENGINEER

CERTIFIED BY

PRINCIPAL

PROJECT ENGINEER

CERTIFIED BY

PROJECT DESIGNER

REVISIONS

MARK DATE DESCRIPTION

91-93 PER OFFICE REVIEW

II-15-93 OFFICE REVIEW

A 2291 RECORD DRAWINGS

NOBLESVILLE HIGH SCHOOL OFF-SITE

ELWOOD WILSON DRAINAGE EASEMENT - CHERRY STREET TO MONUMENT STREET NOBLESVILLE, INDIANA

marchris/moore associates of Indiana

consulting engineers

9245 North Meridian Street
Suite 105
Indianapolis, In 46260-1812
(317) 843-2520 FAX 848-2765

Post Construction Survey



FILED

FEB 19 1997

OFFICE OF HAMILTON COUNTY SURVEYOR

TITLE: CROSS SECTIONS
STATION 10+50 TO STATION 15+00

DATE 7-22-93 SHEET NO.


SCALE 1"-20(HORIZ)
1"-4(VERT)

JOB NO. 93-011


DRAWN BY S. WEBER

10 of 20


EXISTING 150' ELWOOD WILSON DRAINAGE EASEMENT (TYPICAL)

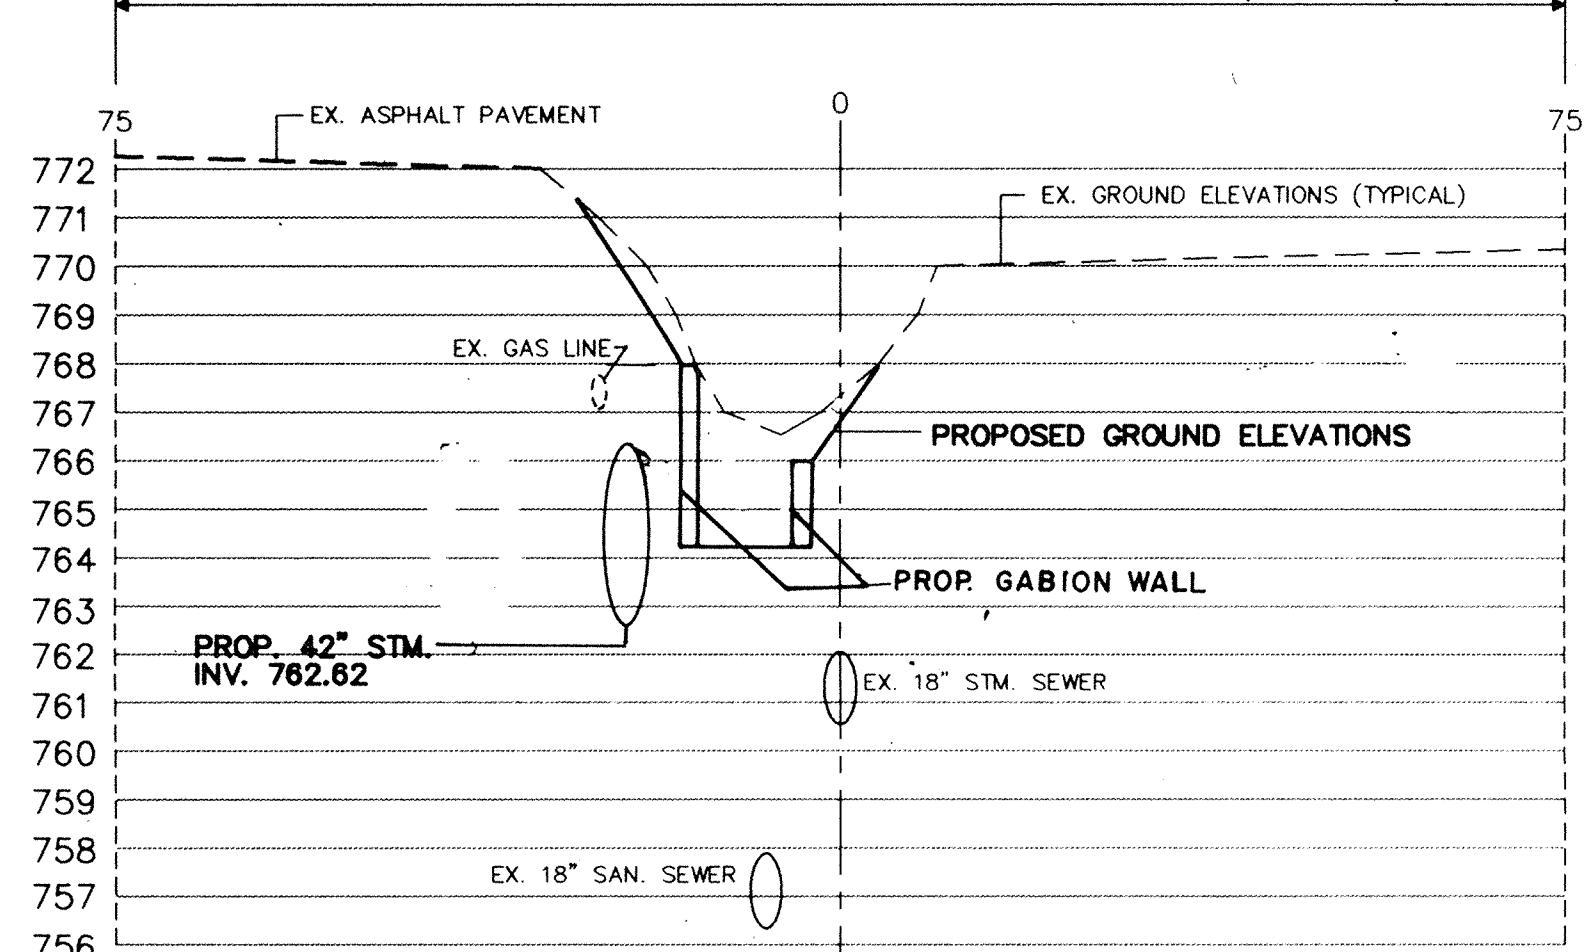


STATION 10+50

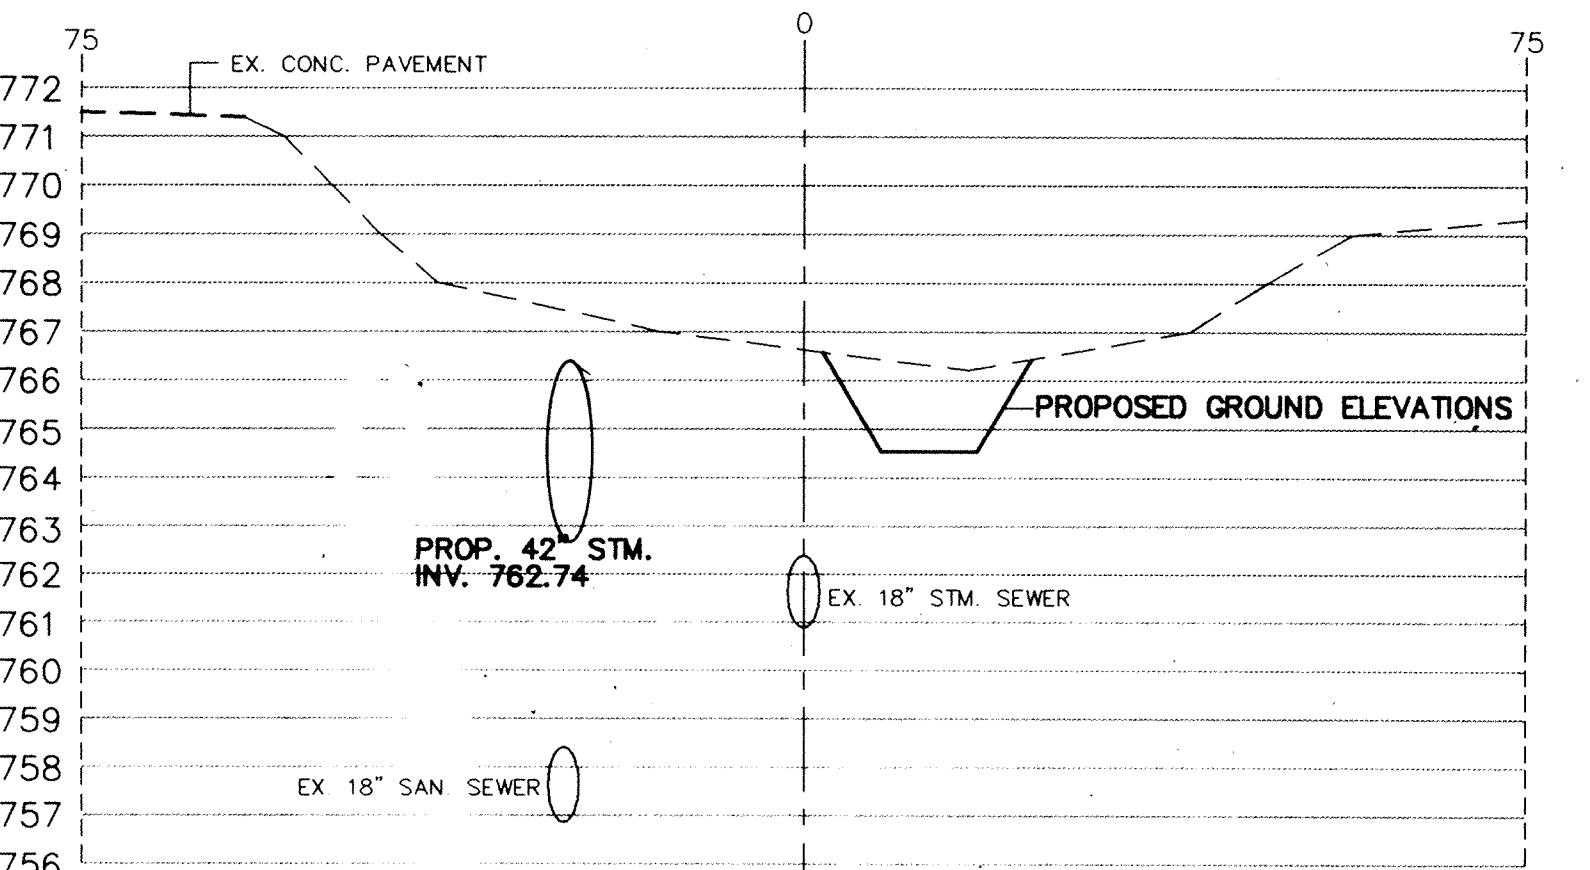


STATION 12+50

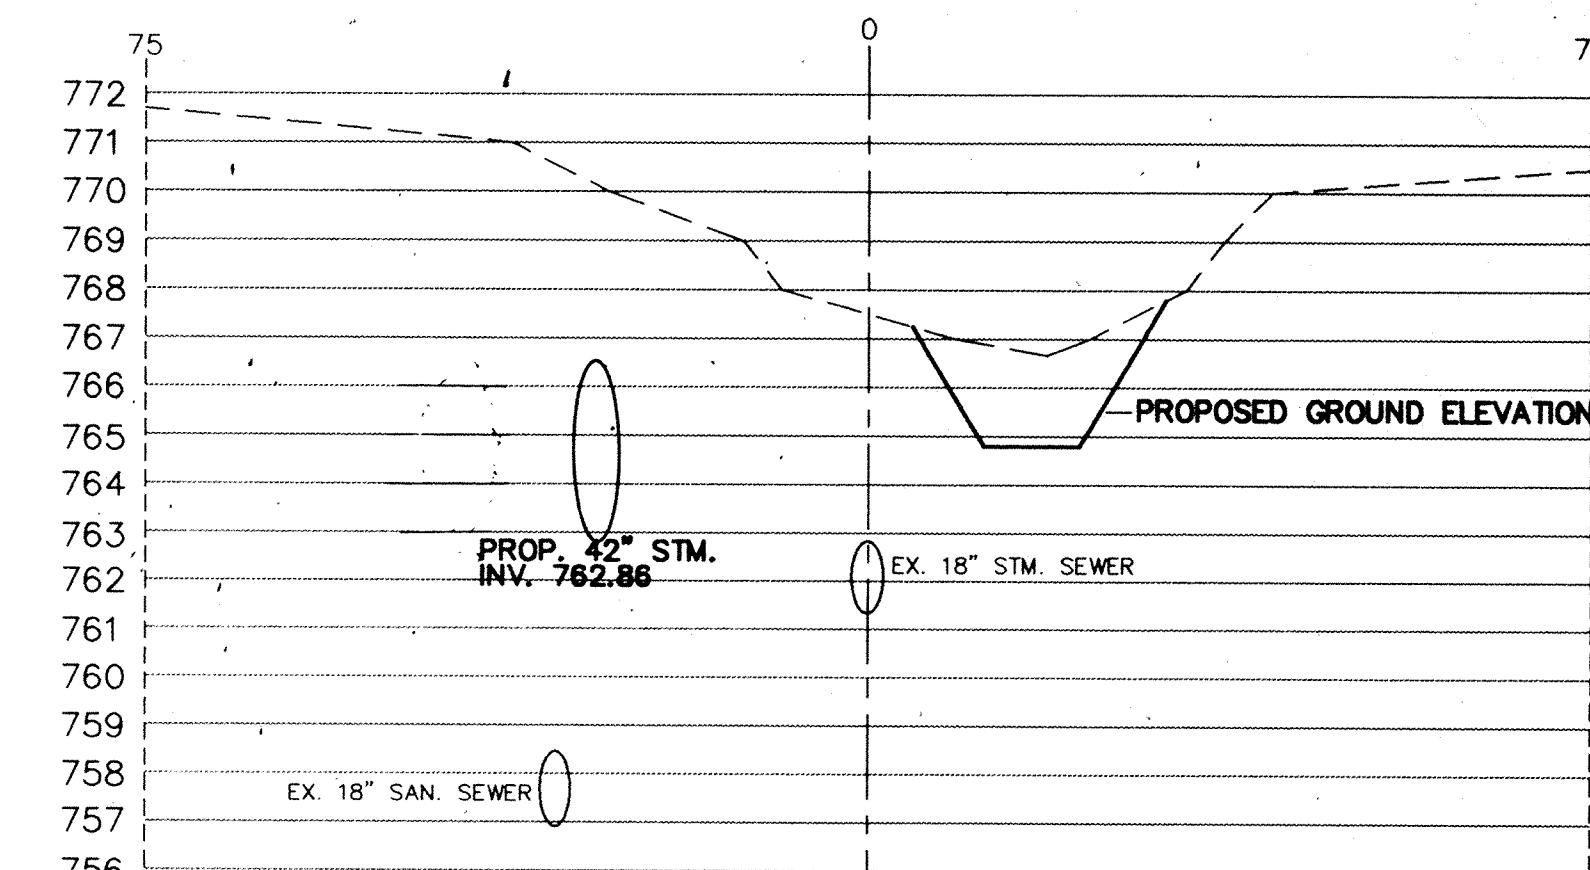


STATION 14+50

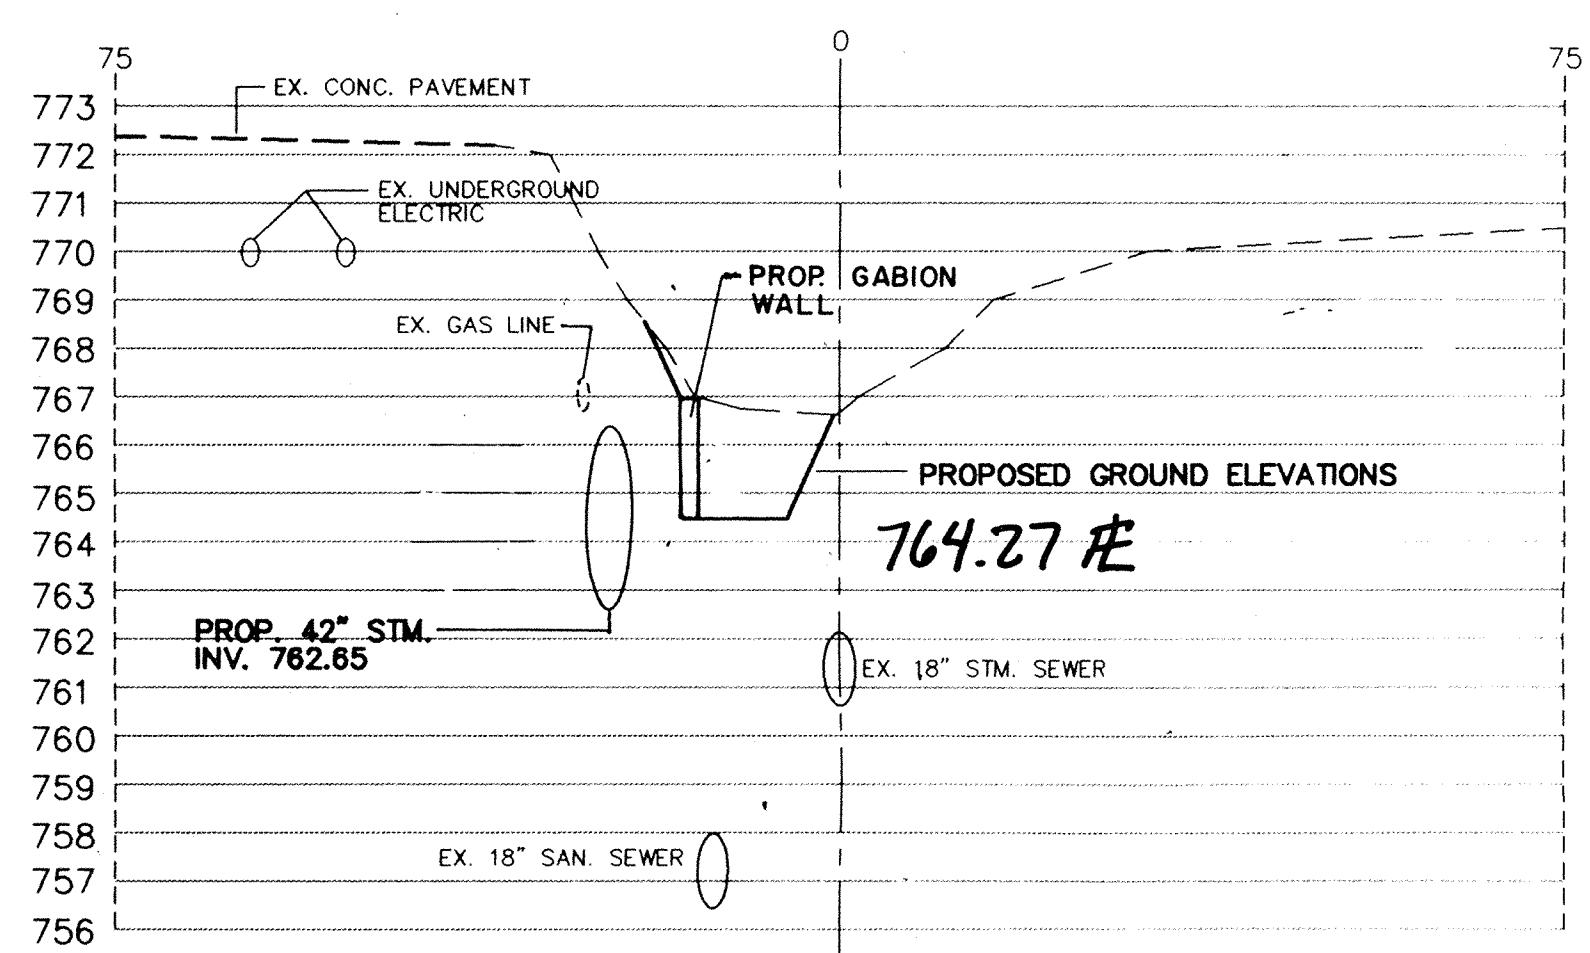


STATION 11+00

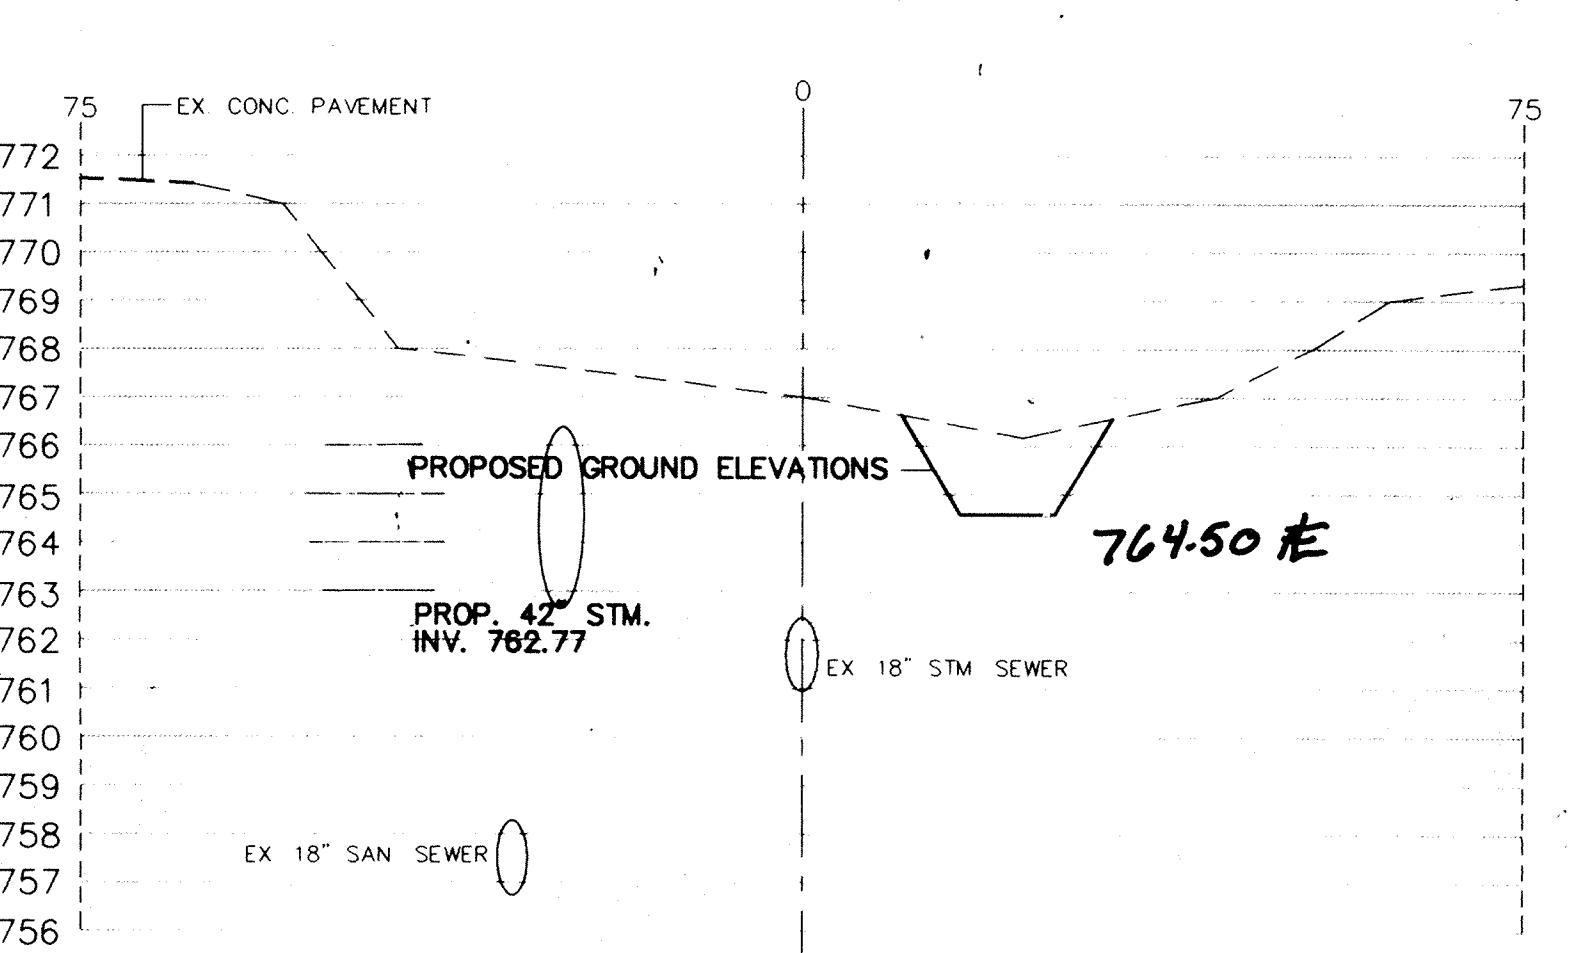


STATION 13+00

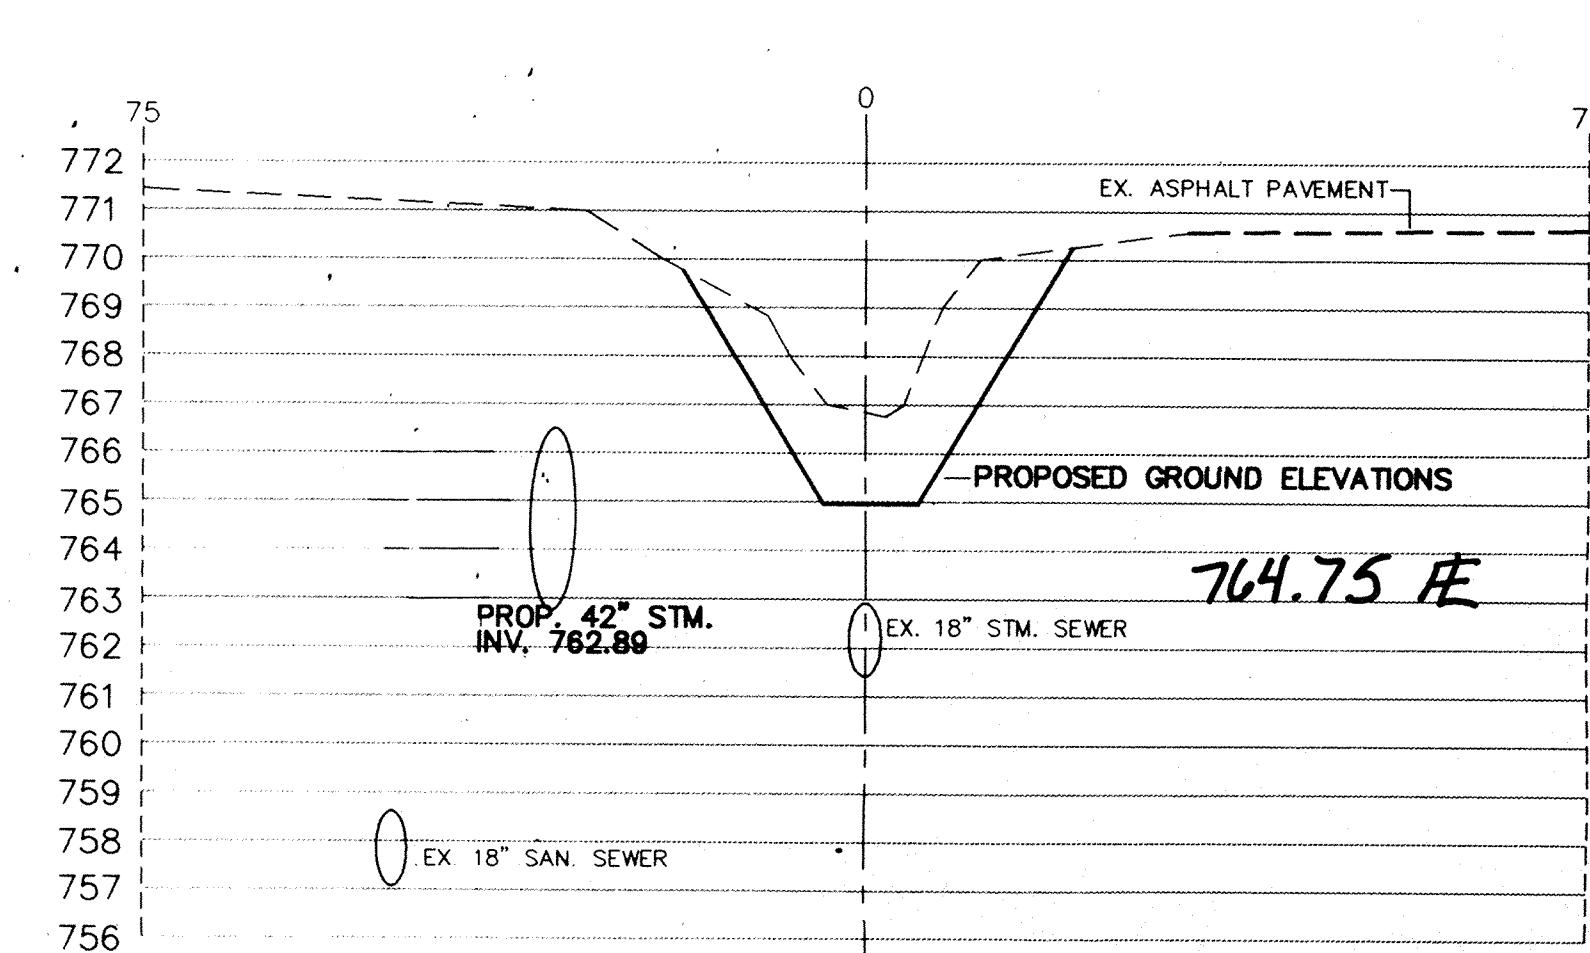


STATION 15+00

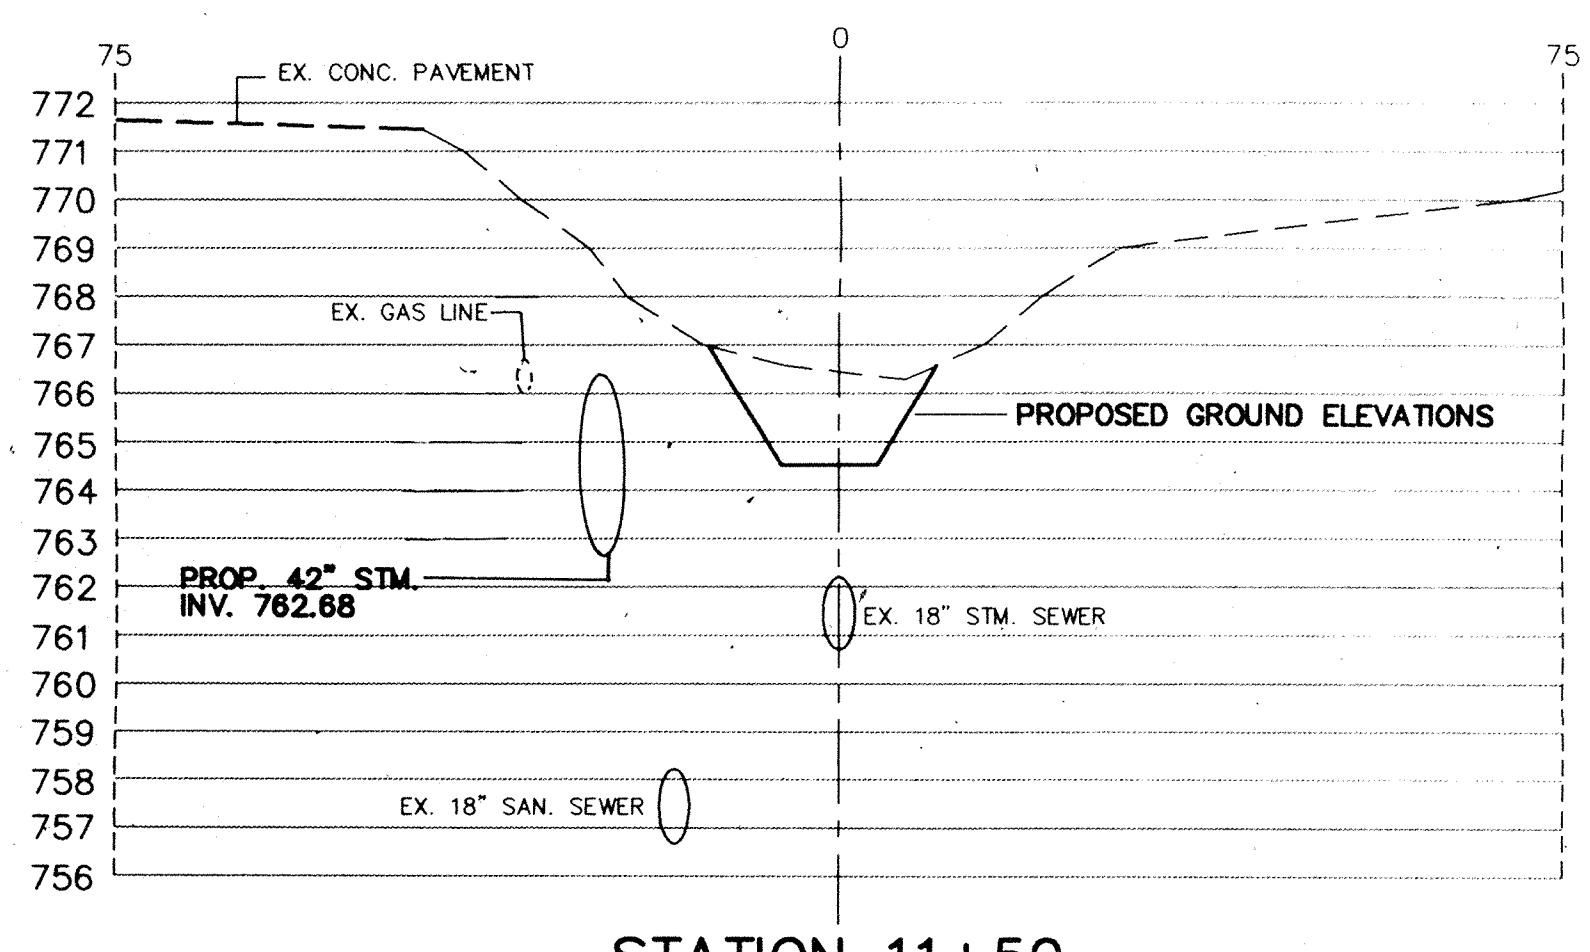


STATION 11+50

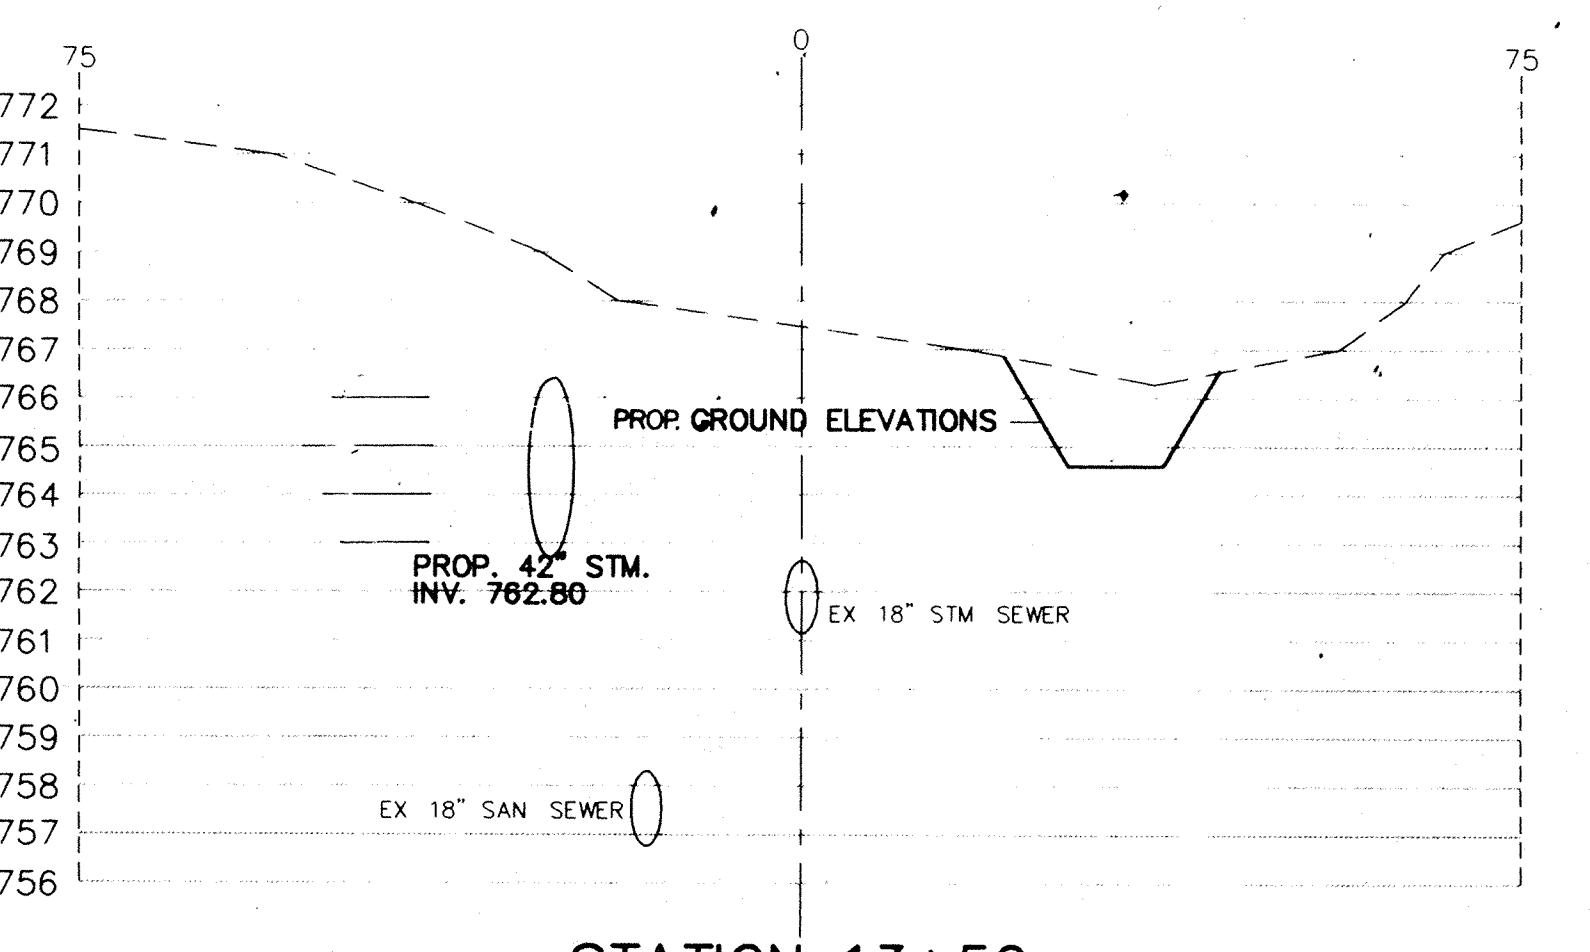

STATION 13+50

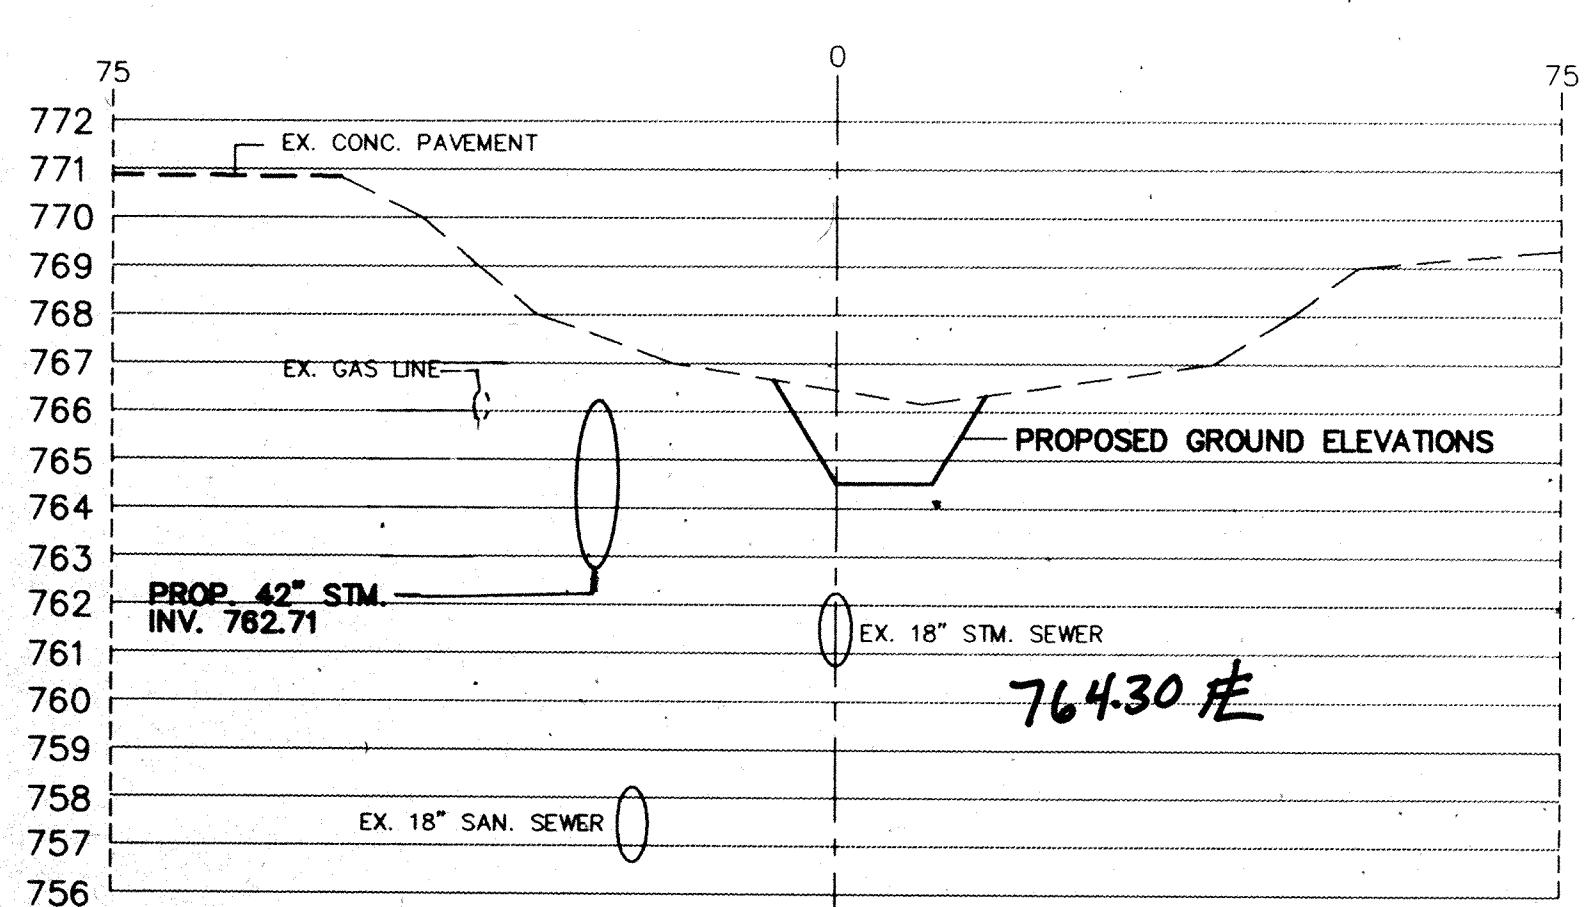

STATION 12+00

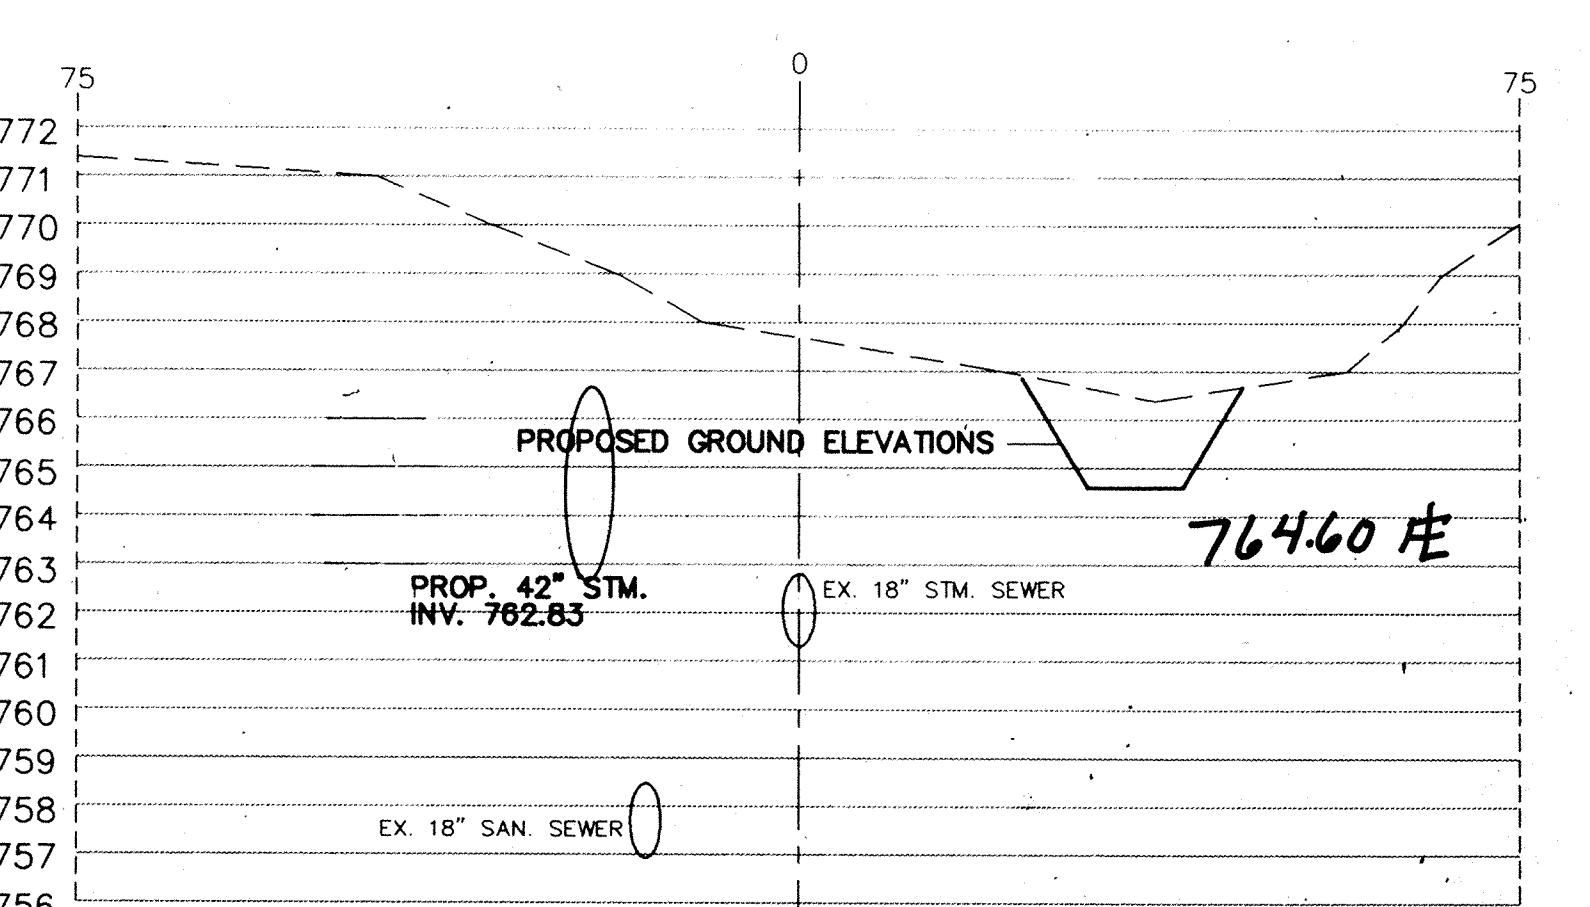

STATION 14+00

STATE OF
INDIANA
PROJECT ENGINEER
CERTIFIED BY
PRINCIPAL

PROJECT ENGINEER
CERTIFIED BY
PROJECT DESIGNER

REVISIONS

MARK	DATE	DESCRIPTION
	9-1-93	PER OFFICE REVIEW
	II-15-93	OFFICE REVIEW
⚠	1-28-94	RECORD DRAWINGS

NOBLESVILLE HIGH SCHOOL OFF-SITE


ELWOOD WILSON DRAINAGE EASEMENT IMPROVEMENTS - CHERRY STREET TO MONUMENT STREET
NOBLESVILLE, INDIANA

marchris/moore associates of Indiana

consulting engineers

9245 North Meridian Street
Suite 105
Indianapolis, In 46260-1812
(317) 843-2520 FAX 848-2765

Post Construction Survey

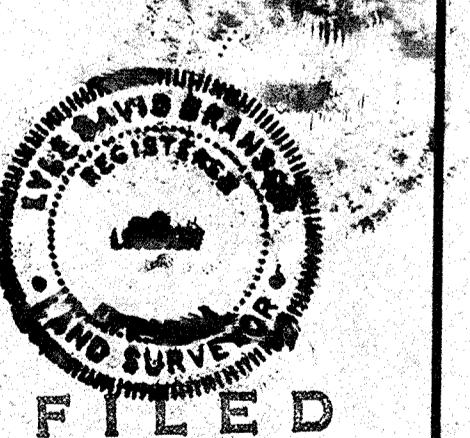

FEB 19 1997

OFFICE OF HAMILTON COUNTY SURVEYOR

TITLE:
CROSS SECTIONS
STATION 15+50 TO
STATION 20+00

DATE 7-22-93 SHEET NO.


SCALE 1"-20'(HORIZ)
1"-4'(VERT)

JOB NO. 93-011


DRAWN BY S.WEBER

11 of 20


EXISTING 150' ELWOOD WILSON DRAINAGE EASEMENT (TYPICAL)

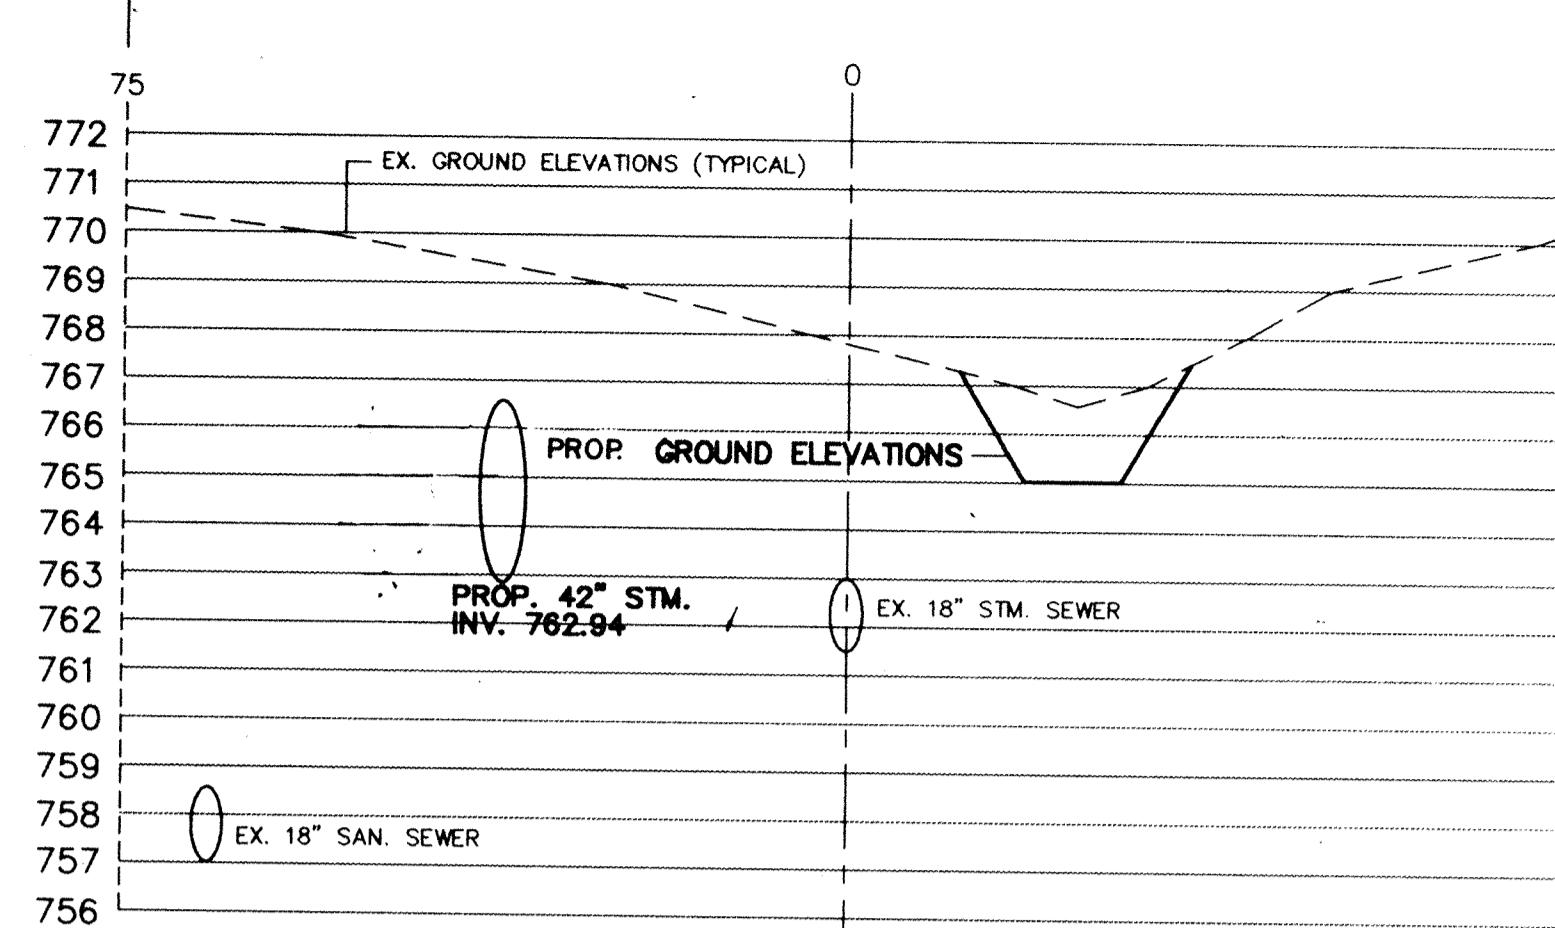


STATION 15+50

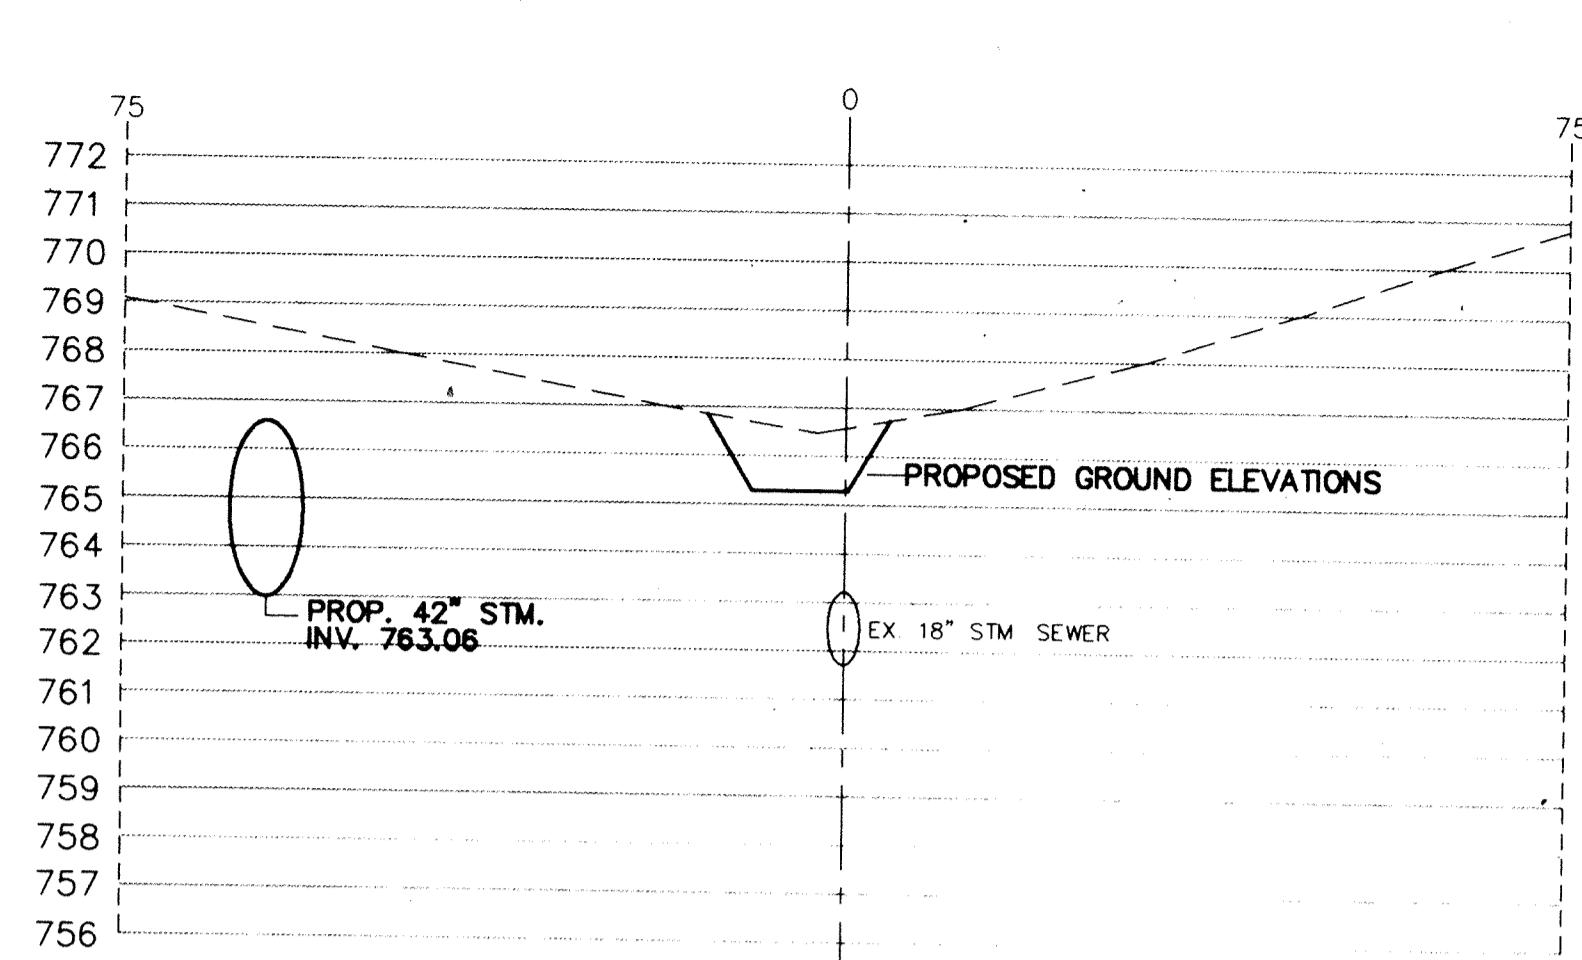


STATION 17+50

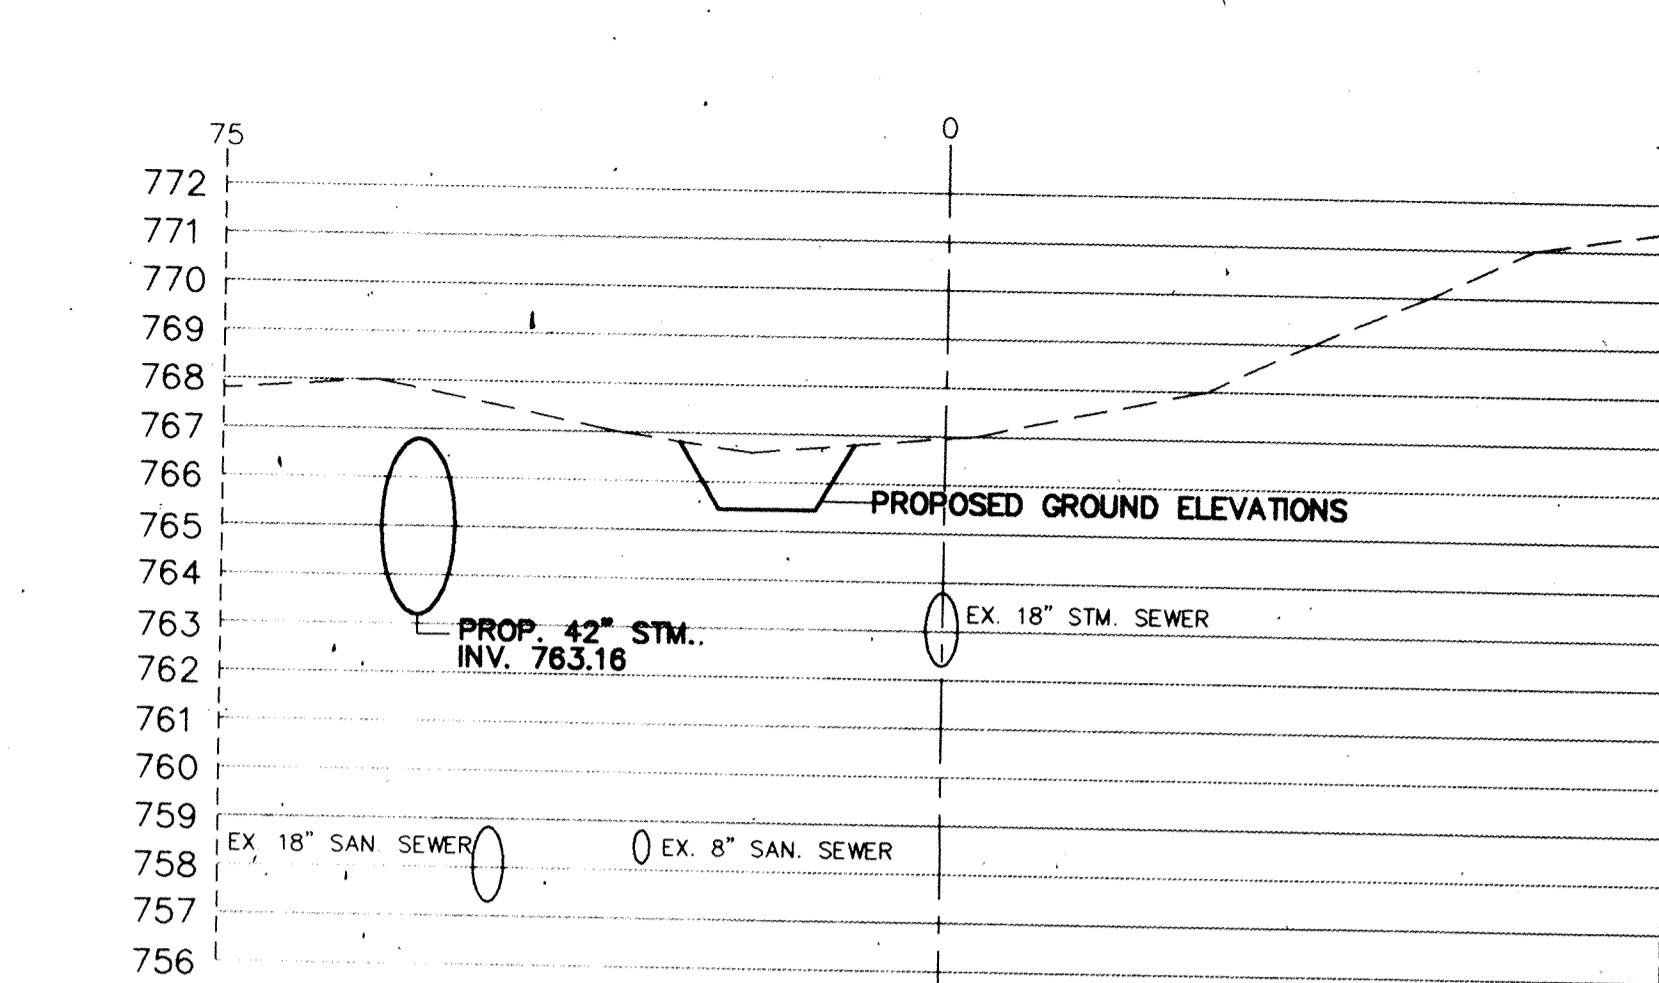


STATION 19+50

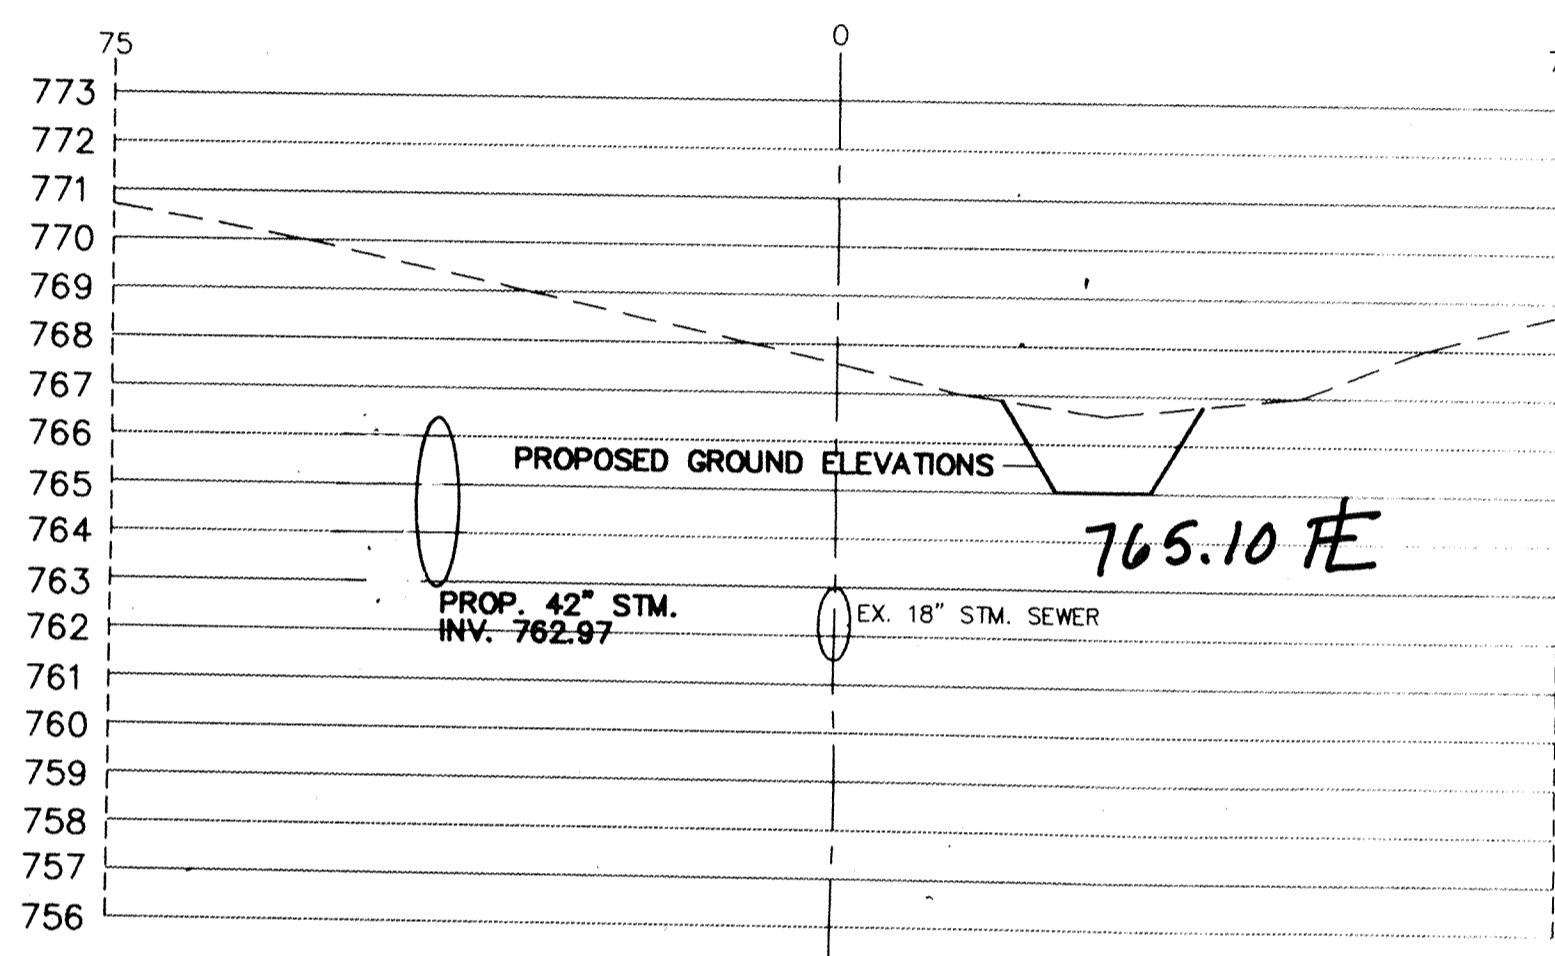


STATION 16+00

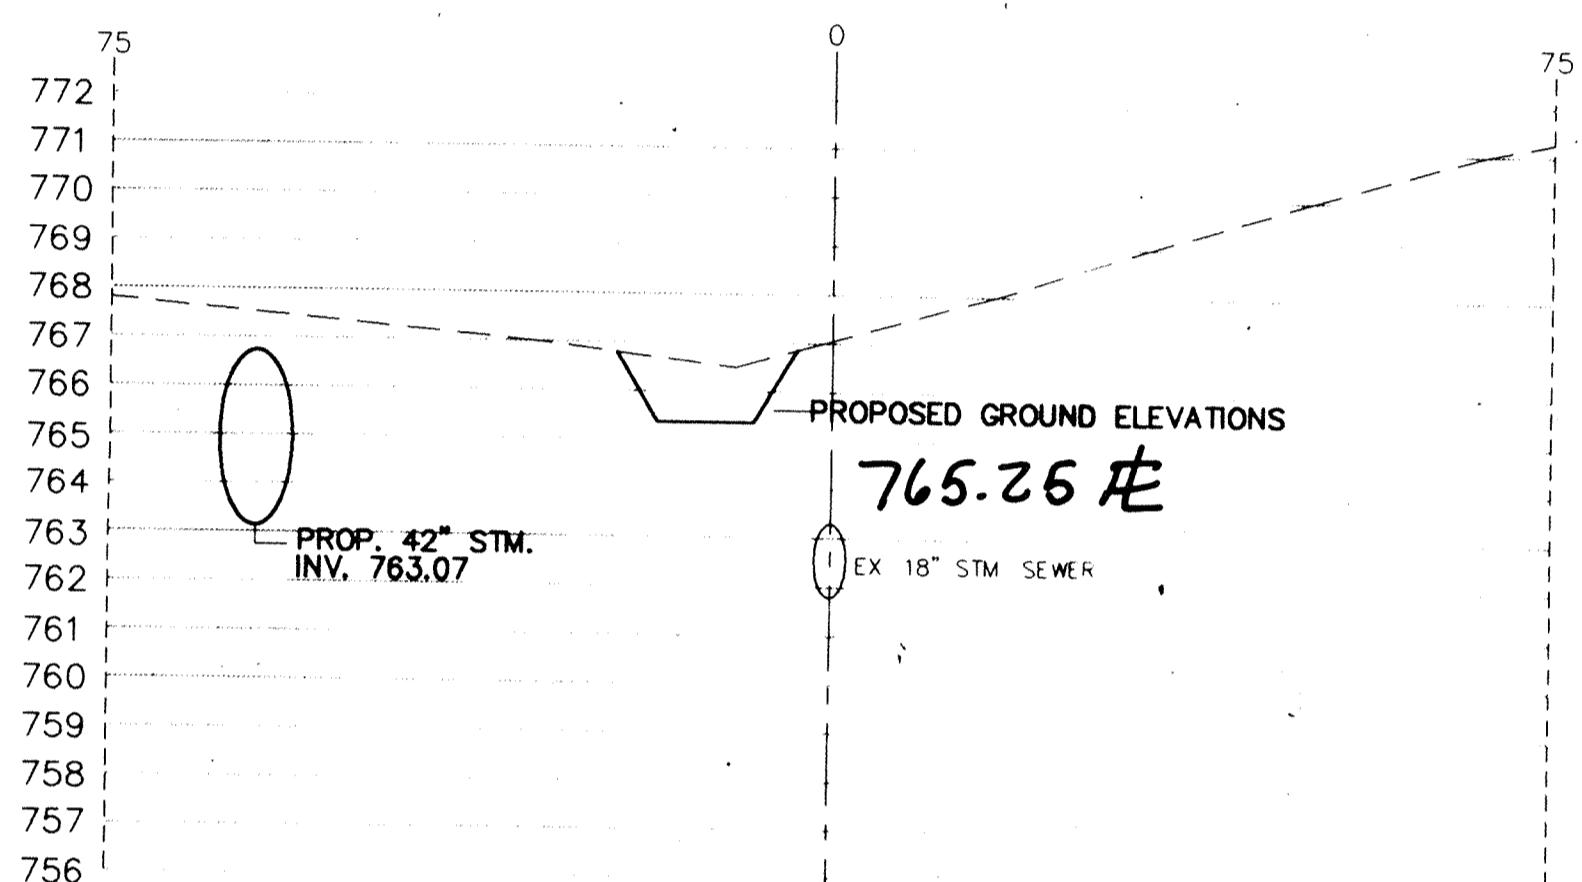


STATION 18+00

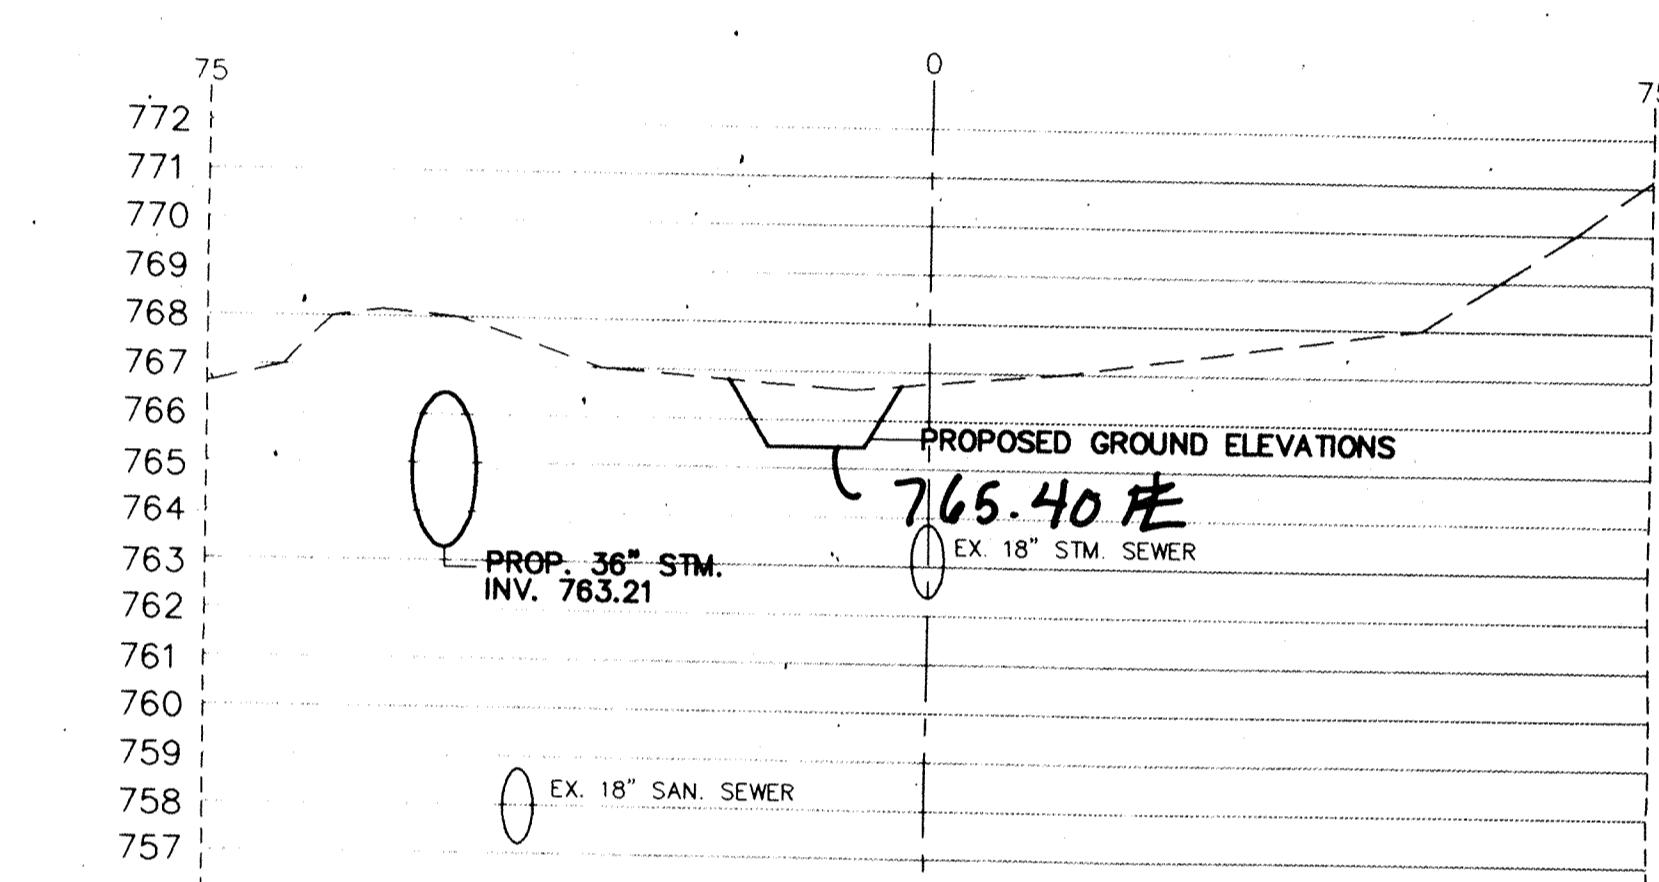


STATION 20+00

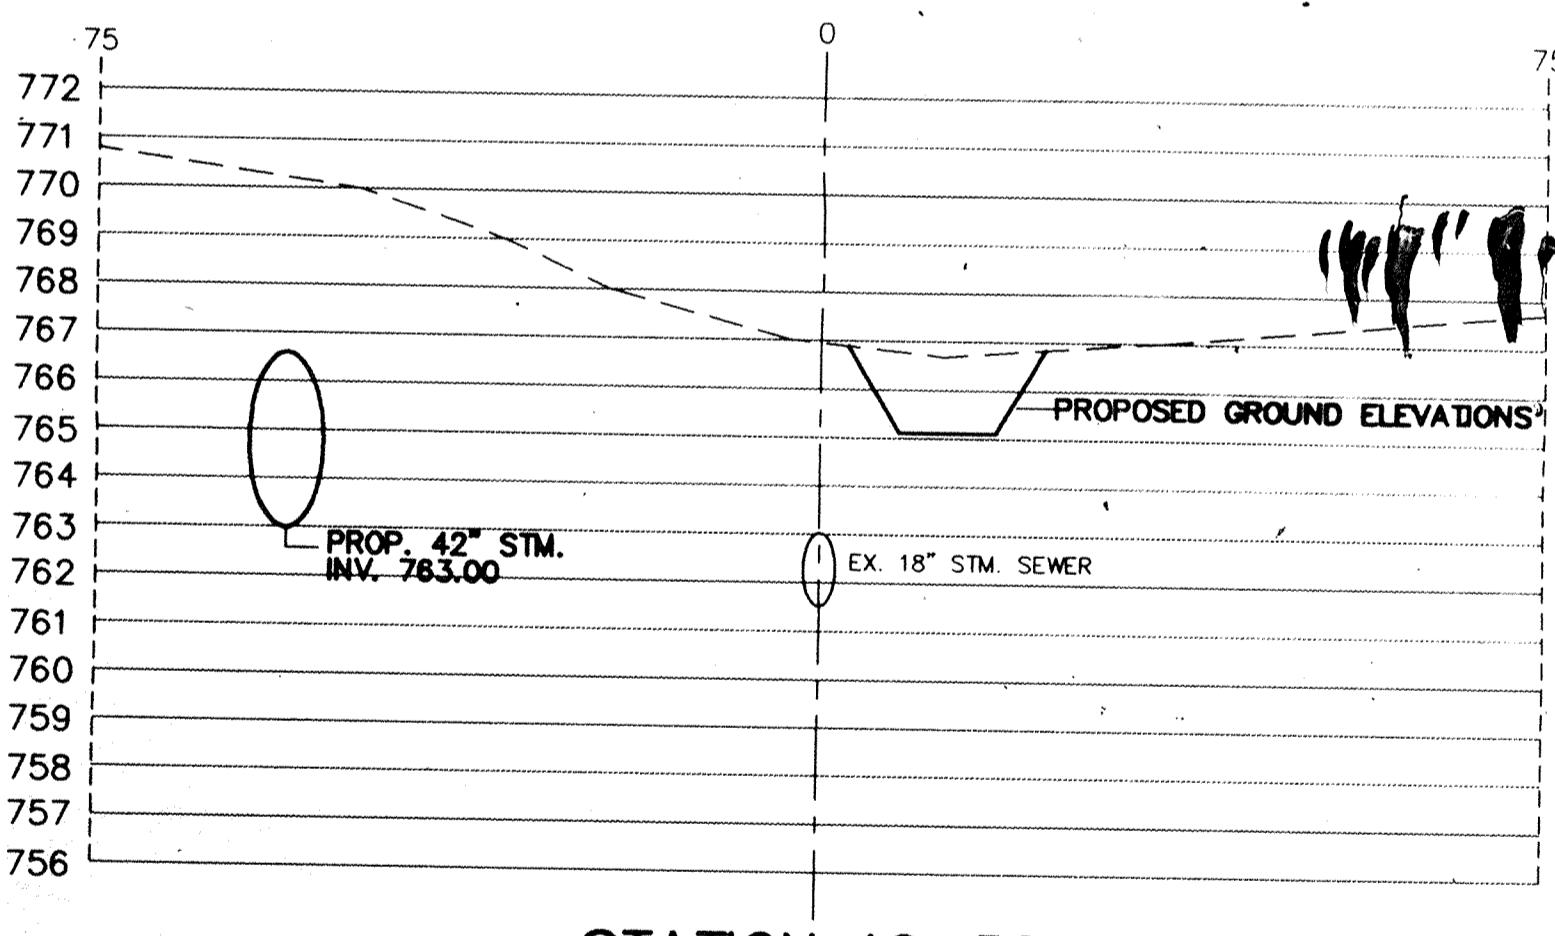


STATION 16+50

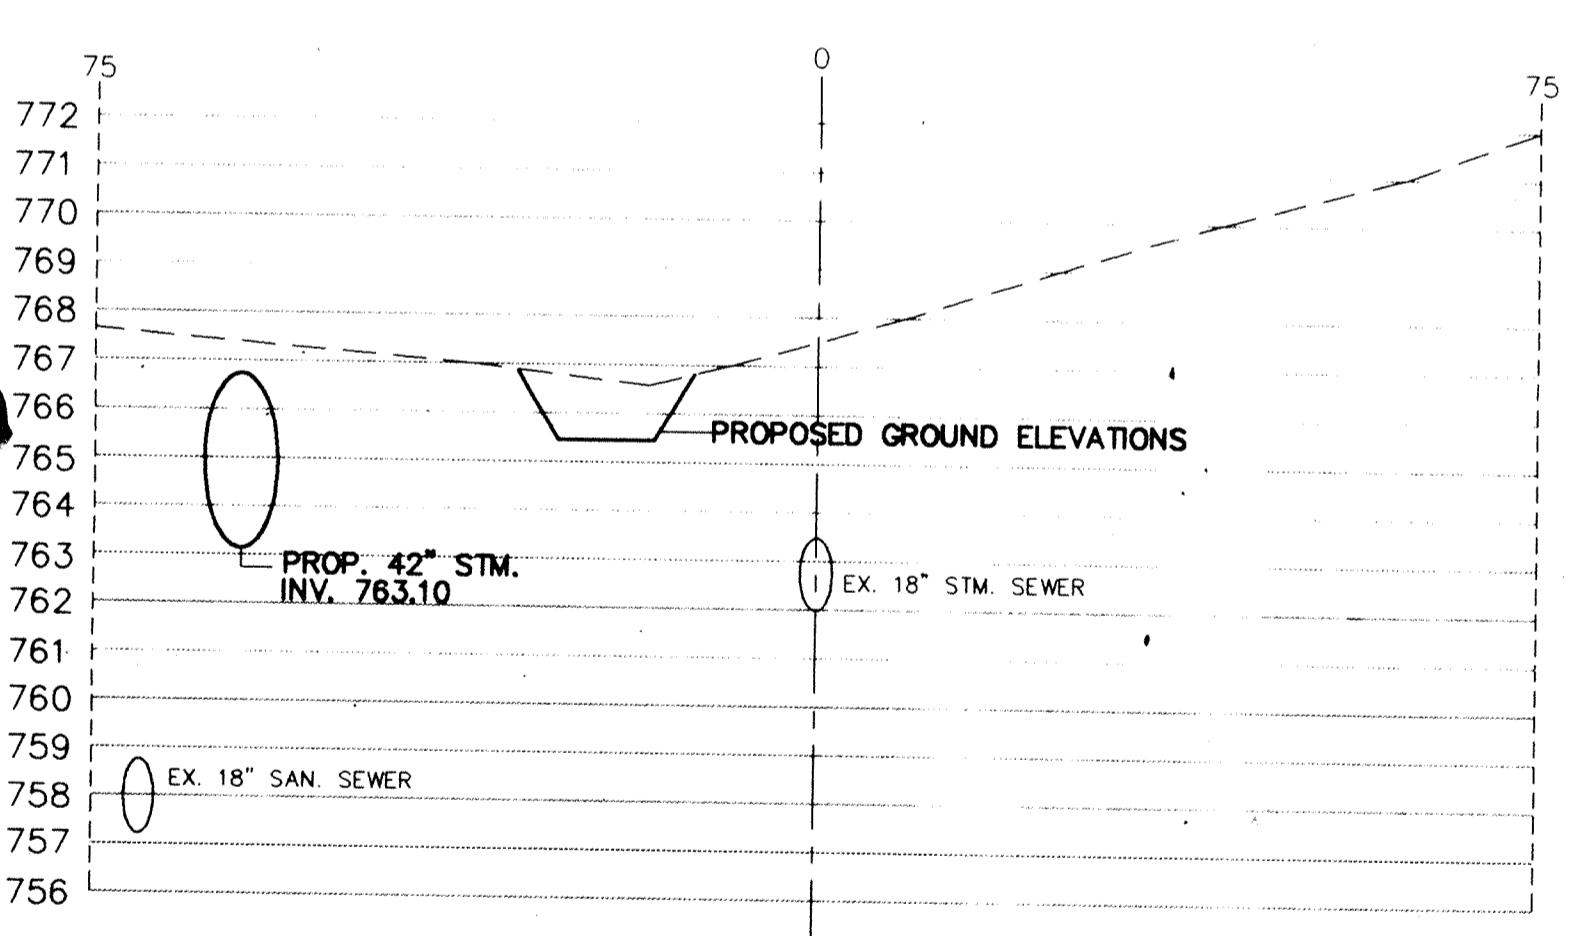


STATION 18+50

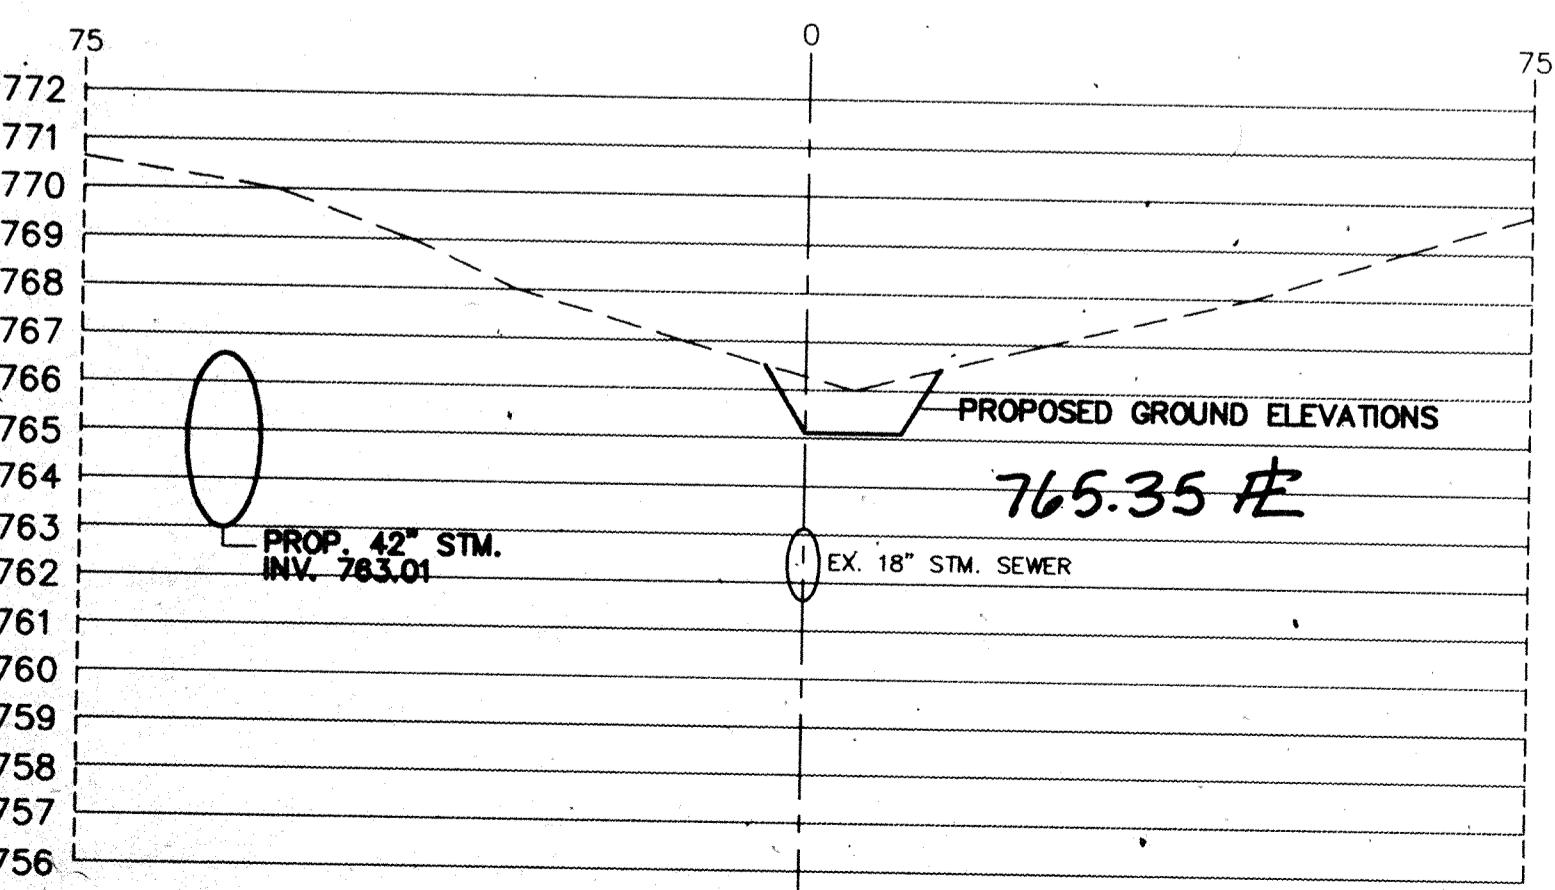

STATION 17+00

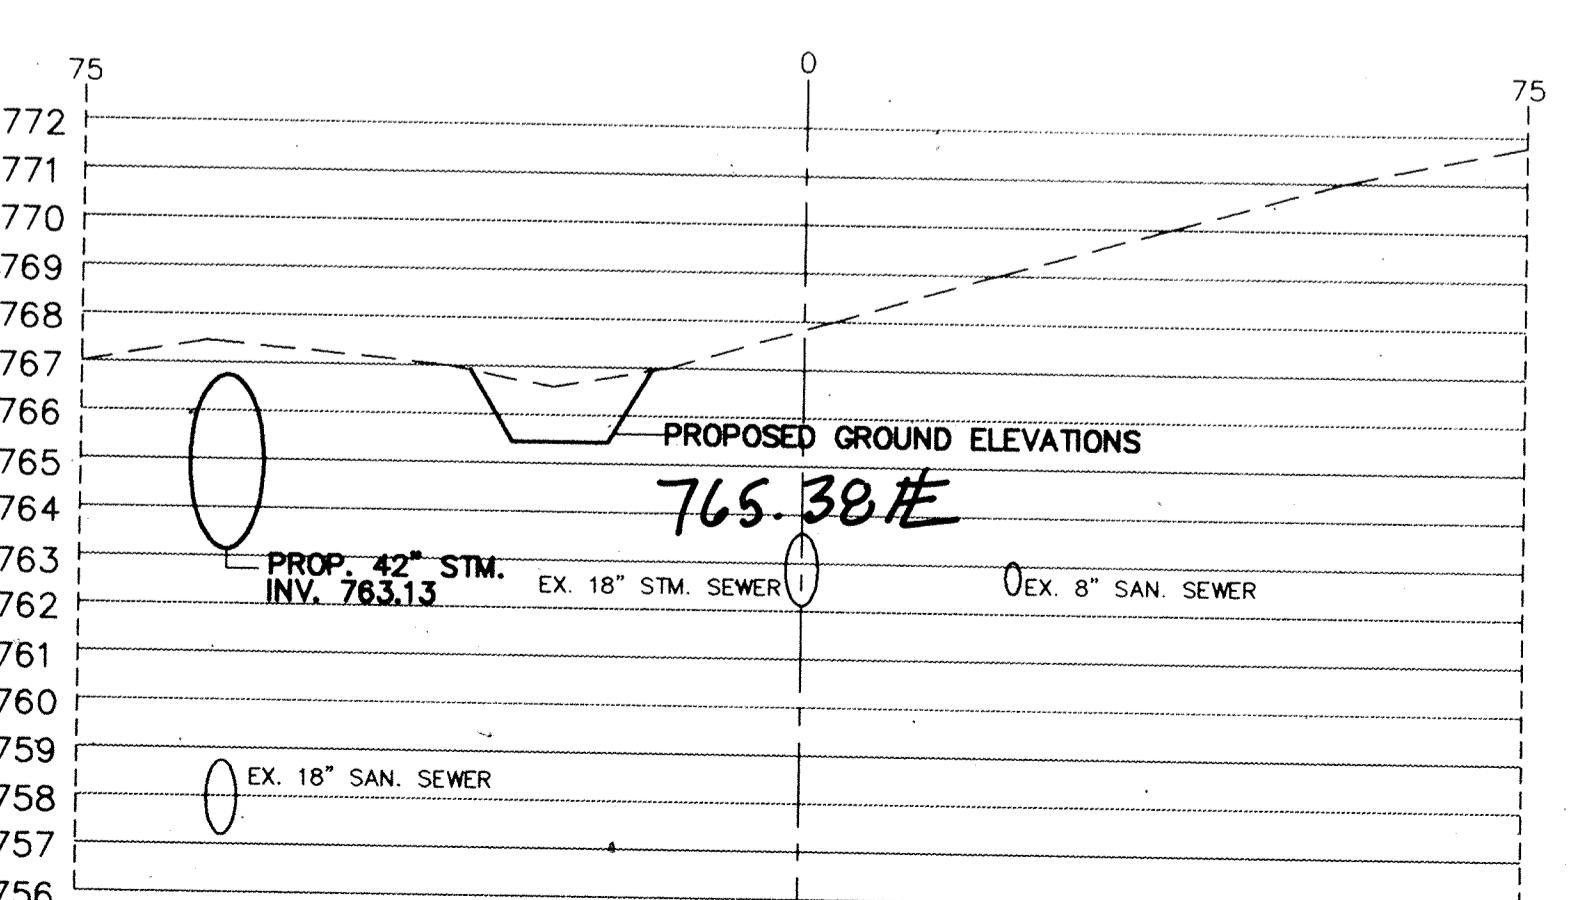

STATION 19+00

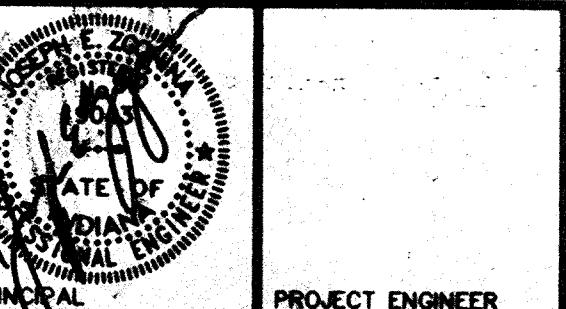

PROJECT ENGINEER

CERTIFIED BY

PRINCIPAL

PROJECT ENGINEER

CERTIFIED BY

PROJECT DESIGNER

REVISIONS

MARK	DATE	DESCRIPTION
9-1-93		PER OFFICE REVIEW
11-15-93		OFFICE REVIEW
1-18-97		RECORD DRAWINGS


NOBLESVILLE HIGH SCHOOL OFF-SITE
ELWOOD WILSON DRAINAGE EASEMENT
IMPROVEMENTS - CHERRY STREET TO
MONUMENT STREET
NOBLESVILLE, INDIANA

marchis/moore associates
of indiana

consulting engineers

9245 North Meridian Street
Suite 105
Indianapolis, In 46260-1812
(317) 843-2520 FAX 848-2765

Post Construction
Survey

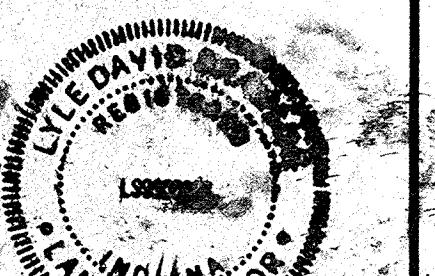

FILED

FEB 19 1997

OFFICE OF HAMILTON COUNTY SURVEYOR

TITLE:
CROSS SECTIONS
STATION 20+50 TO
STATION 25+00

DATE 7-22-93 SHEET NO.


SCALE 1"-20' (HORIZ)
1'-4" (VERT)

JOB NO. 93-011


DRAWN BY S. WEBER

12 of 20


EXISTING 150' ELWOOD WILSON DRAINAGE EASEMENT (TYPICAL)

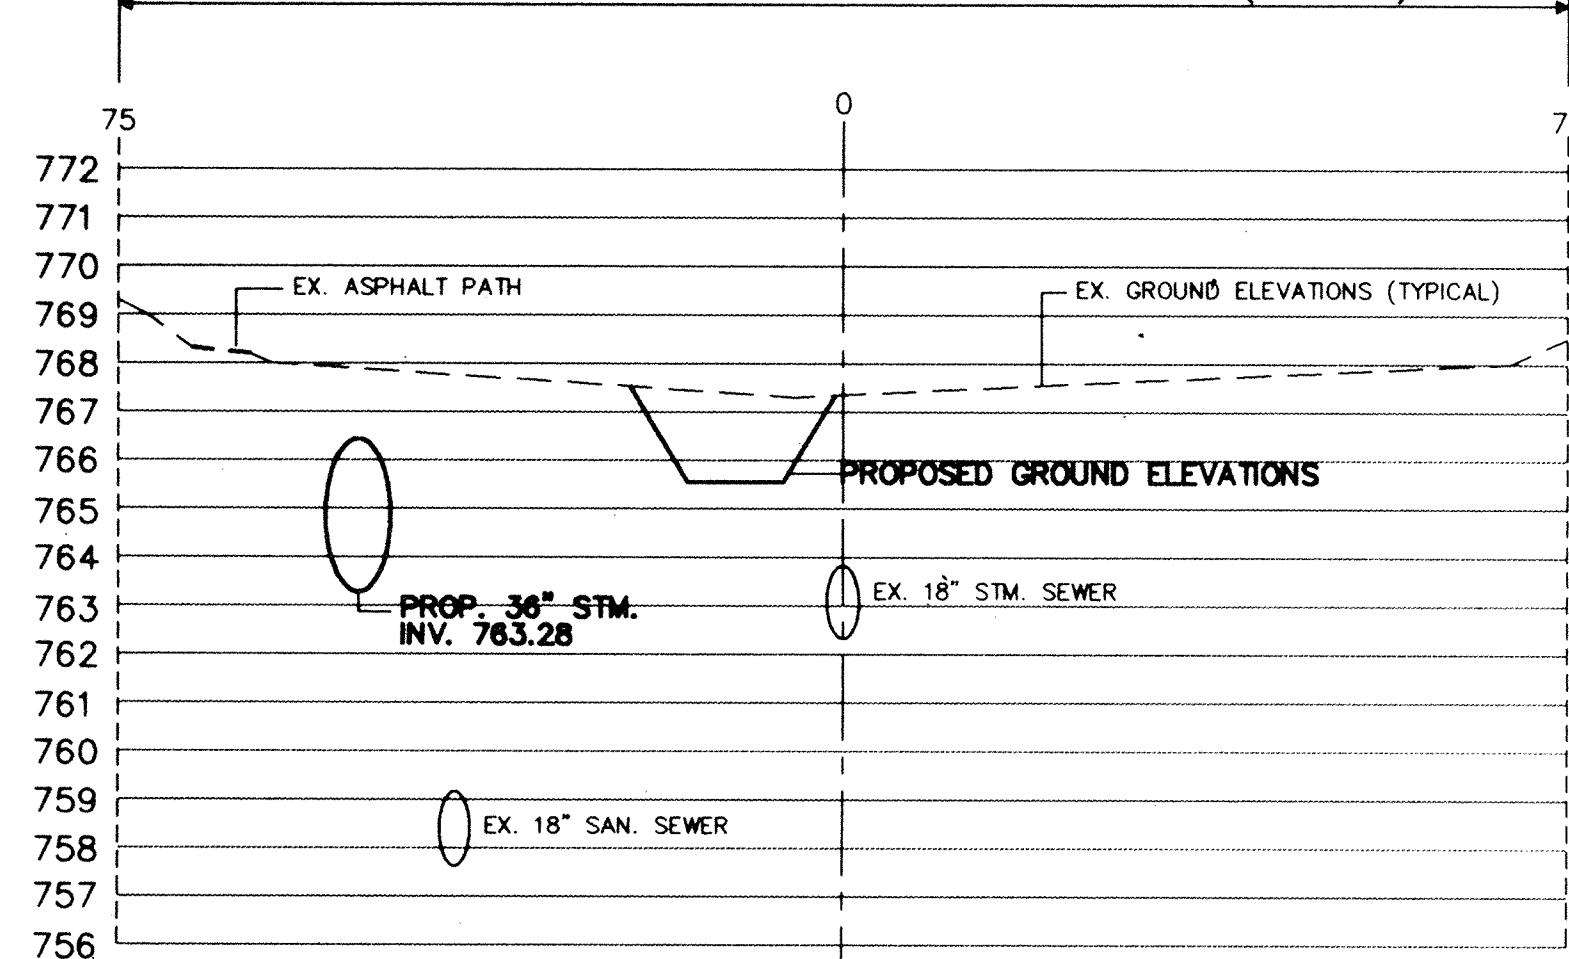


STATION 20+50

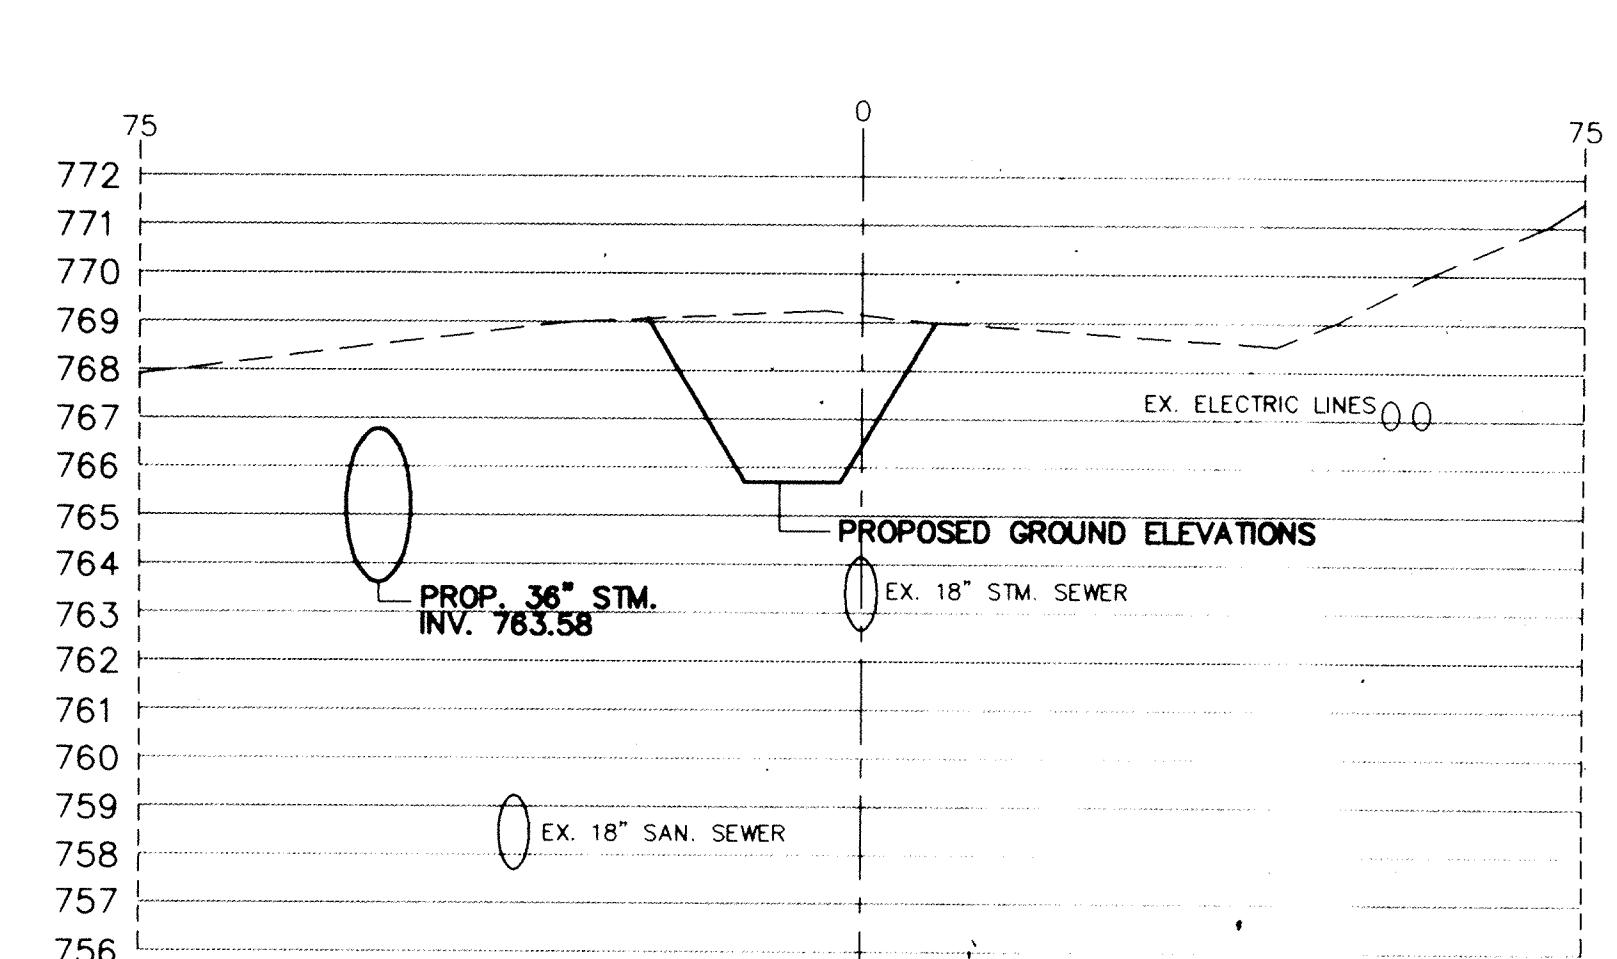


STATION 22+50

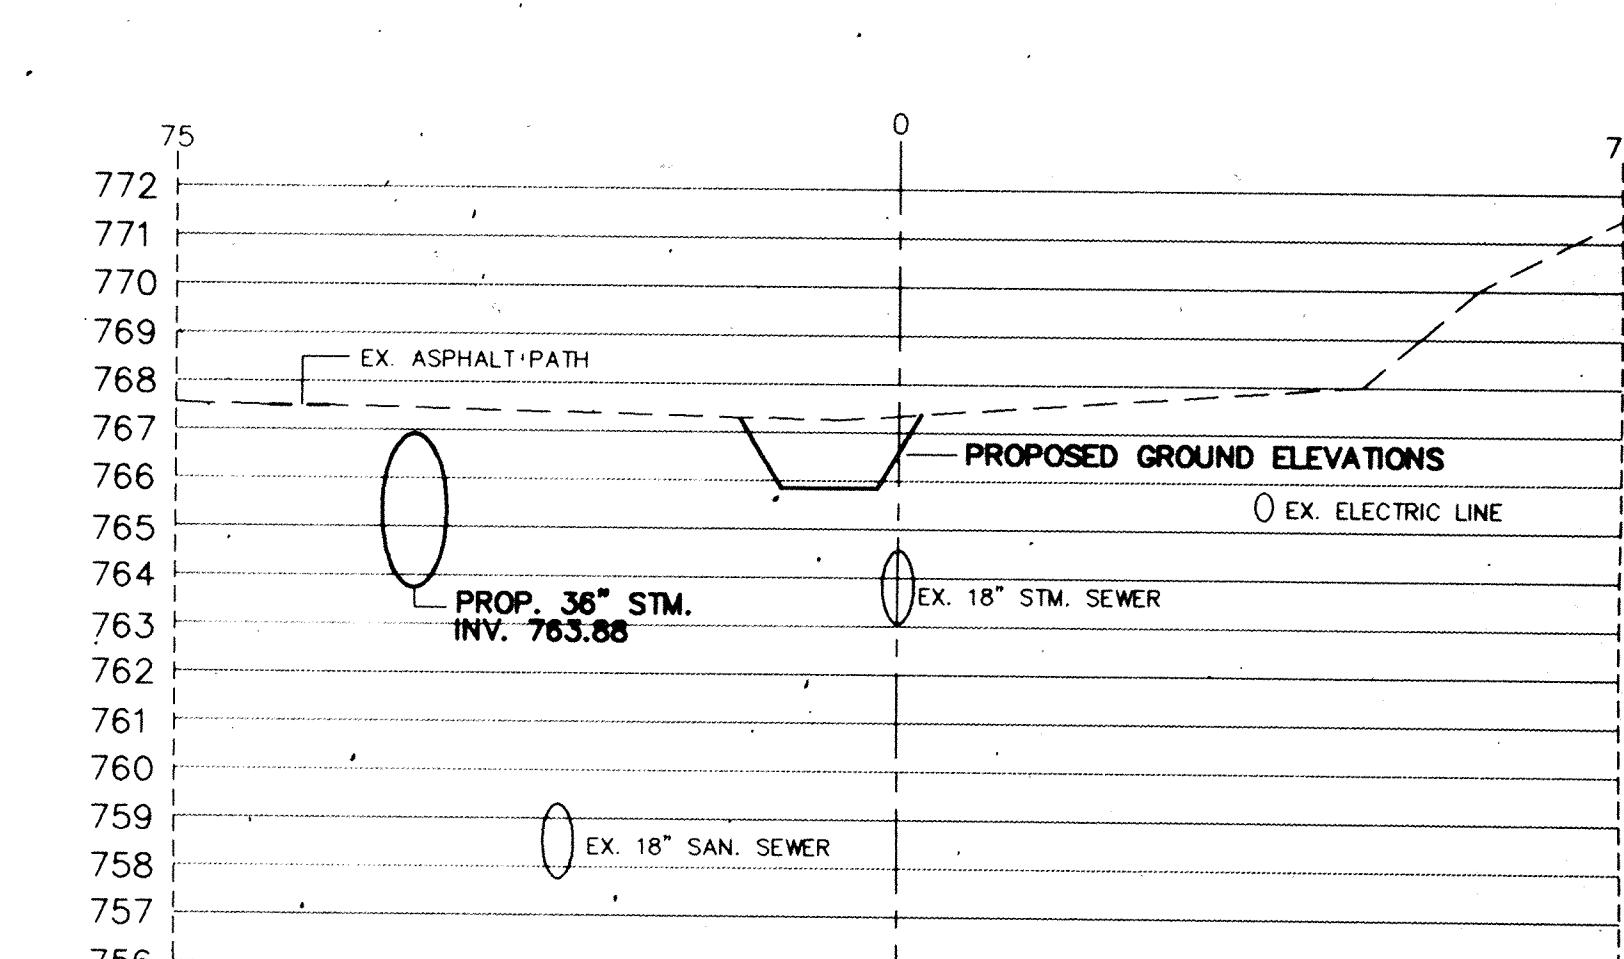


STATION 24+50

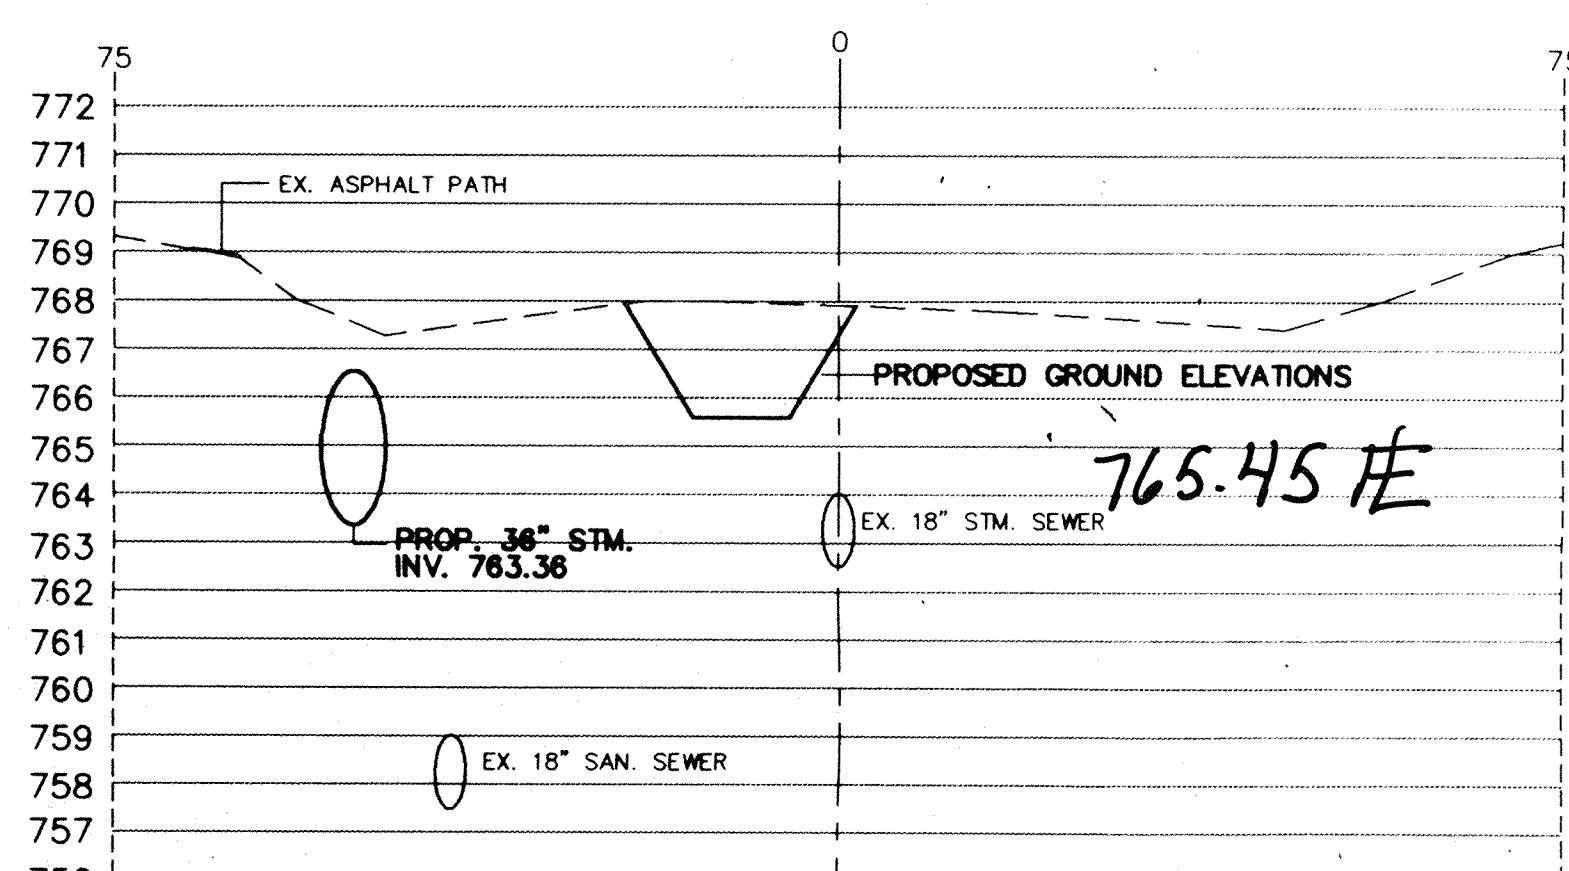


STATION 21+00

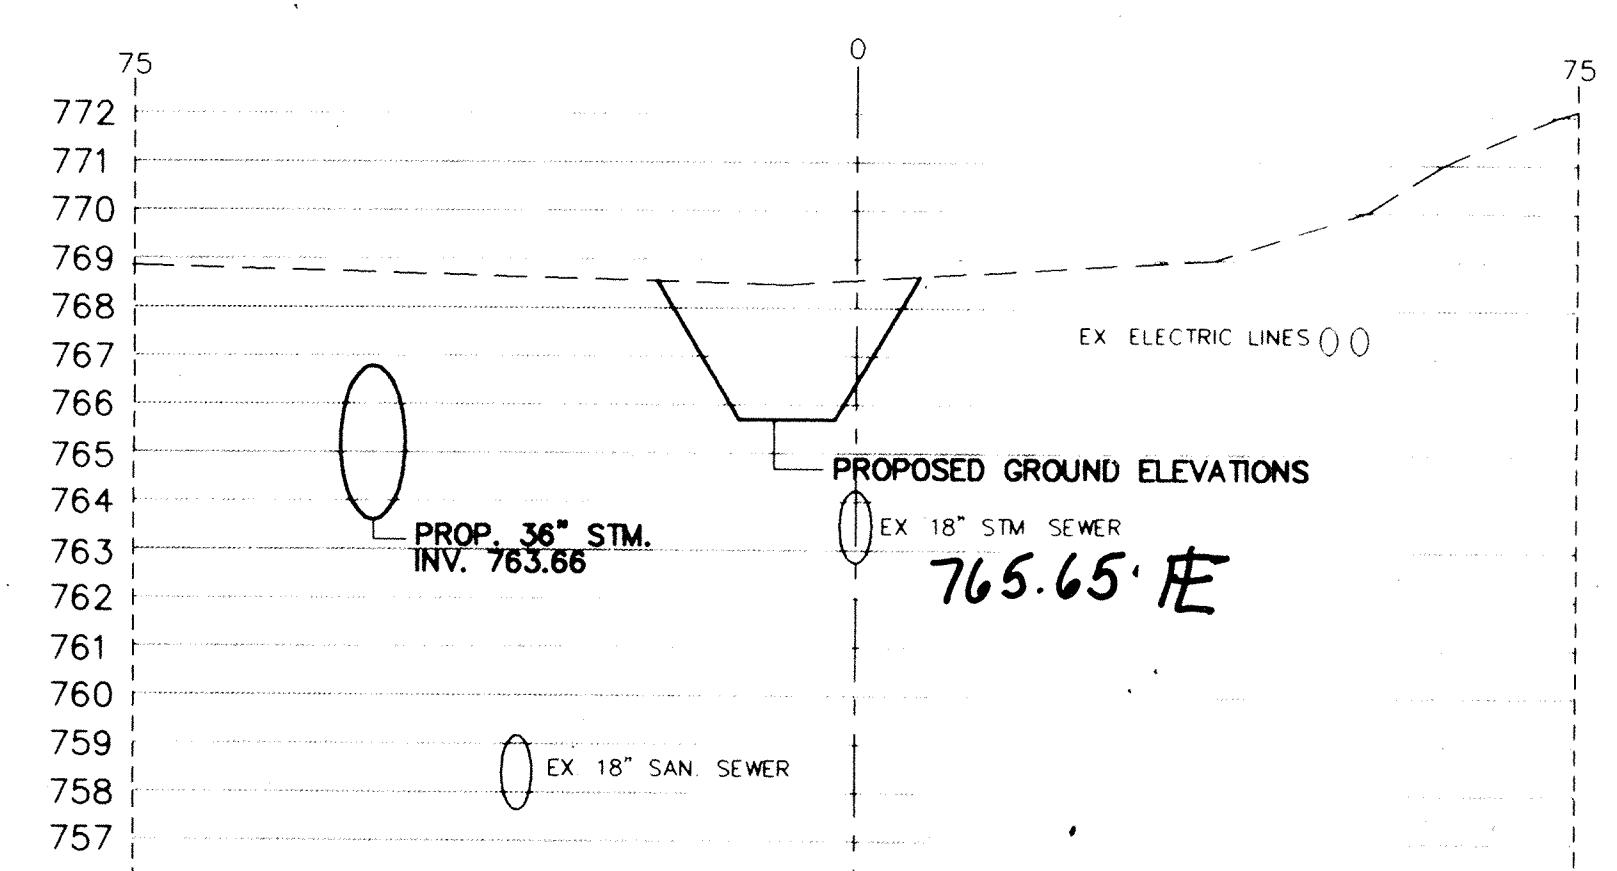


STATION 23+00

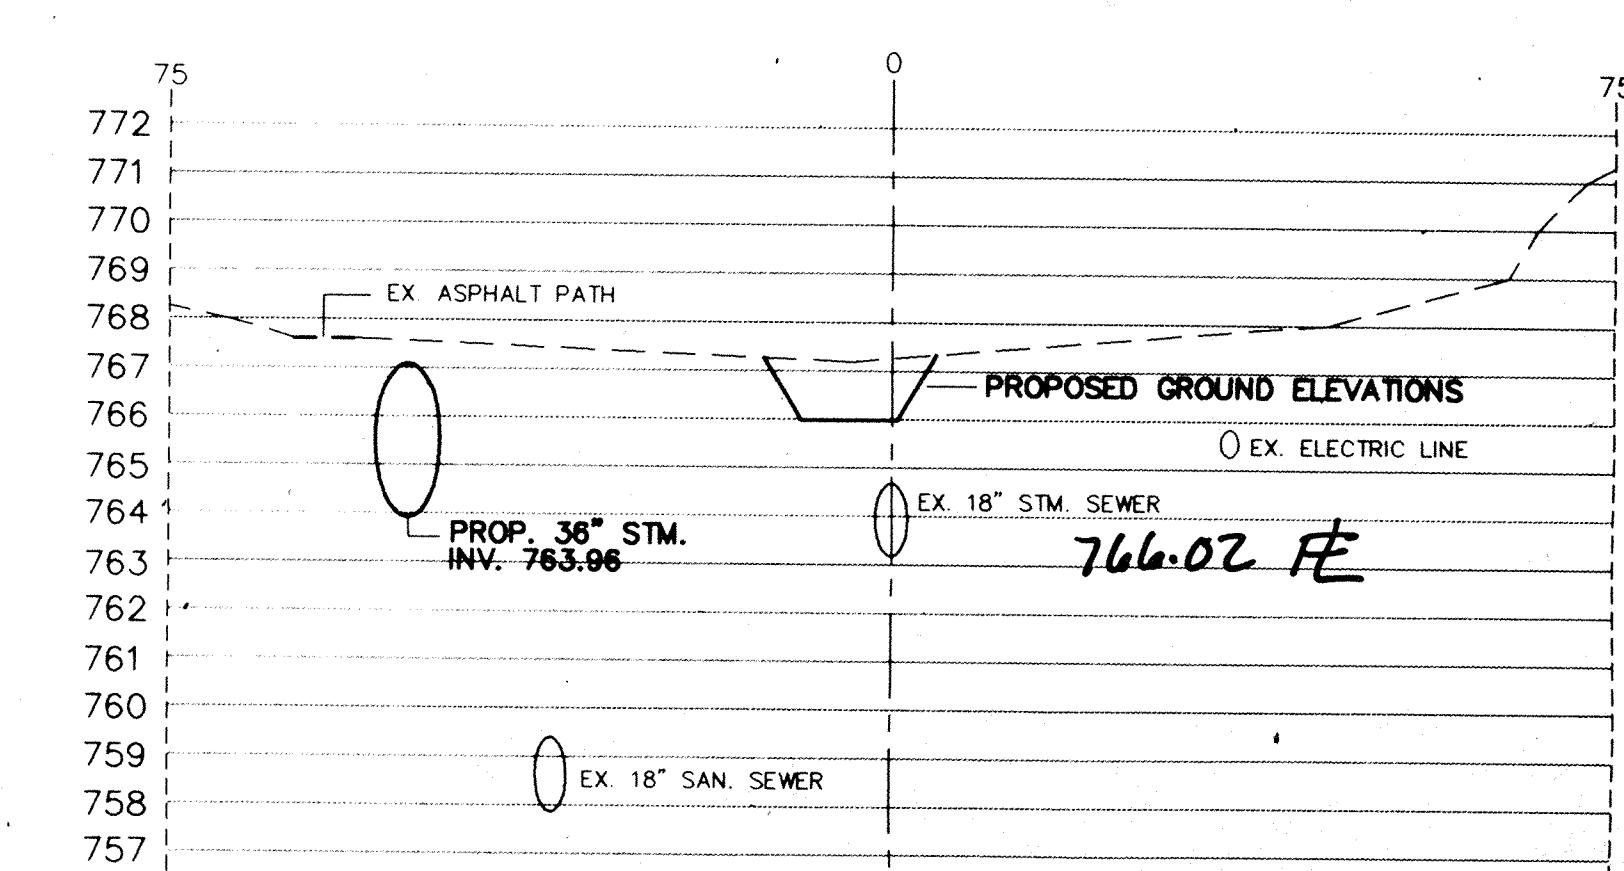


STATION 25+00

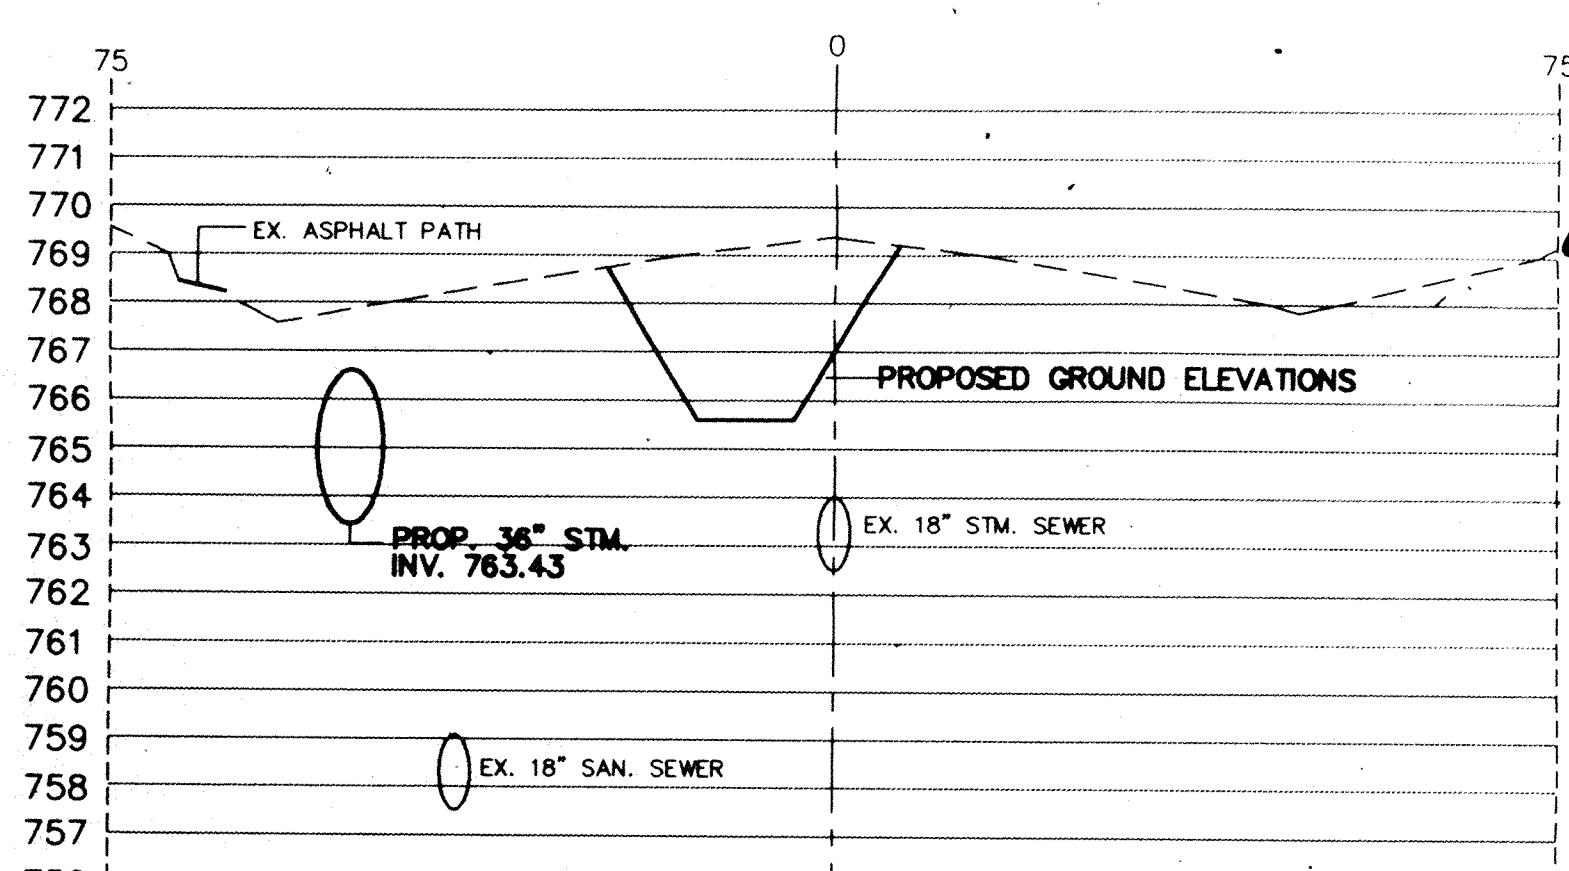


STATION 21+50

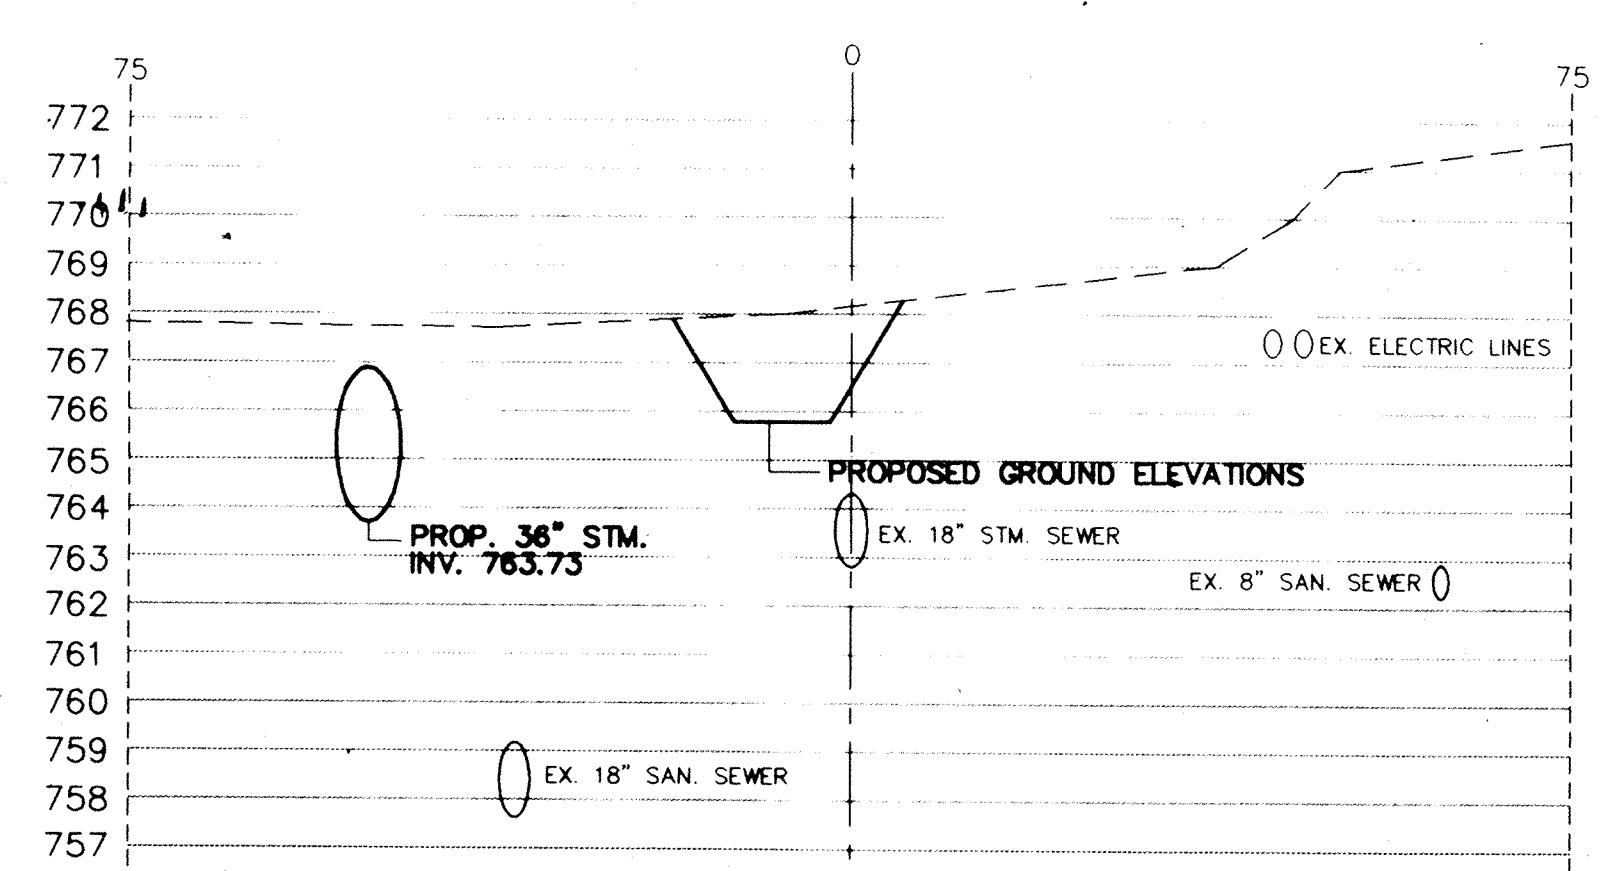


STATION 23+50

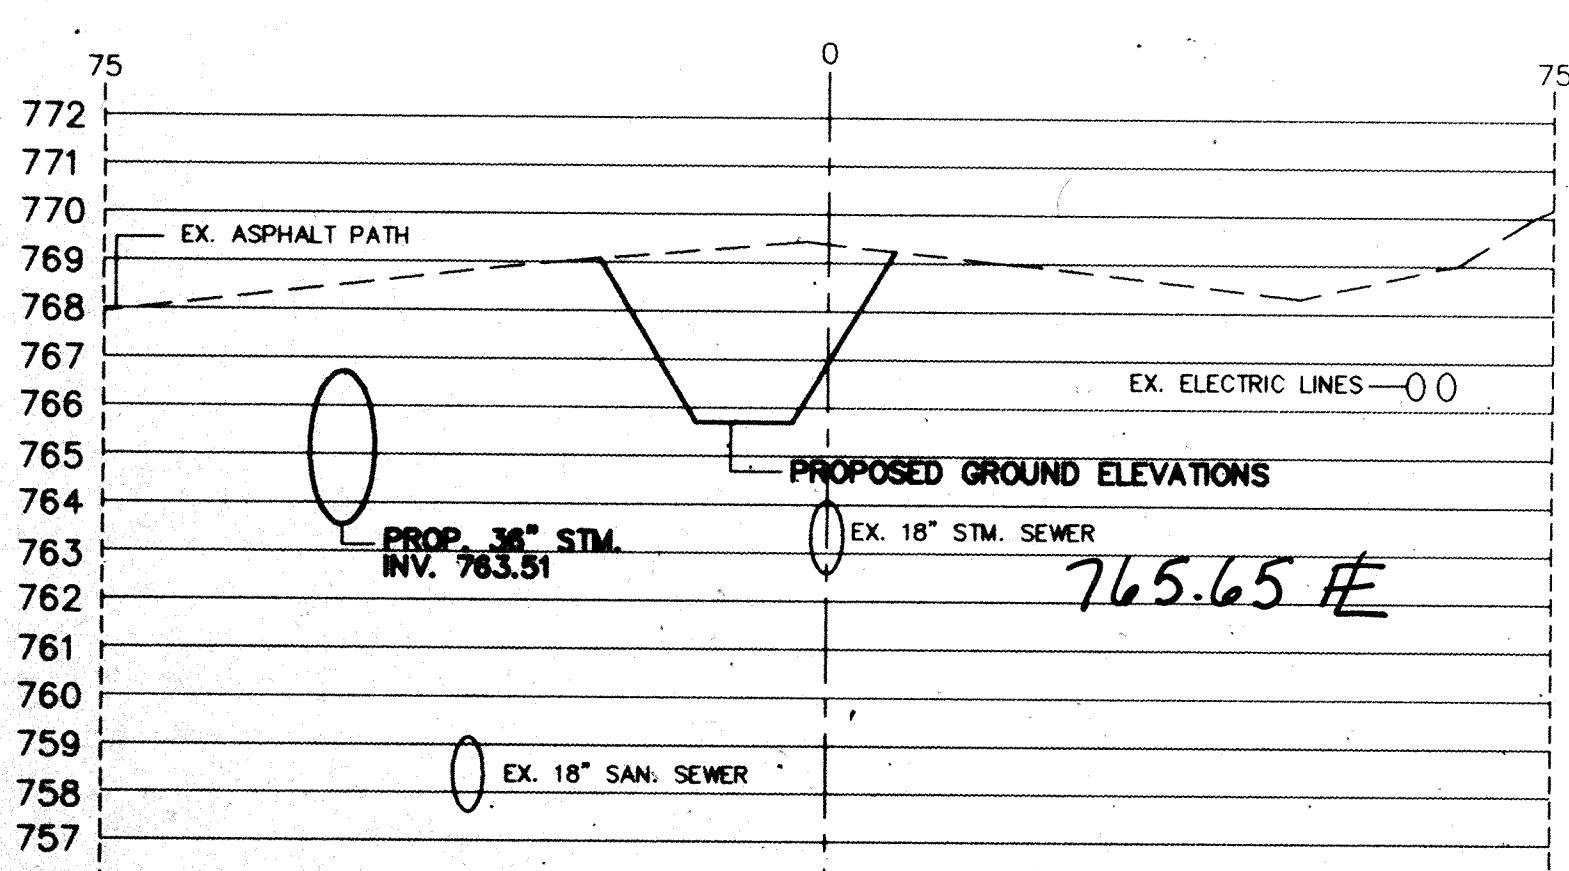

STATION 22+00

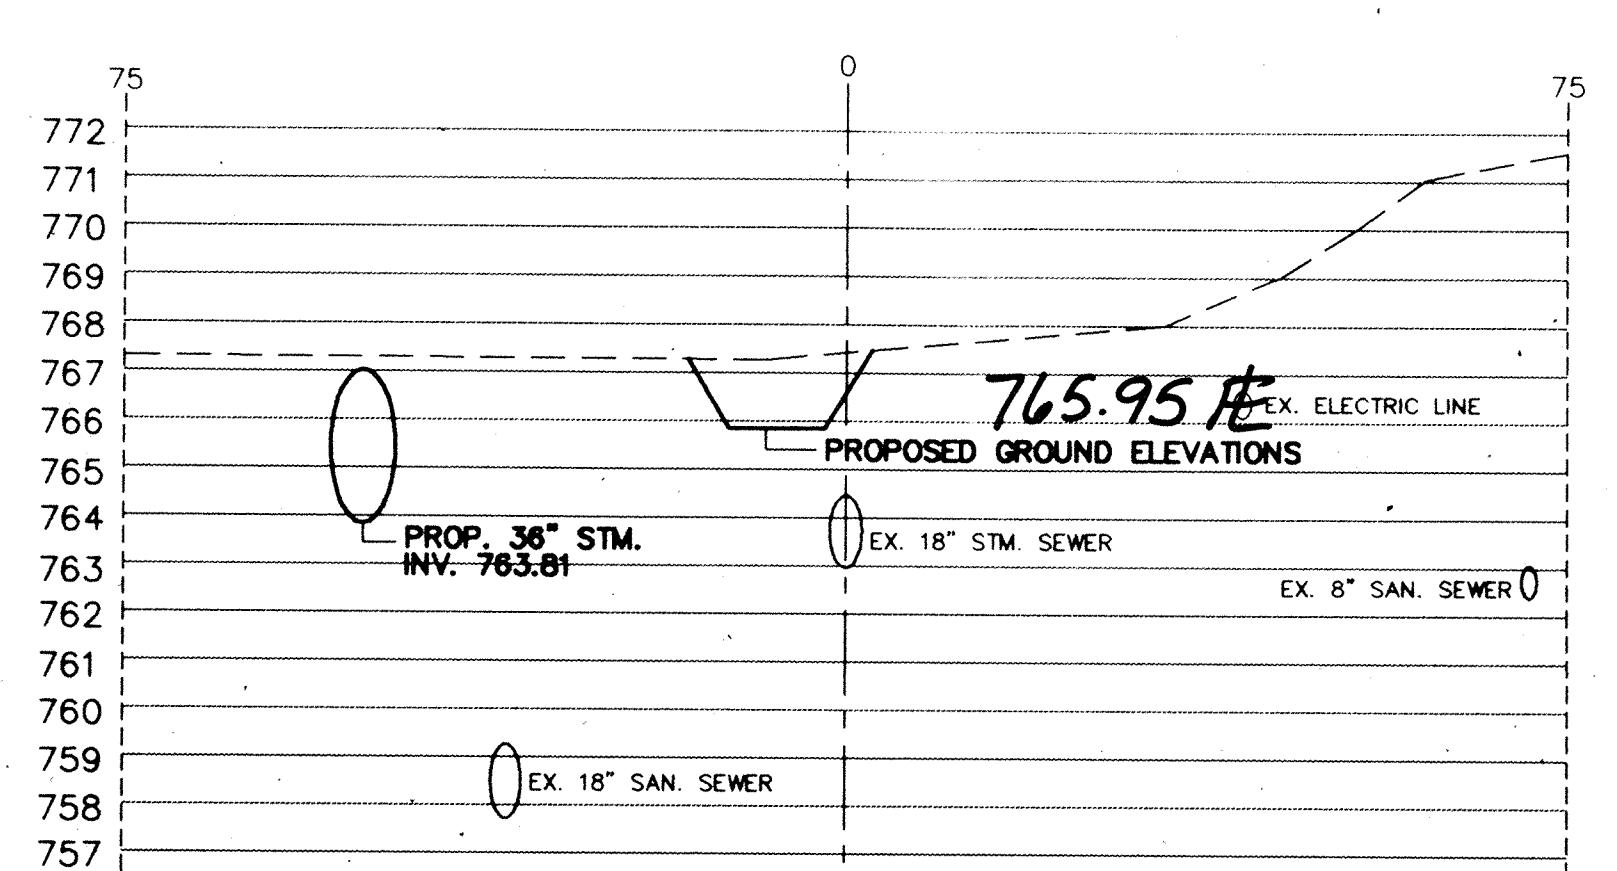

STATION 24+00

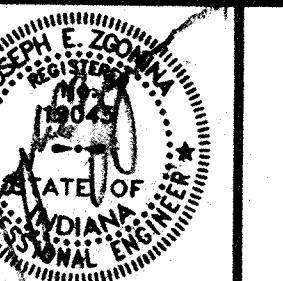

COPIE E
ZONED
1993
STATE OF
INDIANA
PROJECT ENGINEER

CERTIFIED BY

PRINCIPAL

PROJECT ENGINEER

CERTIFIED BY

PROJECT DESIGNER

REVISIONS

MARK	DATE	DESCRIPTION
9-1-93	PER OFFICE REVIEW	
11-15-93	OFFICE REVIEW	
1-28-97	RECORD DRAWINGS	

NOBLESVILLE HIGH SCHOOL OFF-SITE

ELWOOD WILSON DRAINAGE EASEMENT – CHERRY STREET TO MONUMENT STREET
NOBLESVILLE, INDIANA

marchris/moore associates
of indiana
consulting engineers
9245 North Meridian Street
Suite 105
Indianapolis, In 46260-1812
(317) 843-2520 FAX 848-2765

Post Construction Survey



FILED


FEB 19 1997

OFFICE OF HAMILTON COUNTY SURVEYOR


TITLE:
CROSS SECTIONS
STATION 25+50 TO
STATION 30+00

DATE 7-22-93 SHEET NO.
SCALE 1"-20'(HORIZ)
1"-4'(VERT)
JOB NO. 93-011
DRAWN BY S.WEBER
13 of 20


EXISTING 150' ELWOOD WILSON DRAINAGE EASEMENT (TYPICAL)

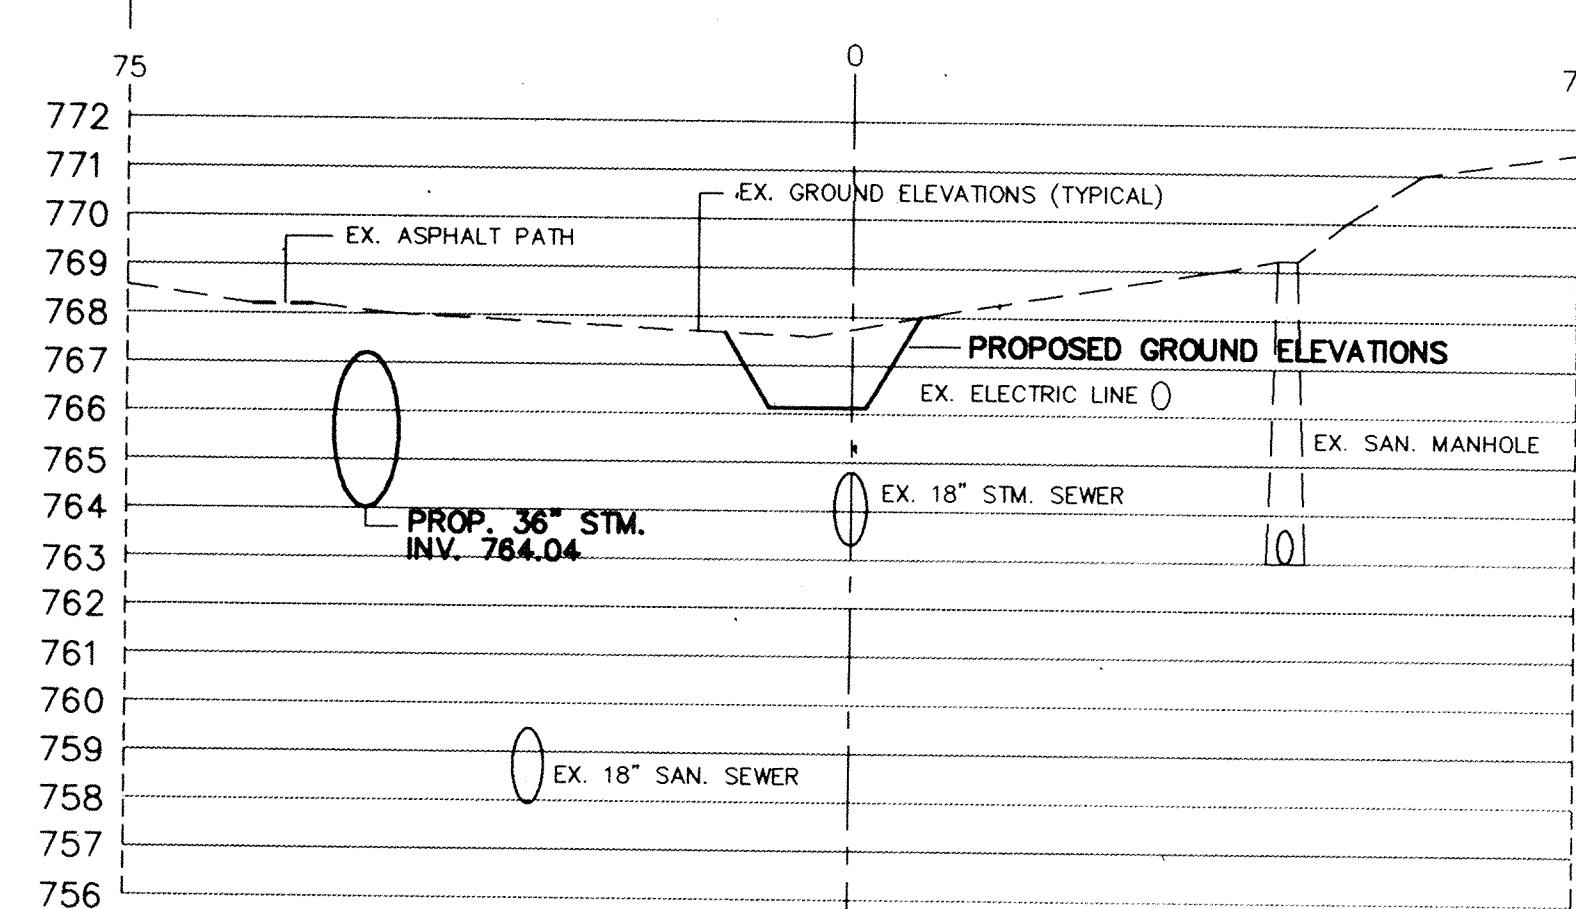


STATION 25+50

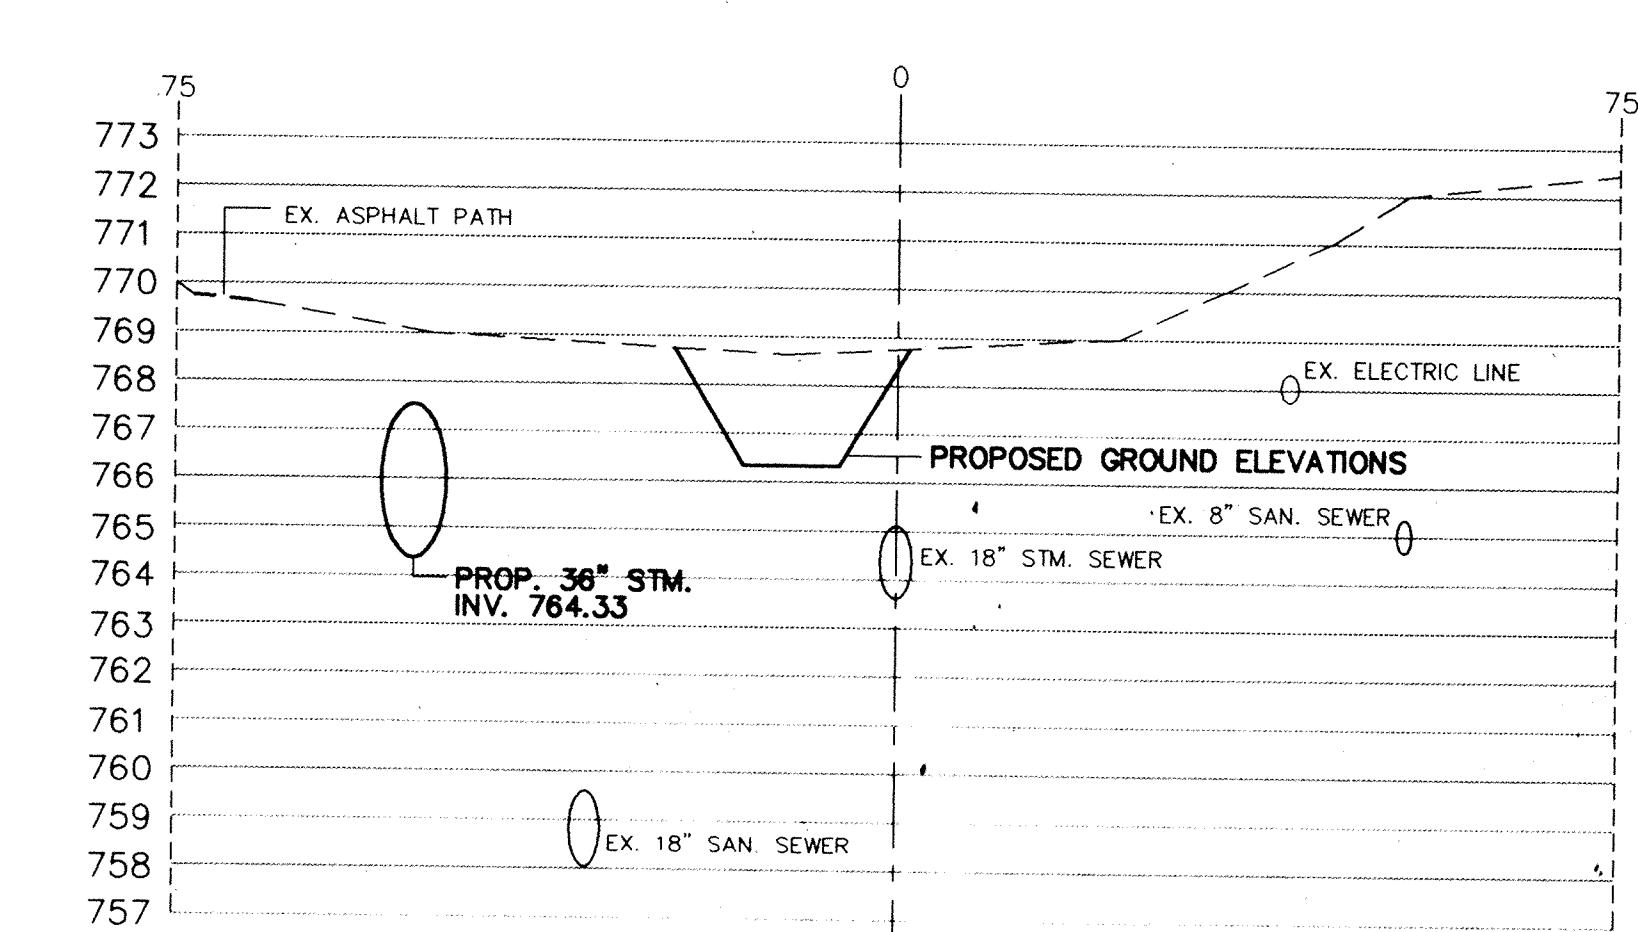


STATION 27+50

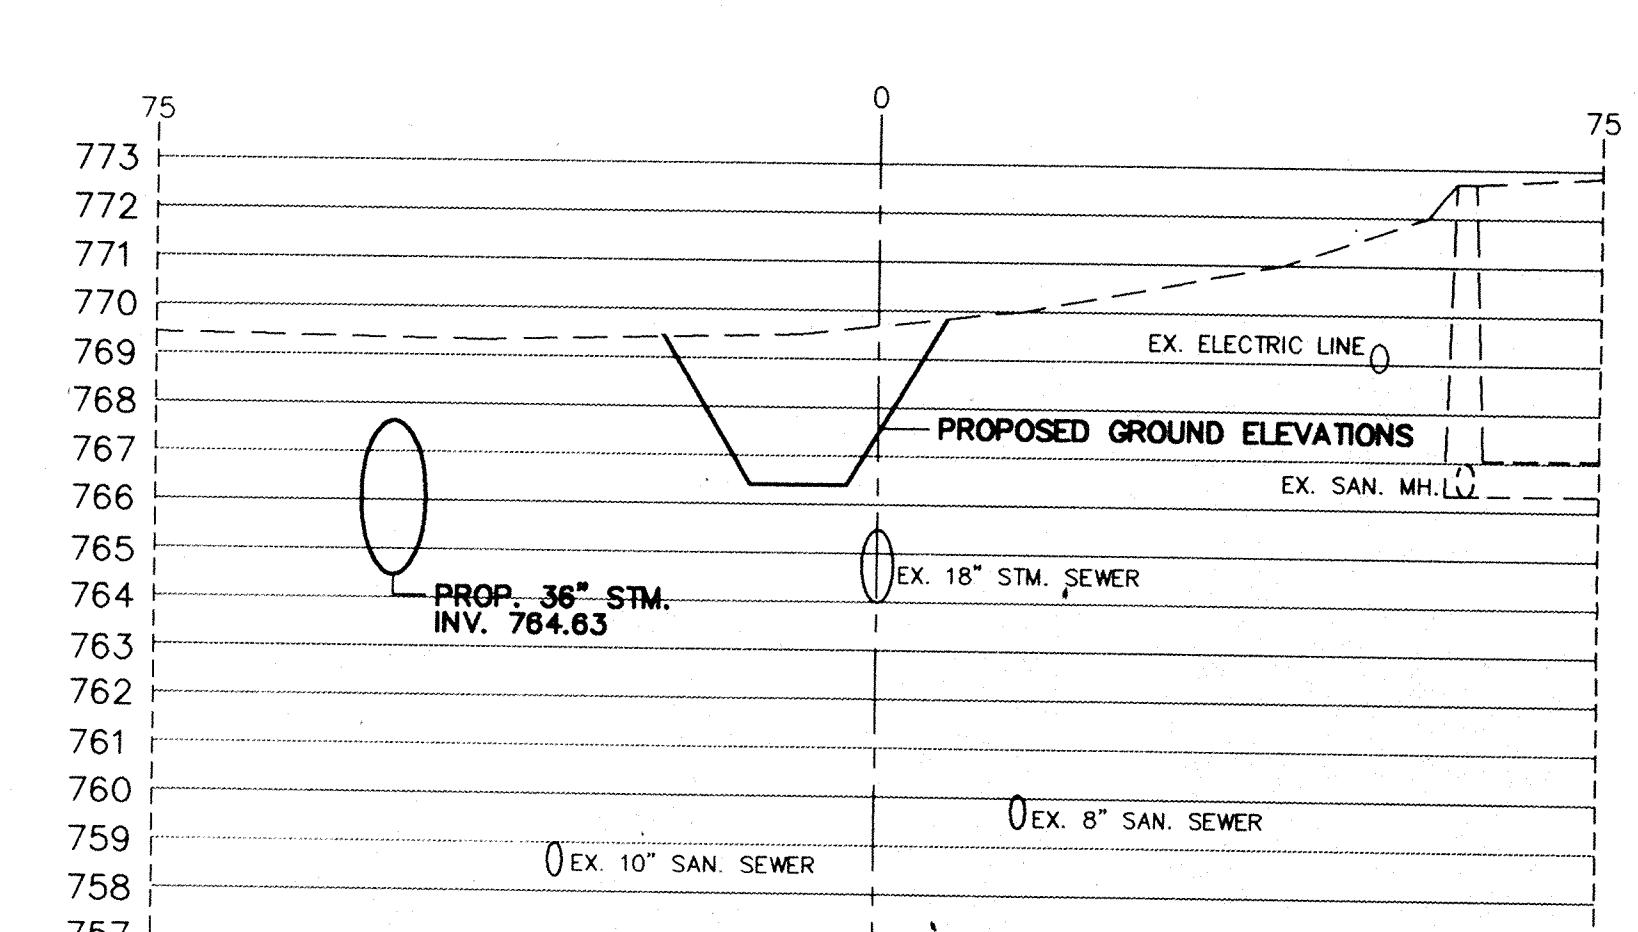


STATION 29+50

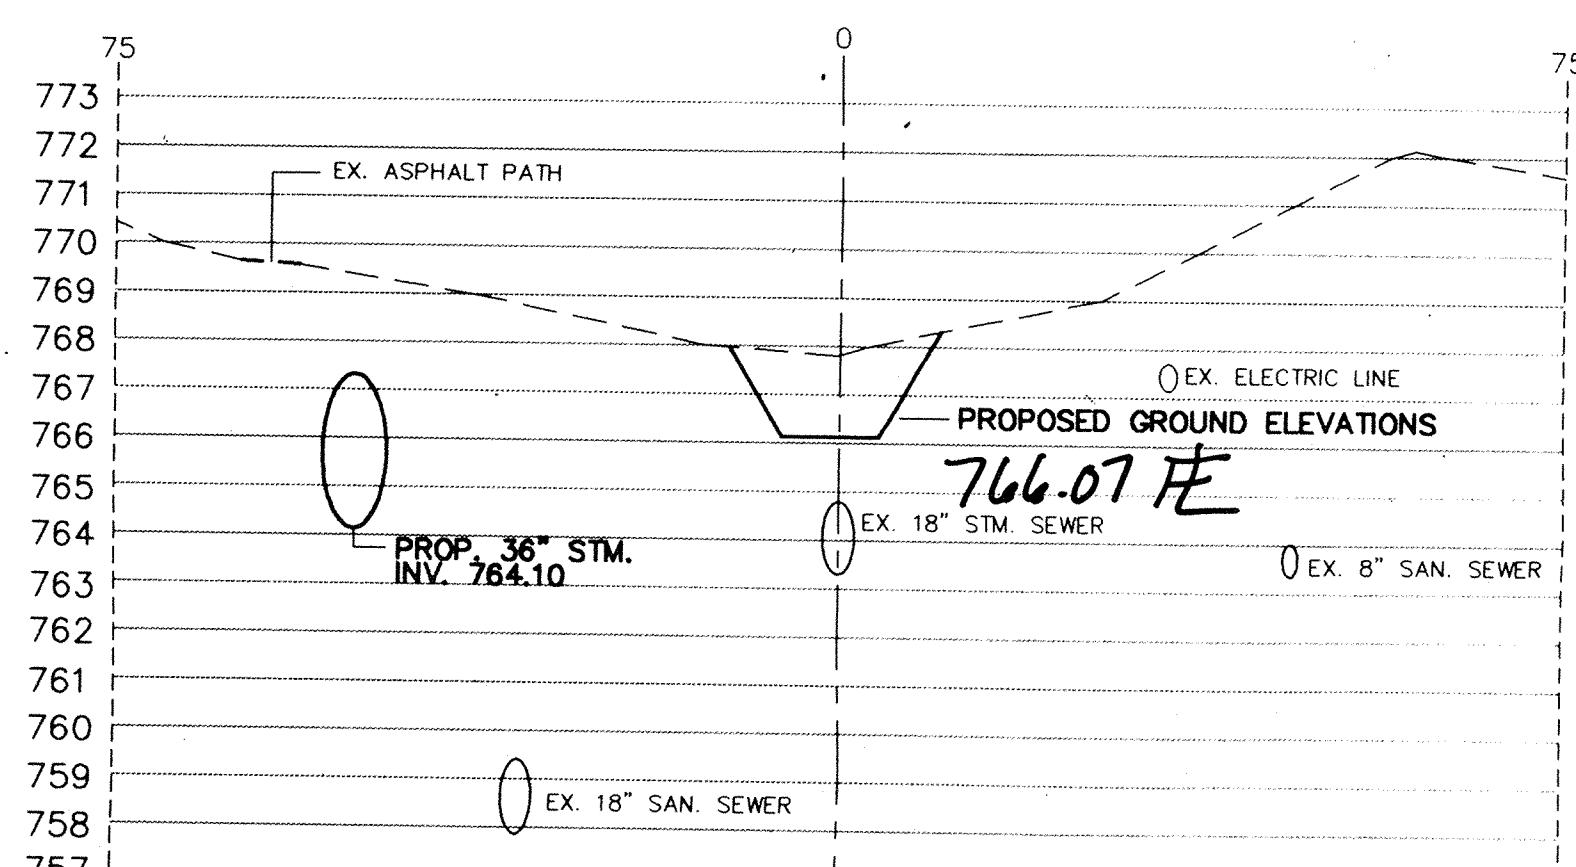


STATION 26+00

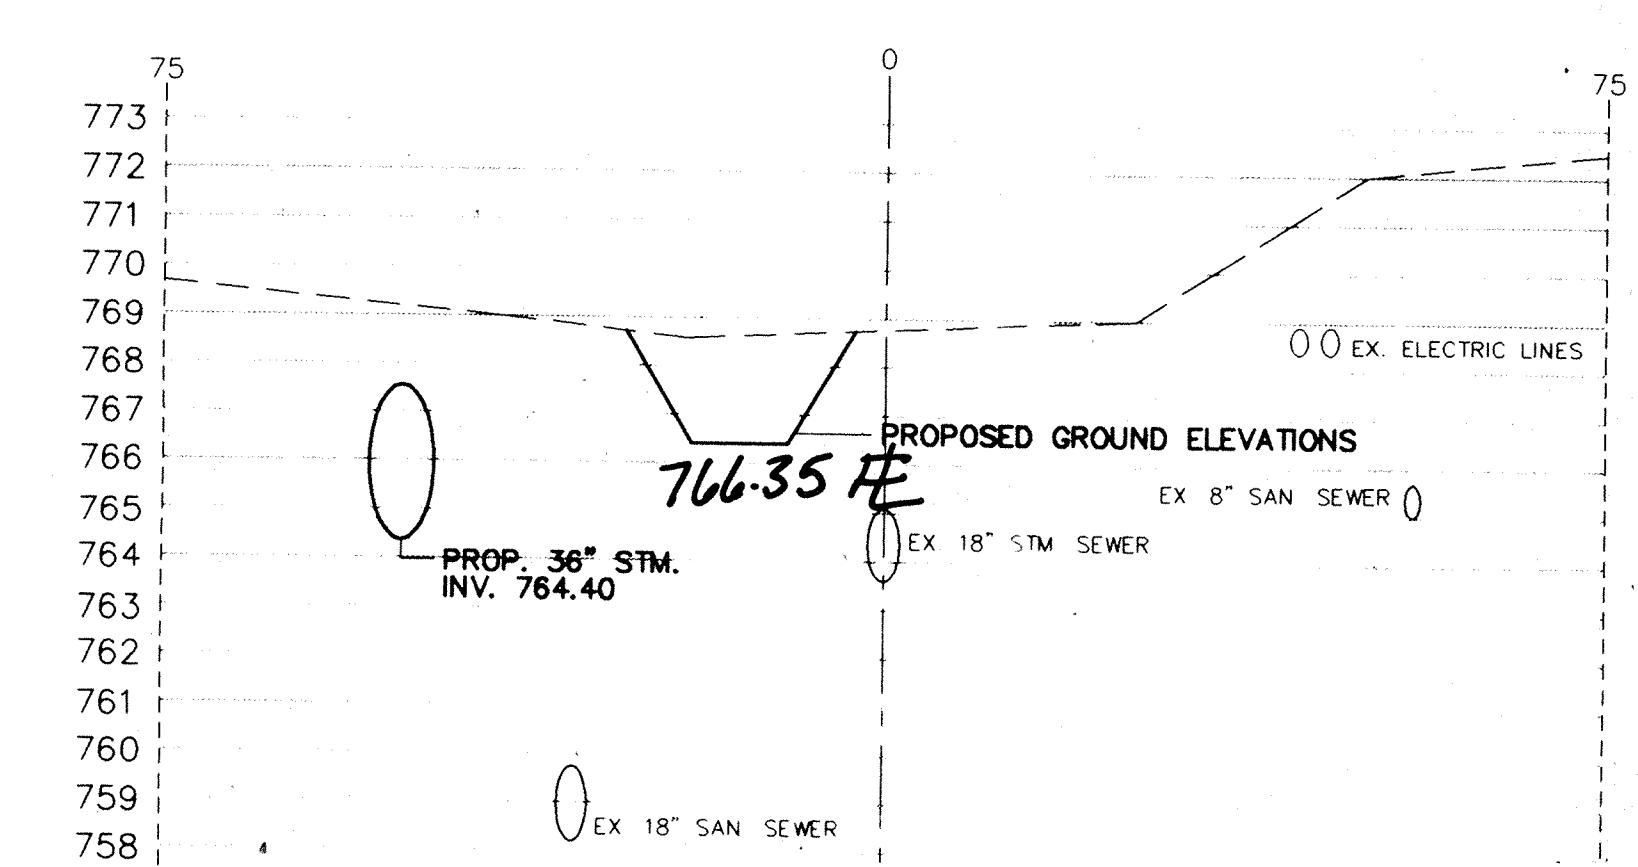


STATION 28+00

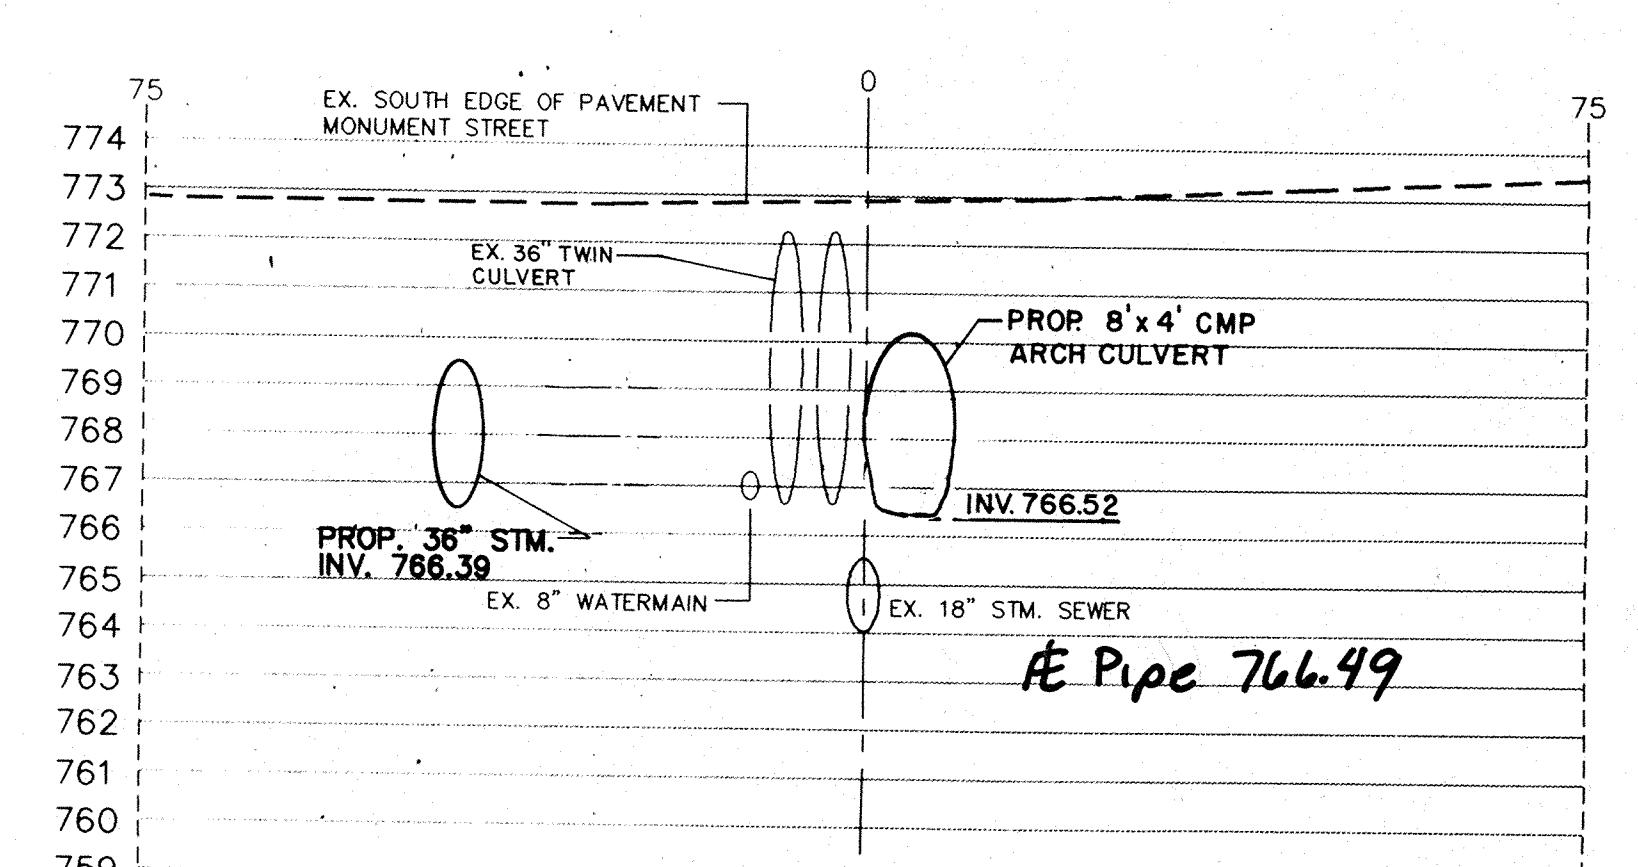


STATION 30+00
29+91

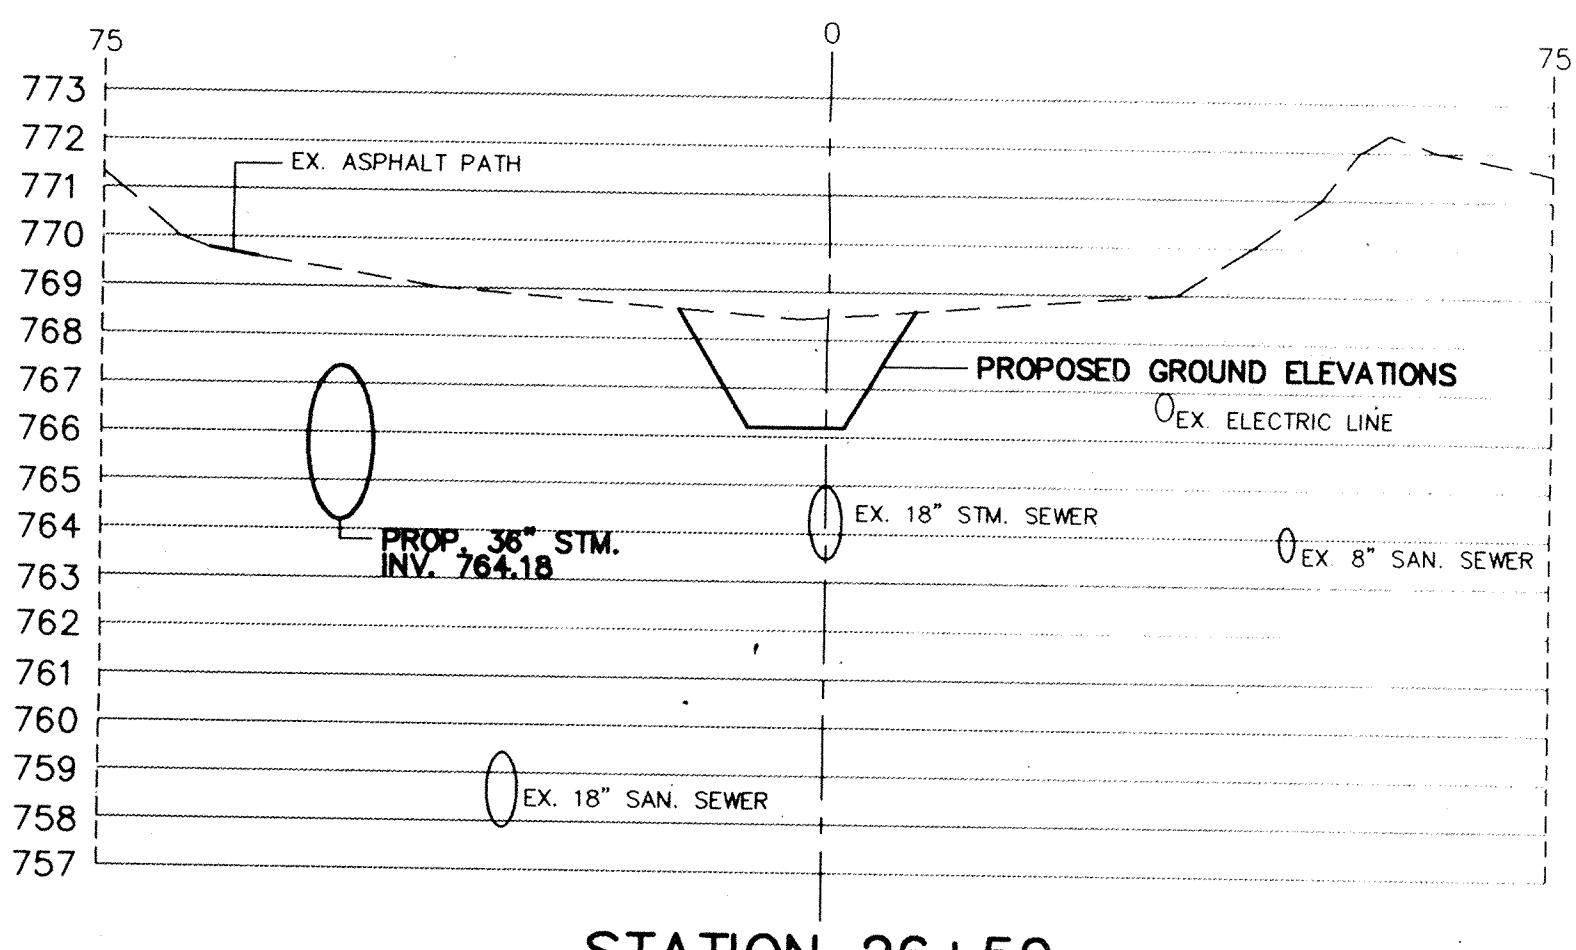


STATION 26+50

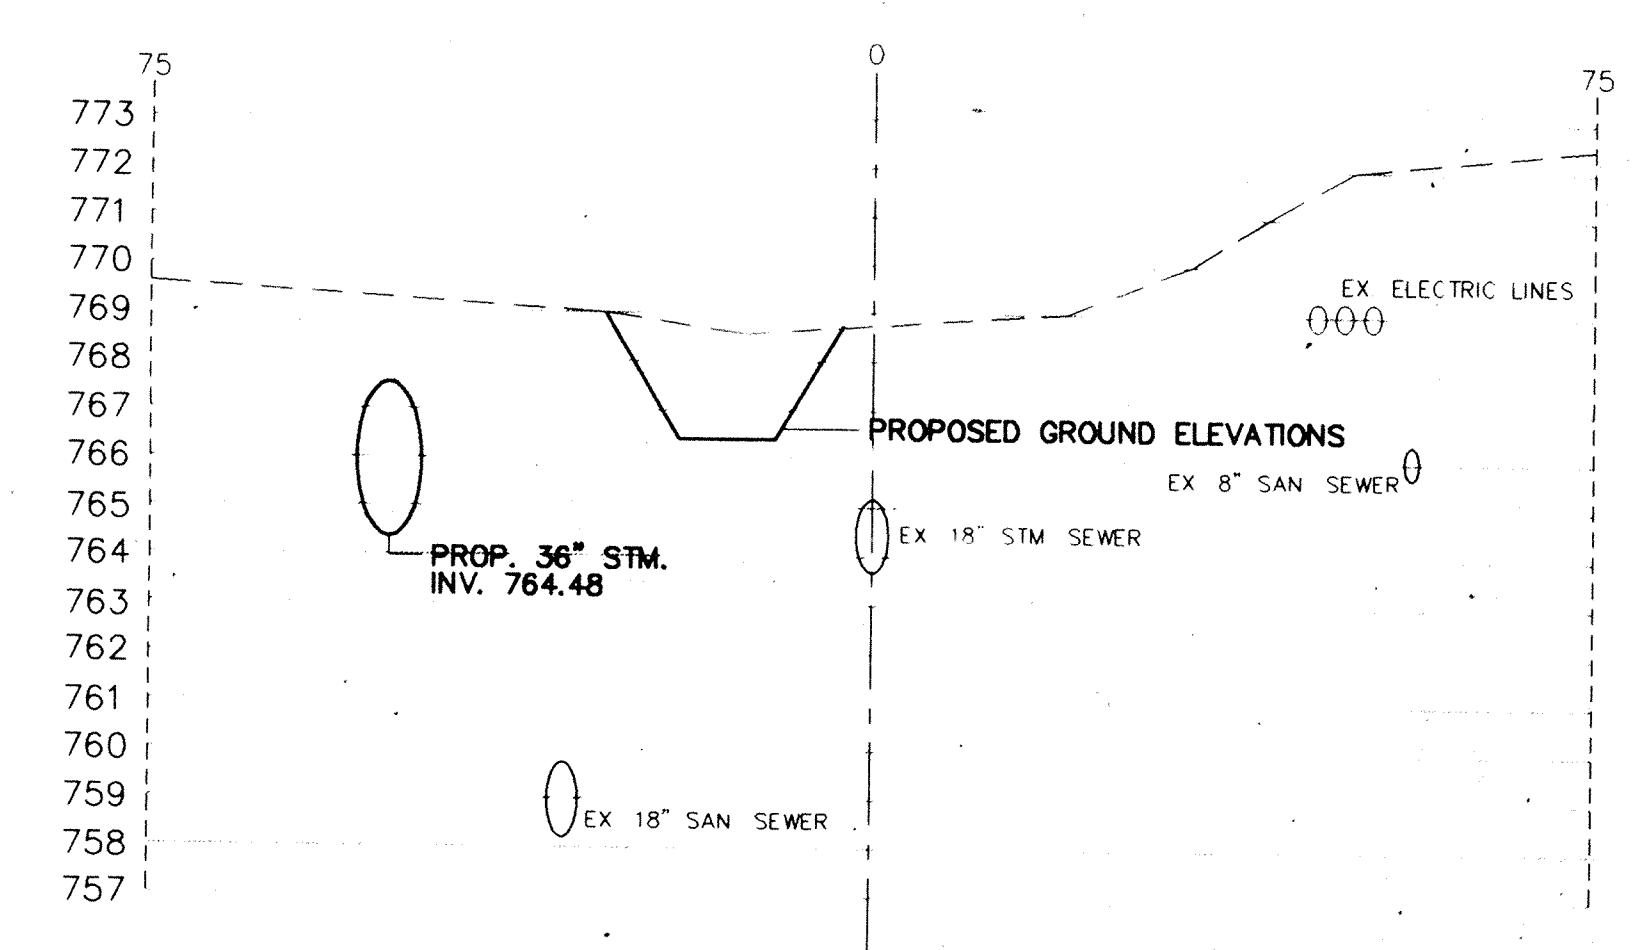


STATION 28+50

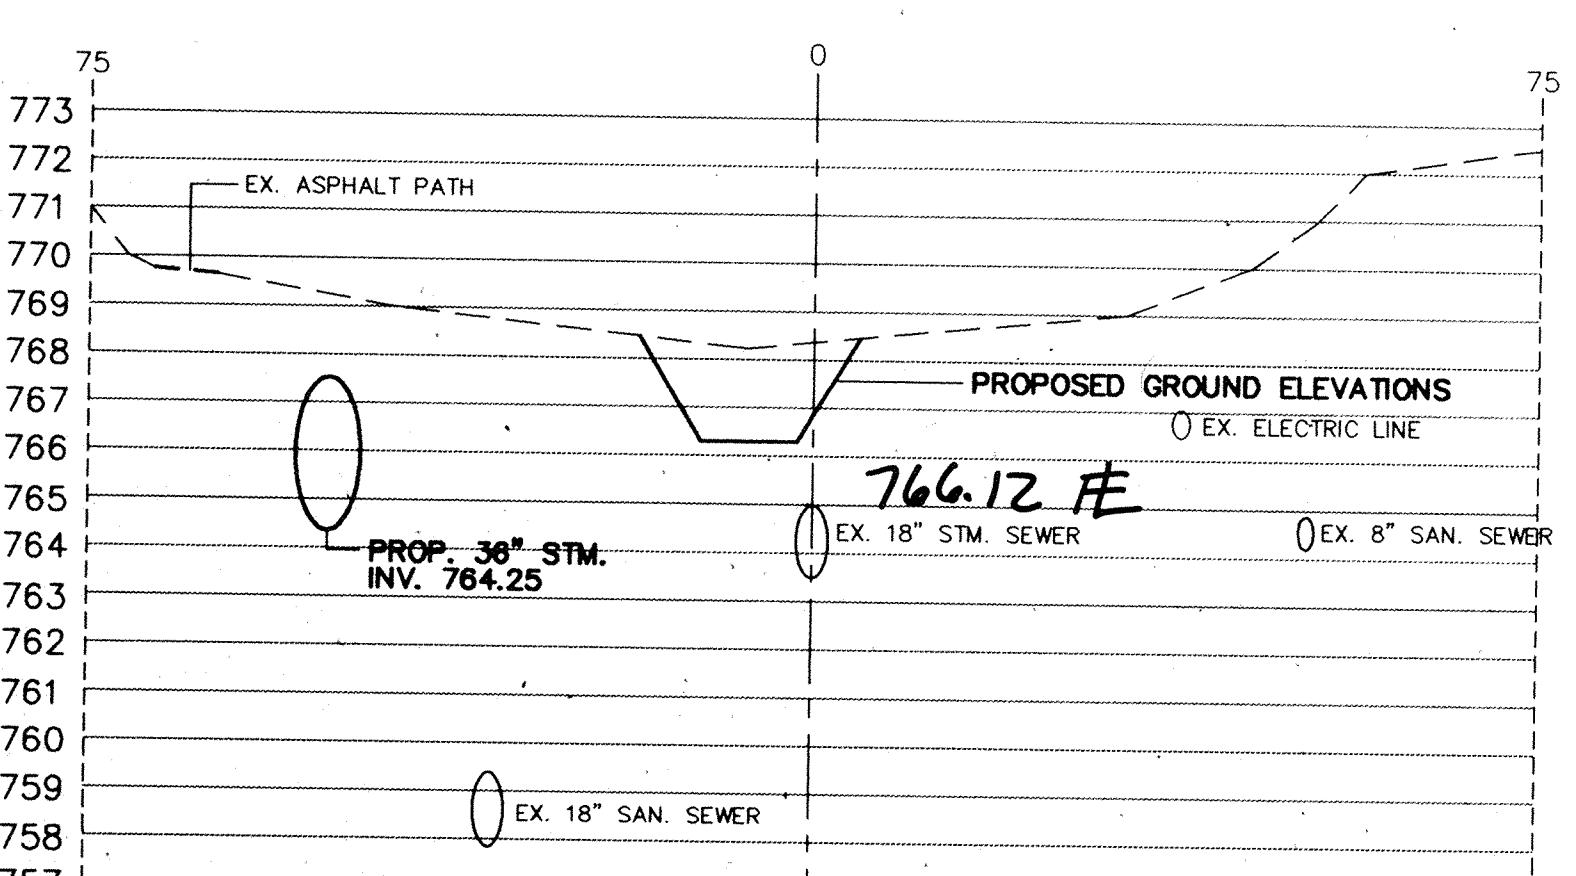

STATION 27+00

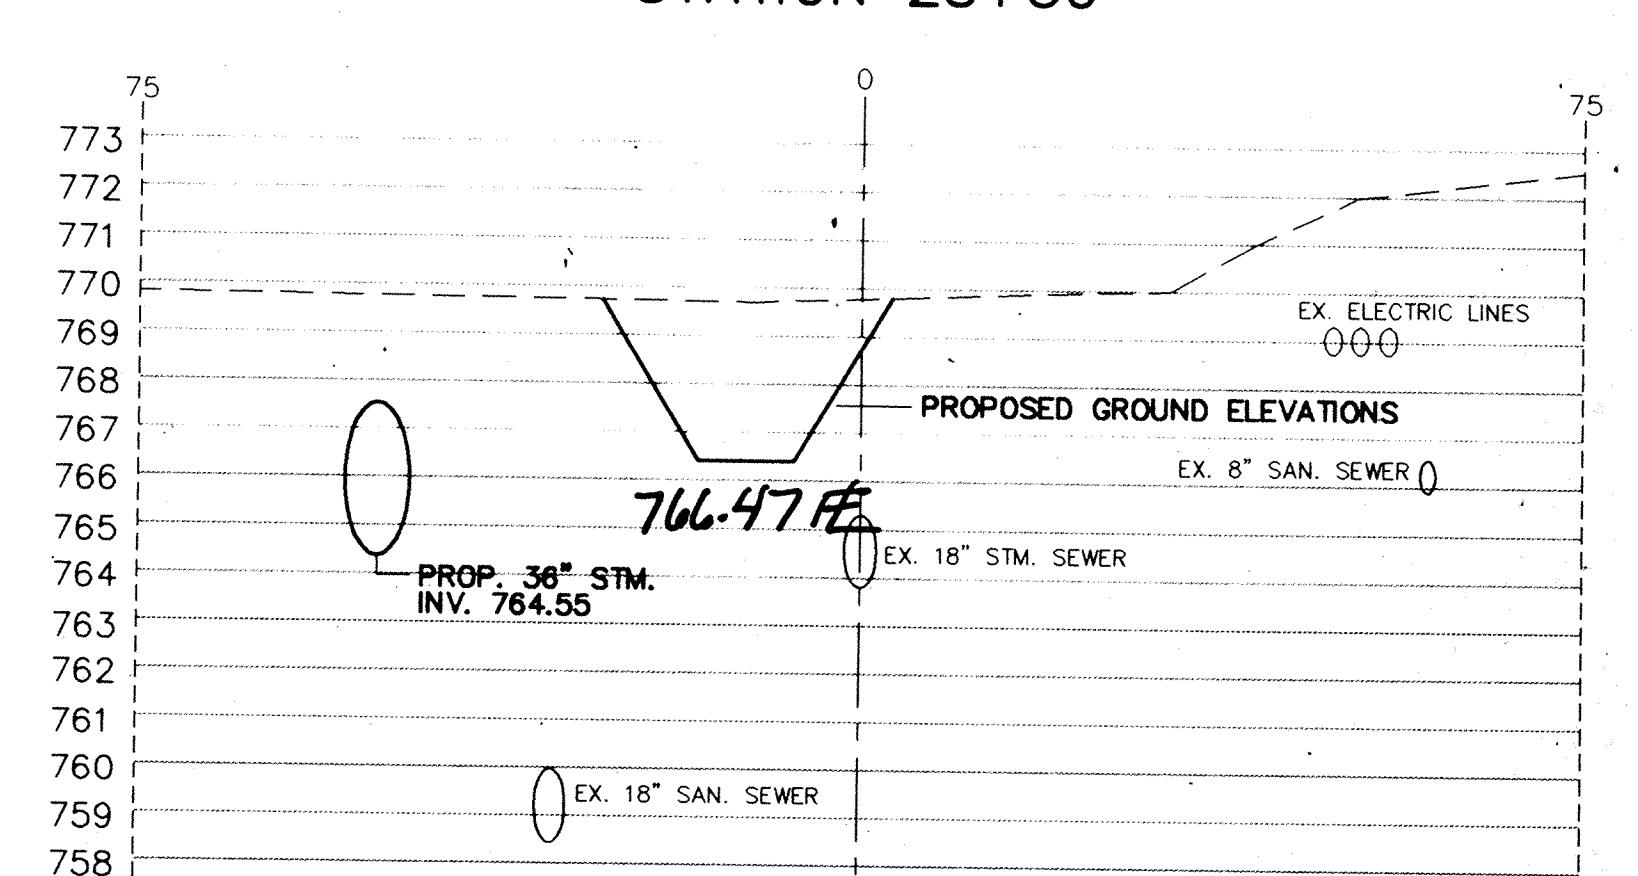

STATION 29+00

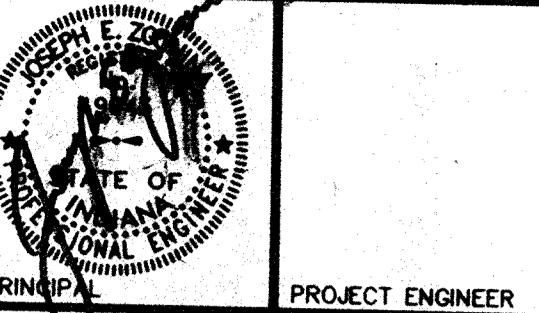

PRINCIPAL PROJECT ENGINEER

CERTIFIED BY

PRINCIPAL

PROJECT ENGINEER

CERTIFIED BY

PROJECT DESIGNER

REVISIONS

MARK DATE DESCRIPTION

9-1-93 PER OFFICE REVIEW

11-15-93 OFFICE REVIEW

12-3-93 RECORD DRAWINGS

NOBLESVILLE HIGH SCHOOL OFF-SITE

ELWOOD WILSON DRAINAGE EASEMENT IMPROVEMENTS - CHERRY STREET TO MONUMENT STREET NOBLESVILLE, INDIANA

marchris/moore associates
of indiana

consulting engineers

9245 North Meridian Street
Suite 105
Indianapolis, In 46260-1812
(317) 843-2520 FAX 848-2765

EX. MASONRY/FRAME BUILDING

CHERRY STREET

FILED

FEB 19 1997

OFFICE OF HAMILTON COUNTY SURVEYOR

TITLE:

CHERRY STREET

DATE

9-2-93

SHEET NO.

SCALE

1"-10'


JOB NO.


93-011

14 of 20

DRAWN BY

S.WEBER

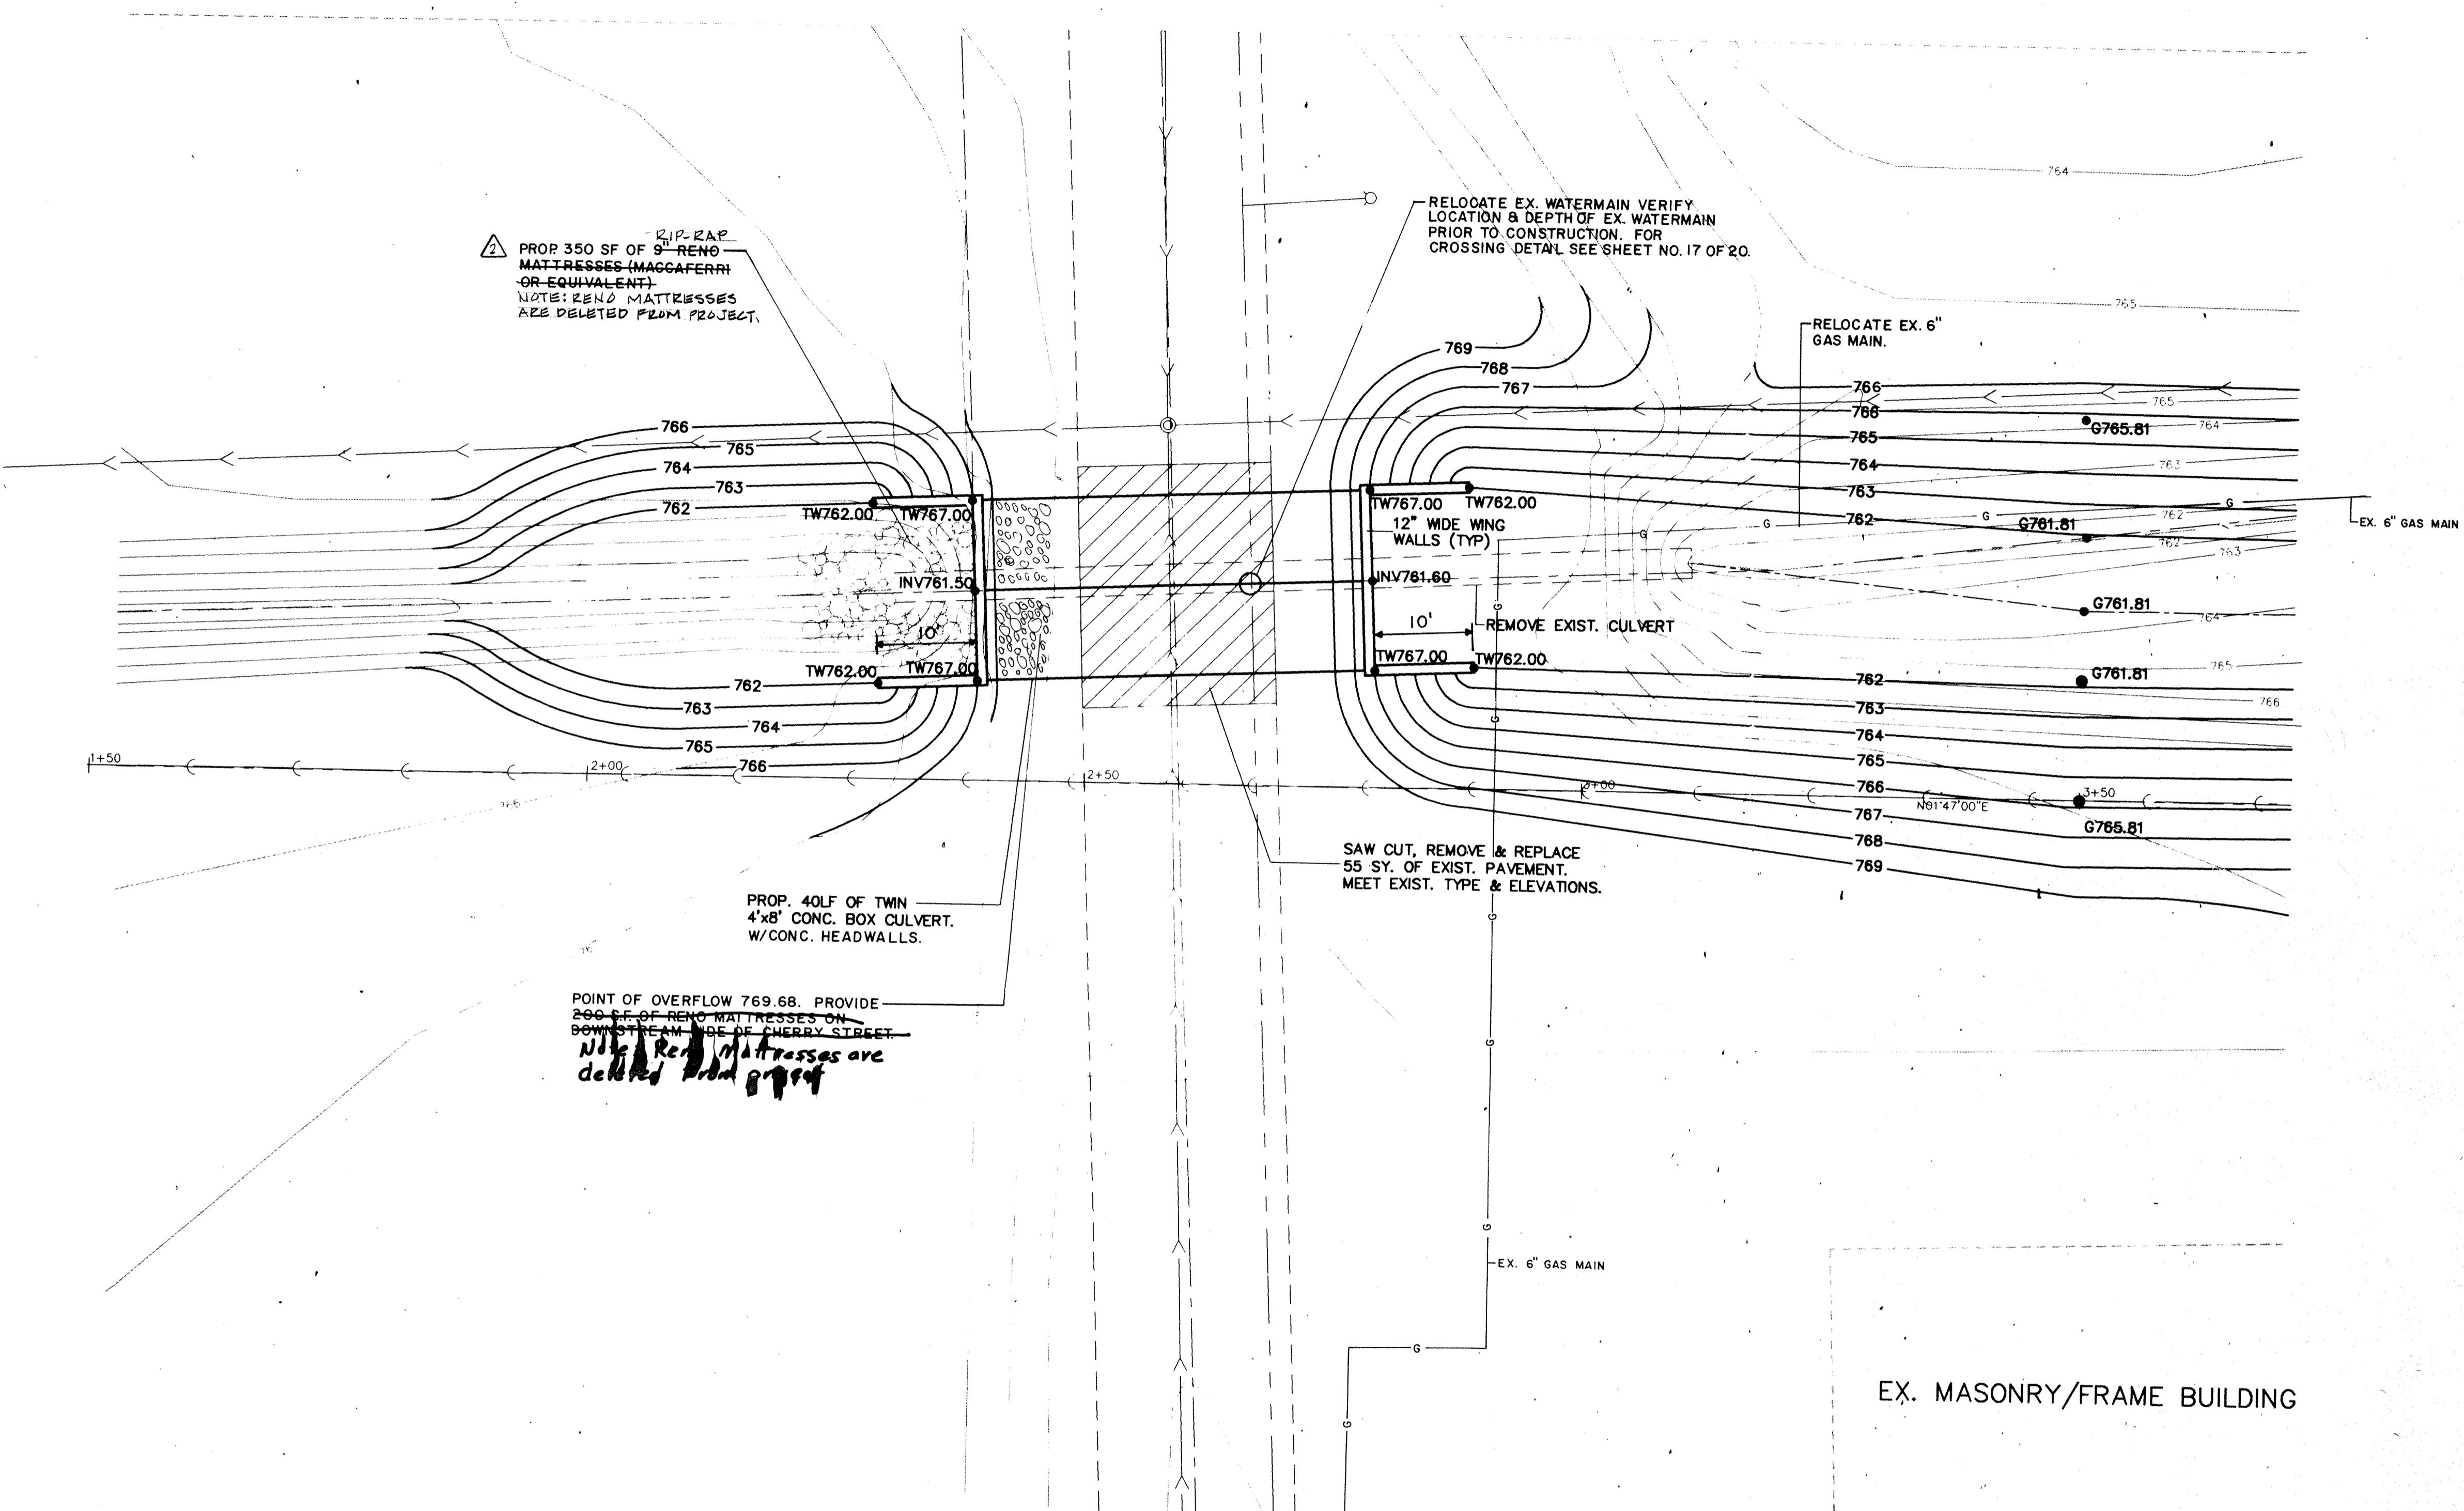

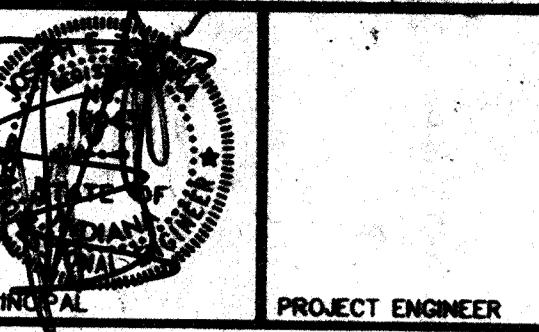

PROJECT ENGINEER

CERTIFIED BY

PRINCIPAL

PROJECT ENGINEER

CERTIFIED BY

PROJECT DESIGNER


REVISIONS


MARK DATE DESCRIPTION

9-19-93 PER OFFICE REVIEW

11-15-93 OFFICE REVIEW

1-28-97 RECORD DRAWINGS

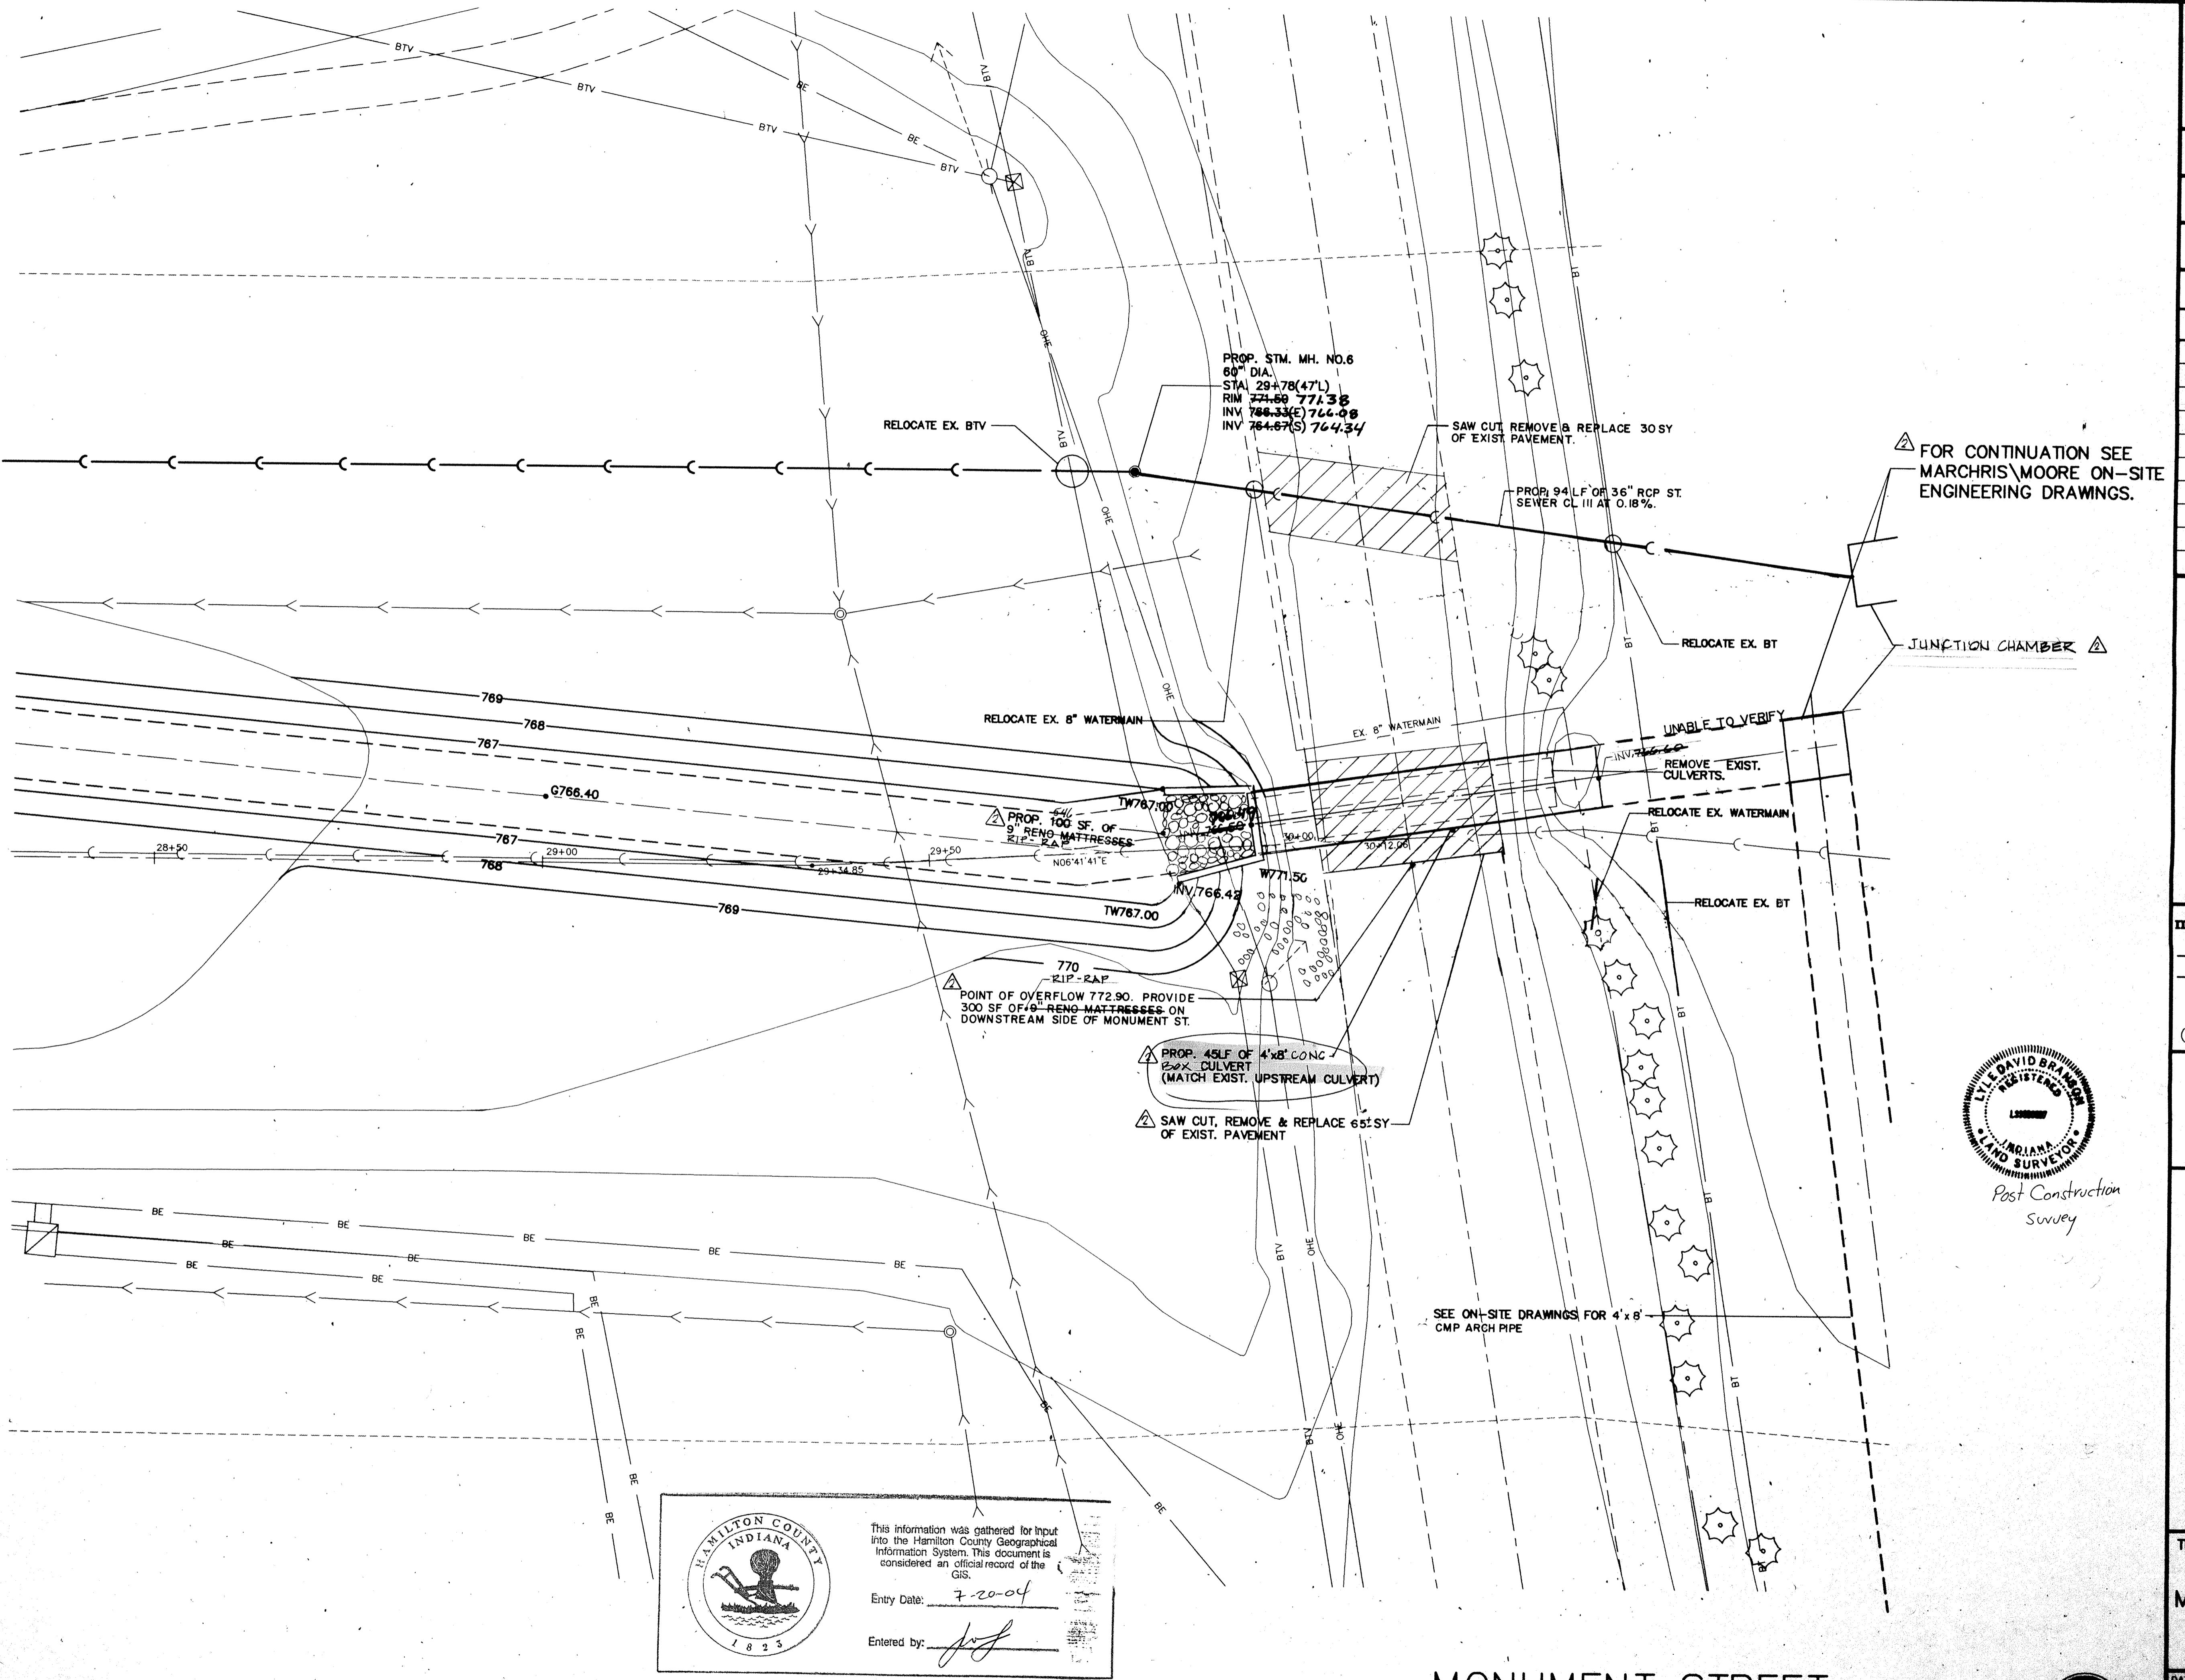


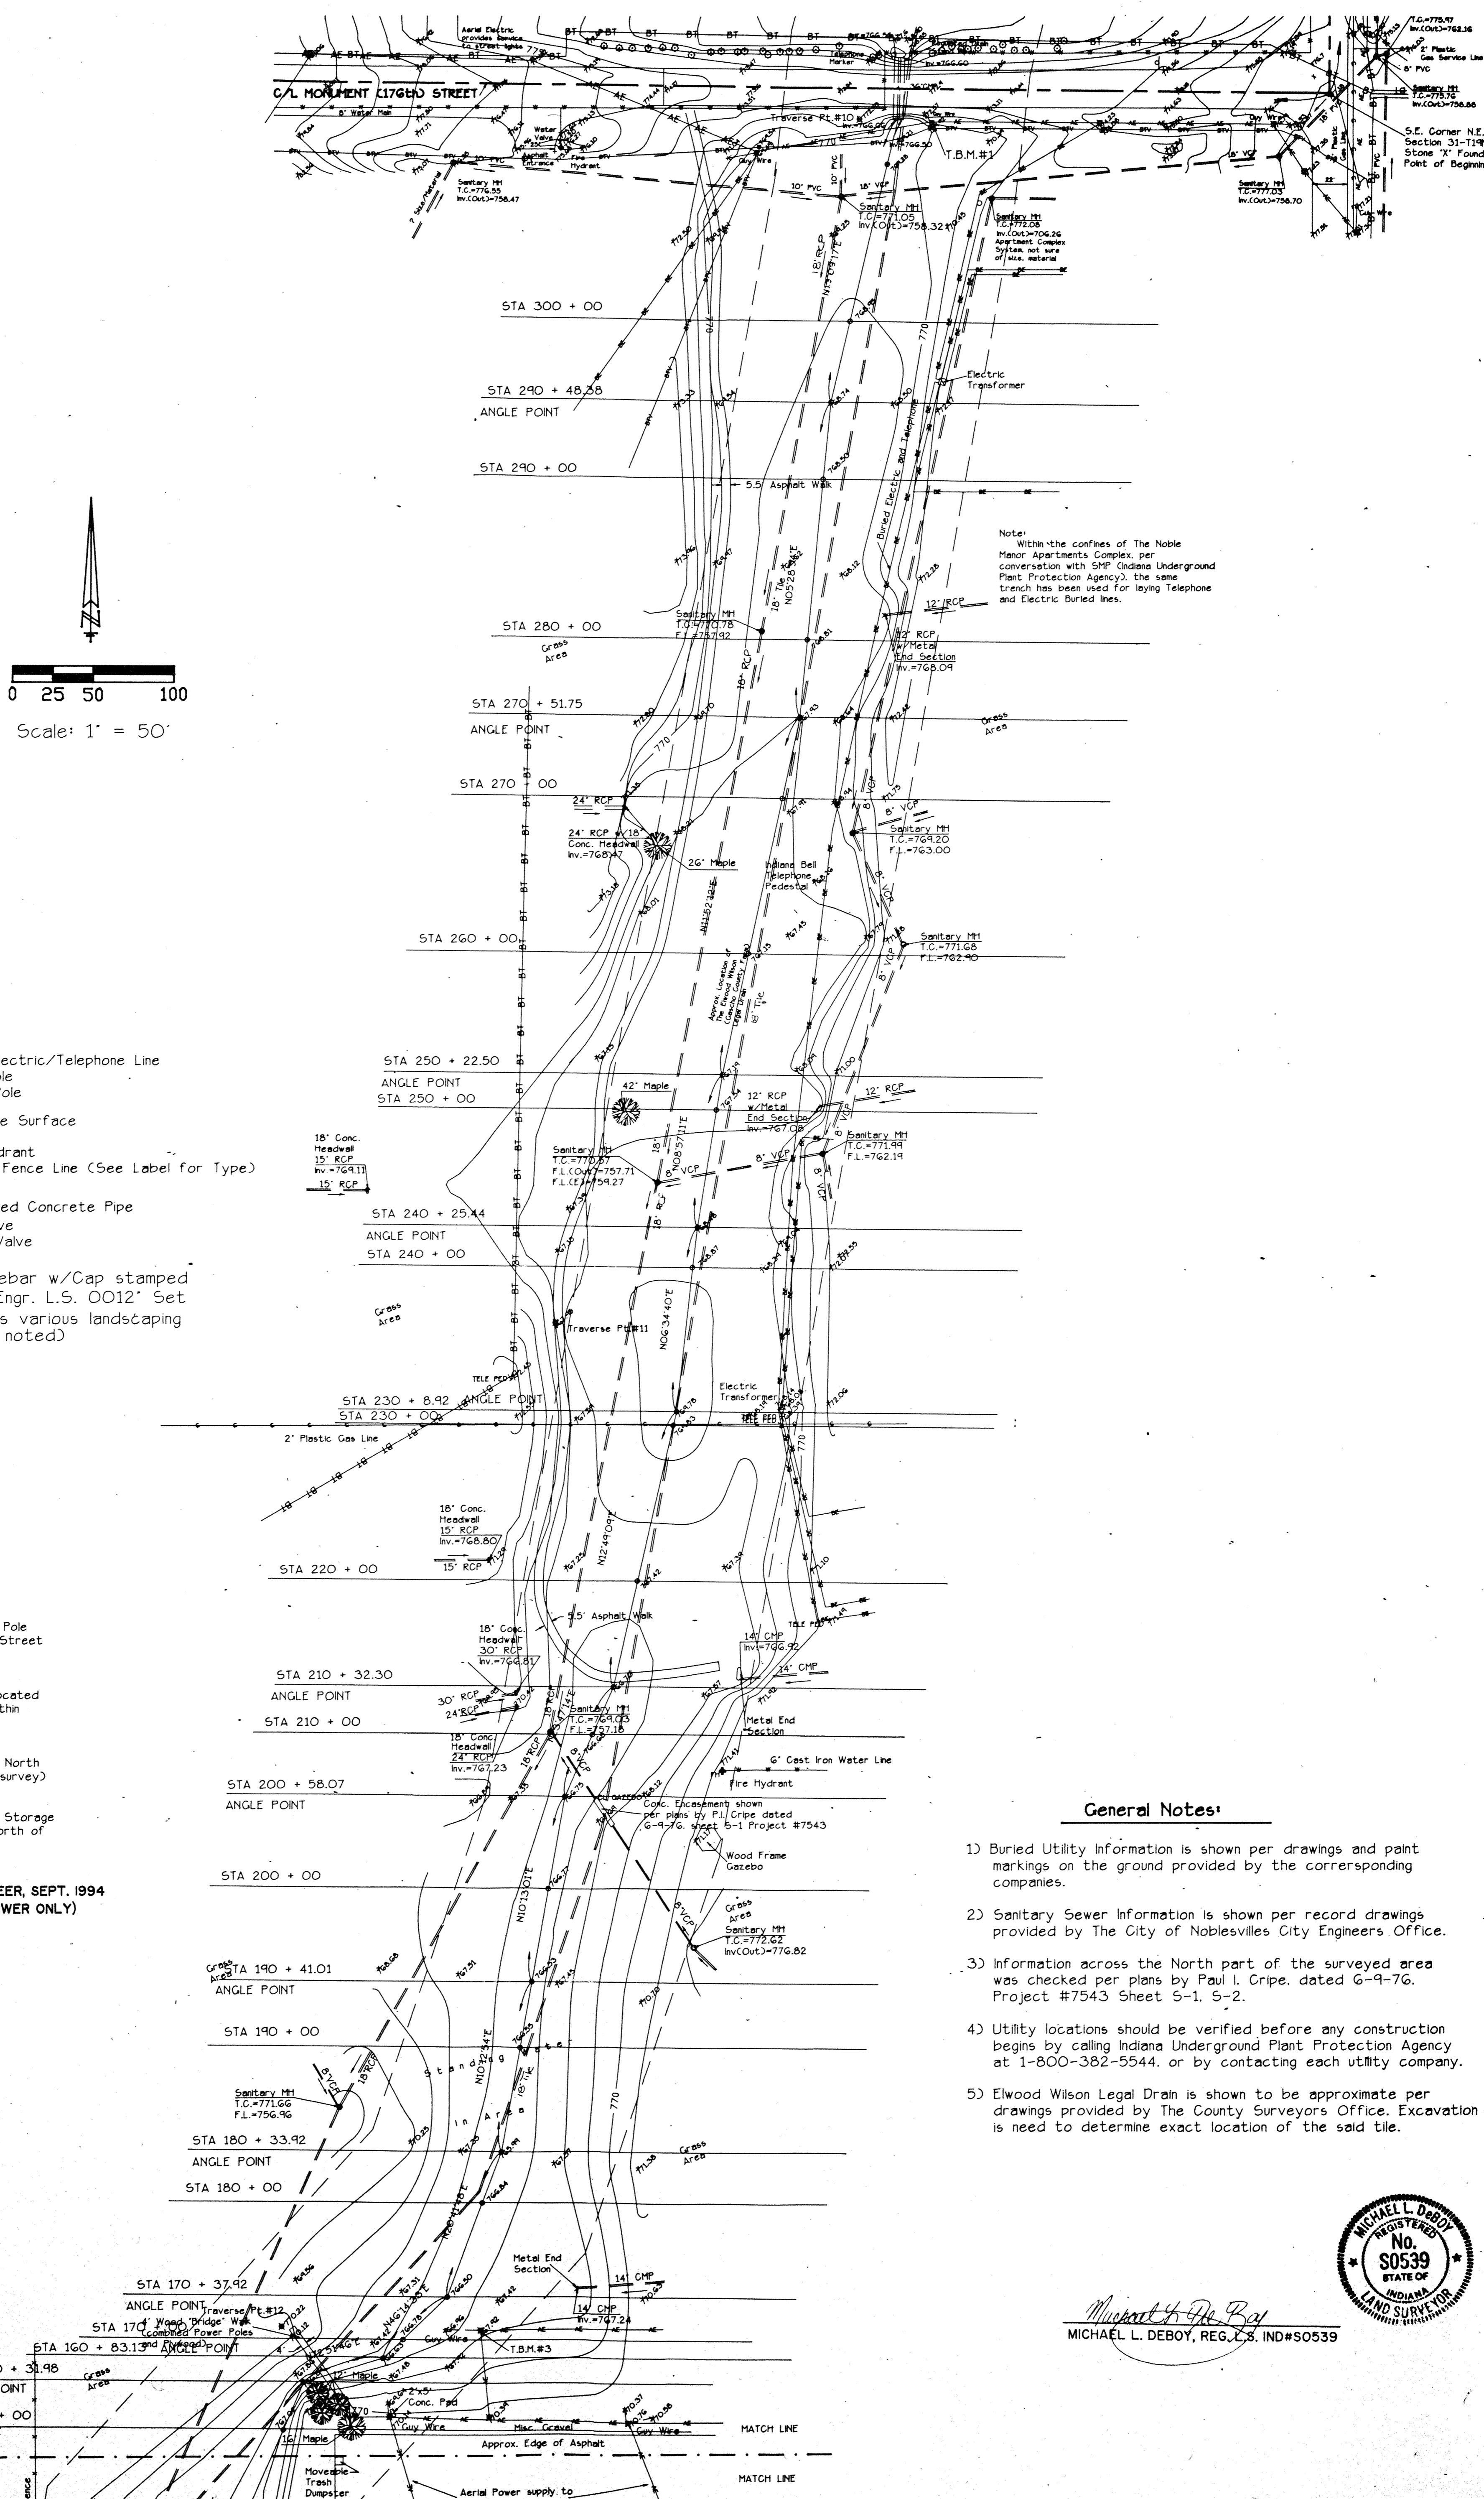

Prepared For:
Noblesville School Corp.

AIA/Situation/Topographic Survey
Pt. Sec 31-T19N-R5E. Noblesville Twp., Hamilton Co., IN

REVISIONS	DATE	BY	JOB NO.
			92-128
DRAWN BY			M.W.
CHECKED BY			M.L.D.
DATE			
F.B. 533	PAGE 7	#	2-15-94

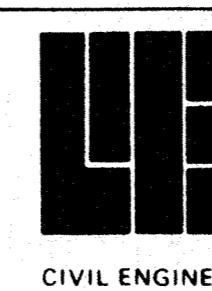


WEIHE ENGINEERS INC.
10505 NORTH COLLEGE AVENUE
INDIANAPOLIS, INDIANA 46280
(317) 846-6611
CIVIL ENGINEERS
LAND SURVEYORS
LAND PLANNERS

ALAN H. WEIHE, P.E., L.S.
PRESIDENT



Michael L. DeBoy
MICHAEL L. DEBOY, REG. L.S. IND#S0539

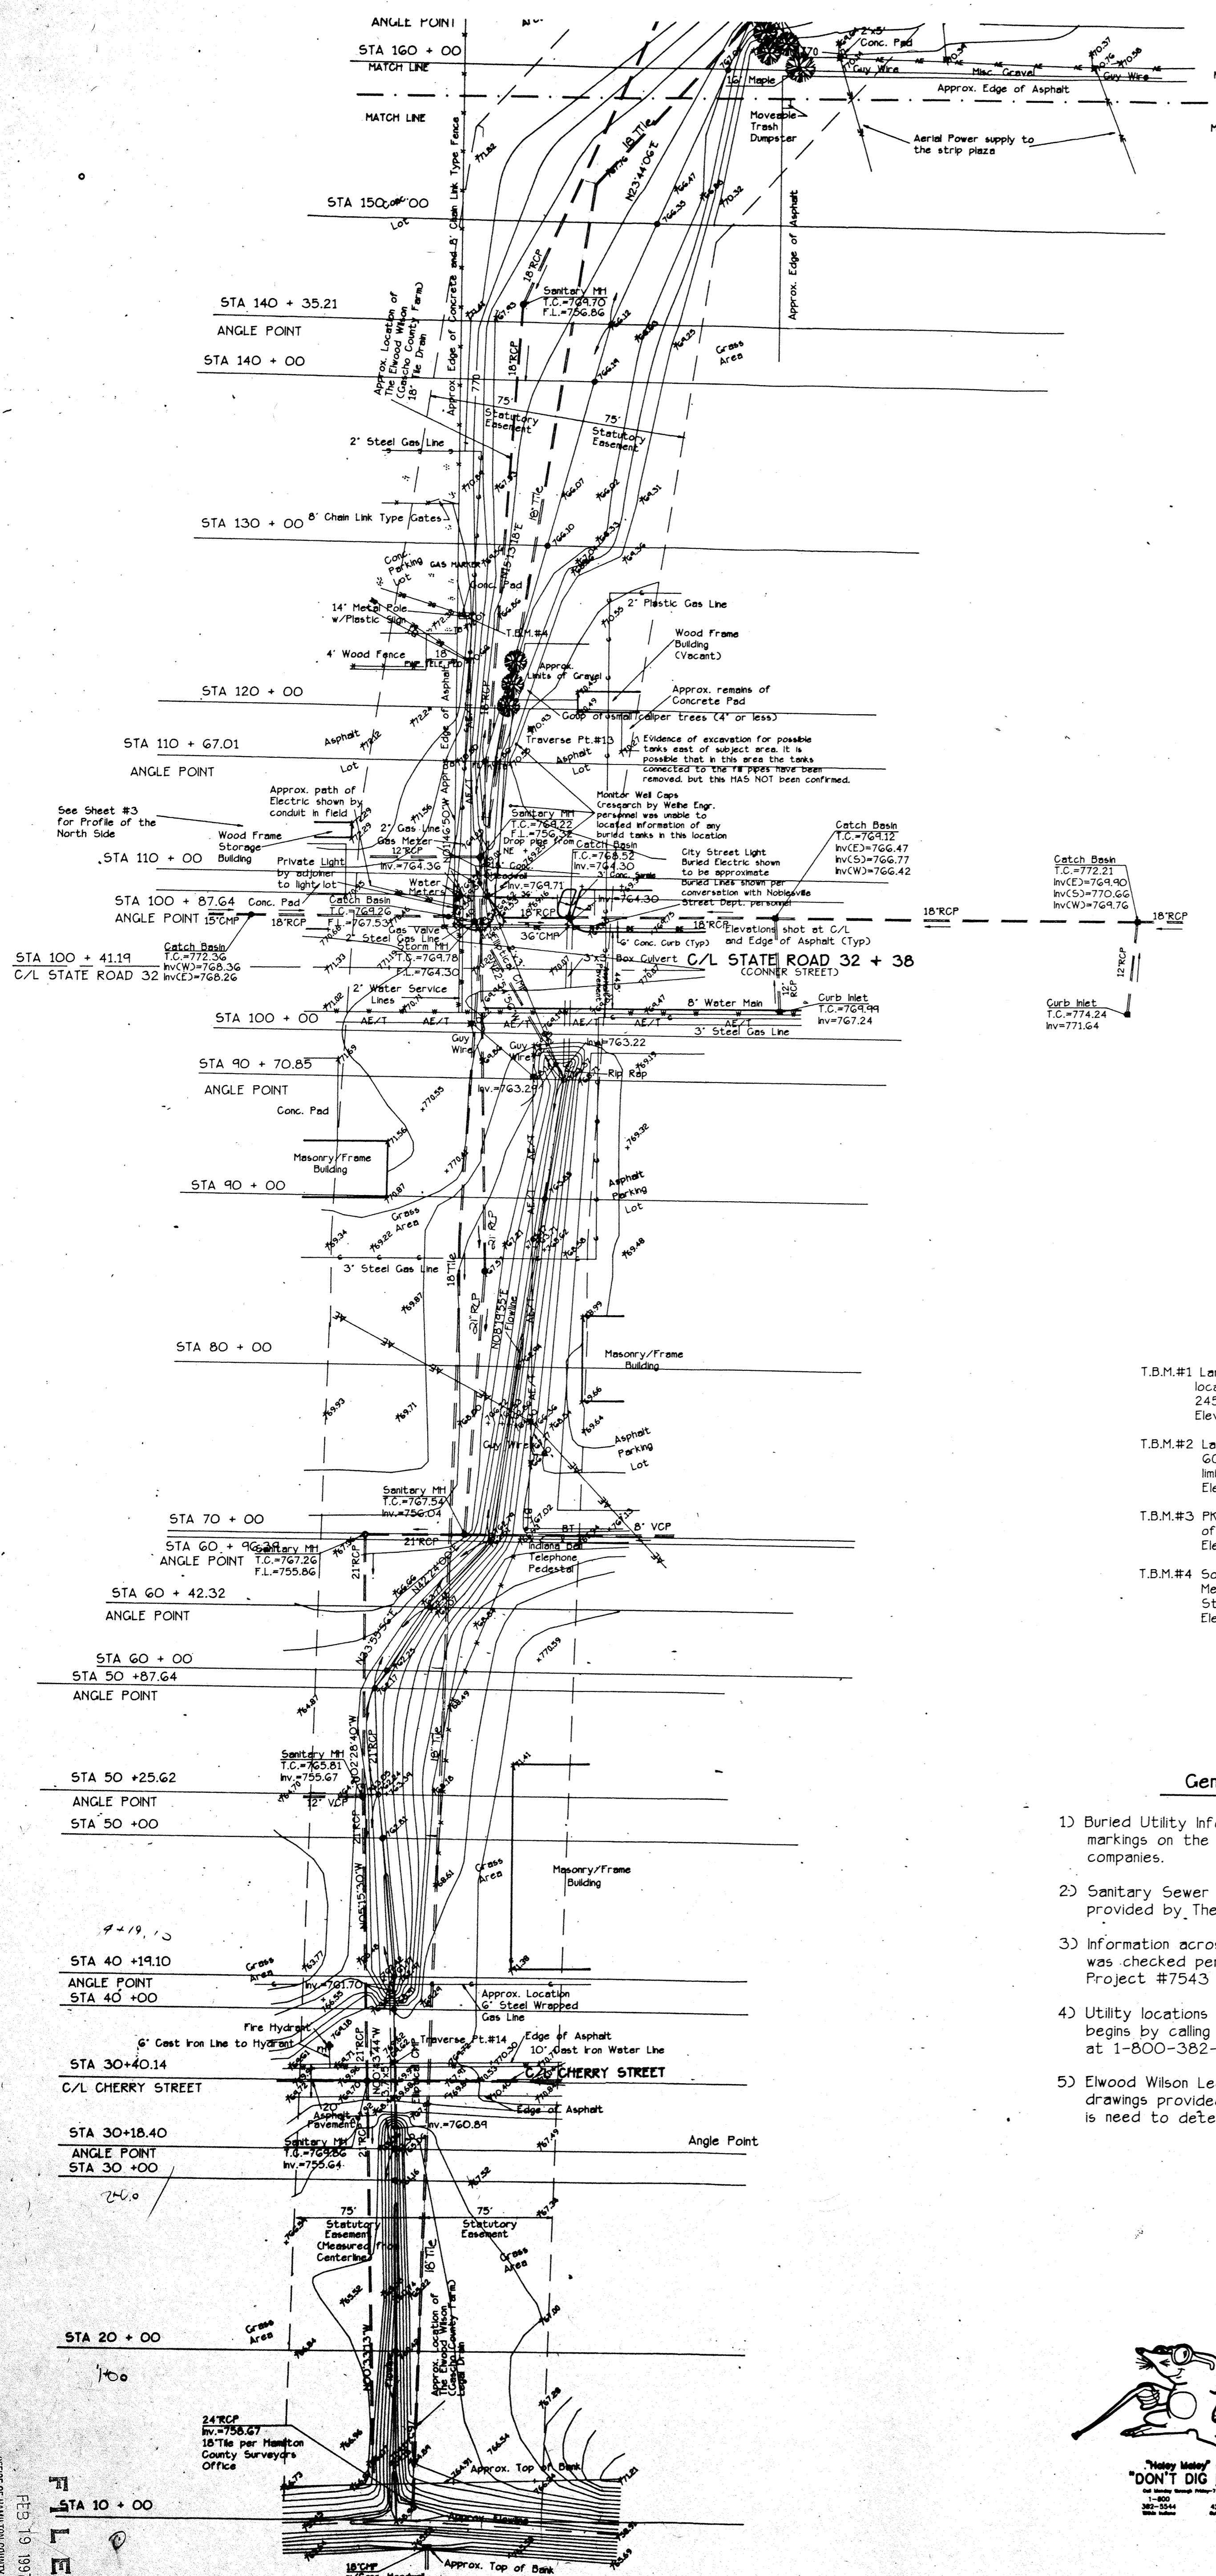

 = Aerial Electric/Telephone Line
 = Light Pole
 = Power Pole
 = Concrete Surface
 = Fire Hydrant
 = Existing Fence Line (See Label for Type)
 (Typ) = Typical
 RCP = Reinforced Concrete Pipe
 GV = Gas Valve
 WV = Water Valve
 MH = Manhole
 IPS = 5/8' Rebar w/Cap stamped
 Weihe Engr. L.S. OO12 Set
 = Denotes various landscaping
 (Unless noted)

Benchmark Information

- T.B.M.#1 Large Nail Set in East side of a Power Pole located on the South side of Monument Street 245' +/- West of Cumberland Road Elevation: 781.69

T.B.M.#2 Large Nail Set in 42' Hackberry Tree located 600' +/- South of Monument Street w/in limits of this survey Elevation: 772.13

T.B.M.#3 PK Nail Set in Power Pole located 150' North of The Dollar General Store (shown on survey) Elevation: 771.47


T.B.M.#4 Southeast Anchor Bolt on Self Service Storage Metal/Plastic Sign located 200' +/- North of State Road (38/32)(Conner Street) Elevation: 774.13

General Notes:


- 1) Buried Utility Information is shown per drawings and paint markings on the ground provided by the corresponding companies.
 - 2) Sanitary Sewer Information is shown per record drawings provided by The City of Noblesvilles City Engineers Office.
 - 3) Information across the North part of the surveyed area was checked per plans by Paul I. Cripe. dated 6-9-76. Project #7543 Sheet S-1. S-2.
 - 4) Utility locations should be verified before any construction begins by calling Indiana Underground Plant Protection Agency at 1-800-382-5544. or by contacting each utility company.
 - 5) Elwood Wilson Legal Drain is shown to be approximate per drawings provided by The County Surveyors Office. Excavation is need to determine exact location of the said tile.

Michael G. De Ray



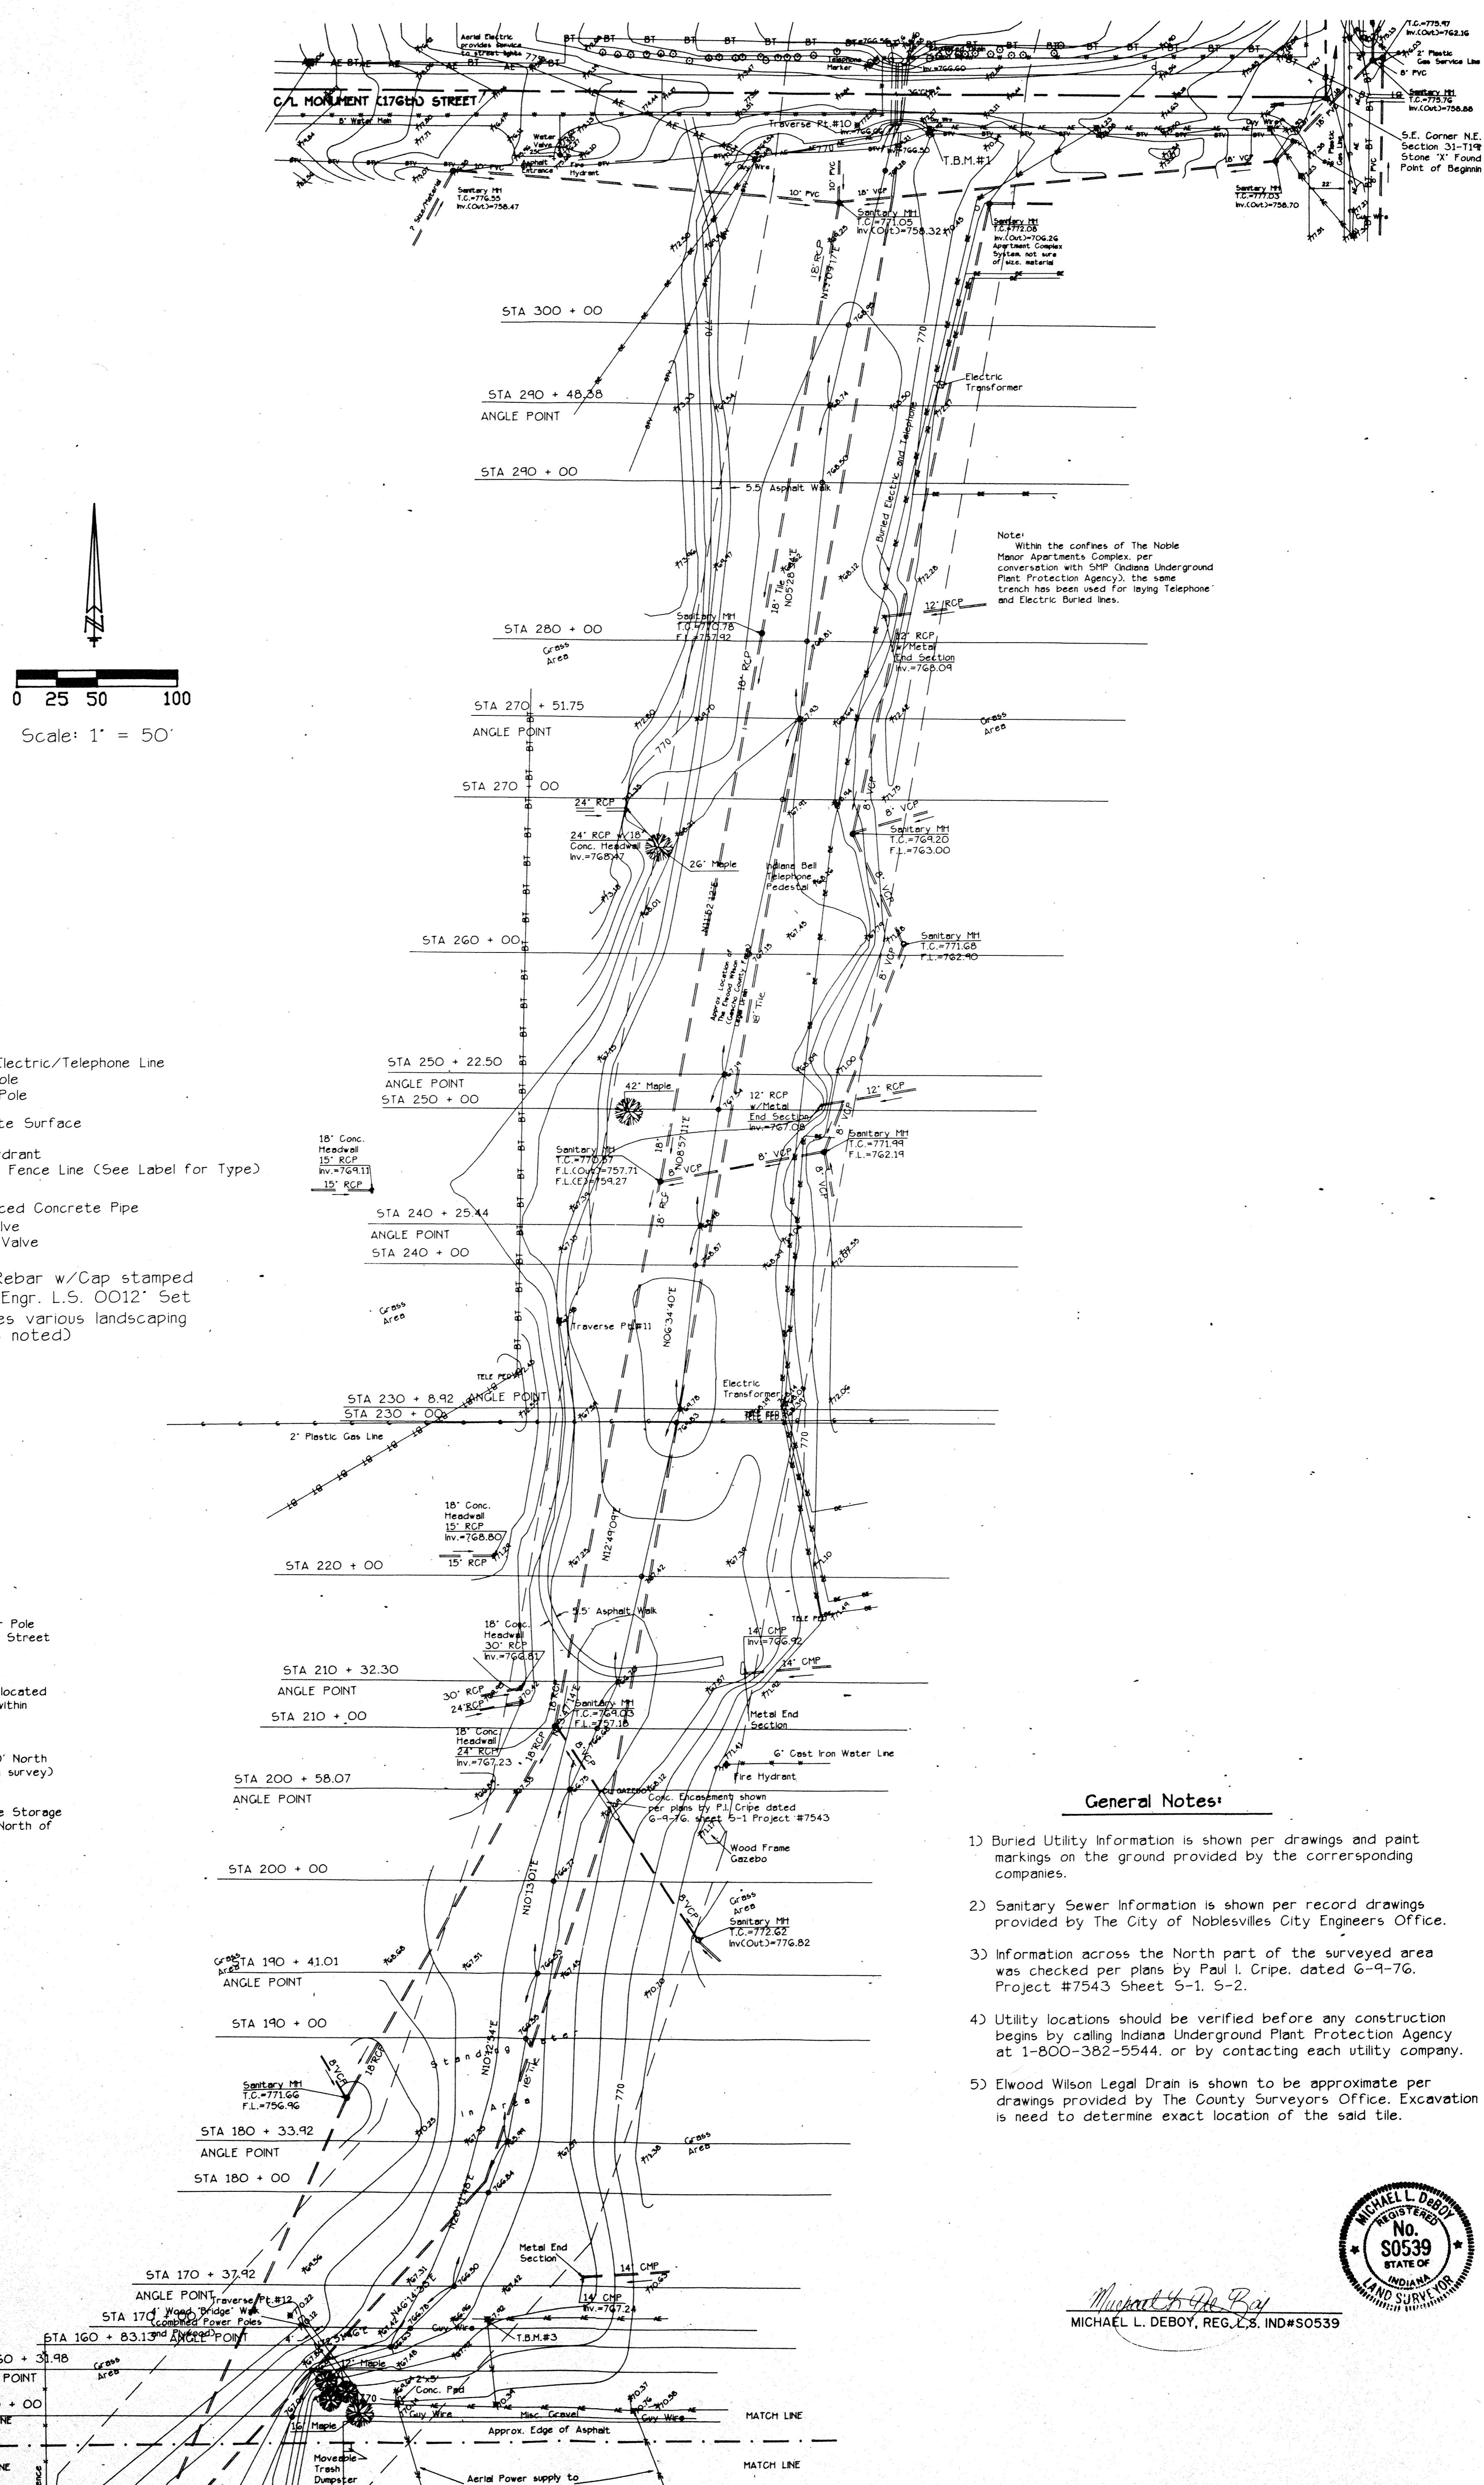


REVISIONS	DATE	BY	JOB NO
			92-128
		DRAWN BY	M.W.
		CHECKED BY	M.L.D.
		DATE	
F.B. 5-25	PAGE 2	#	2-15-97

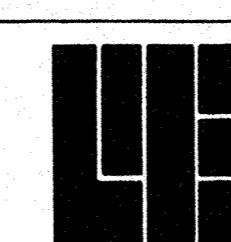

WEIHE ENGINEERS INC.


10505 NORTH COLLEGE AVENUE
INDIANAPOLIS, INDIANA 46280
(317) 846-6611ALLAN H. WEIHE, P.E., L.S.
PRESIDENT*Michael L. DeBoy*
MICHAEL L. DEBOY, REG. L.S., IND#S0539

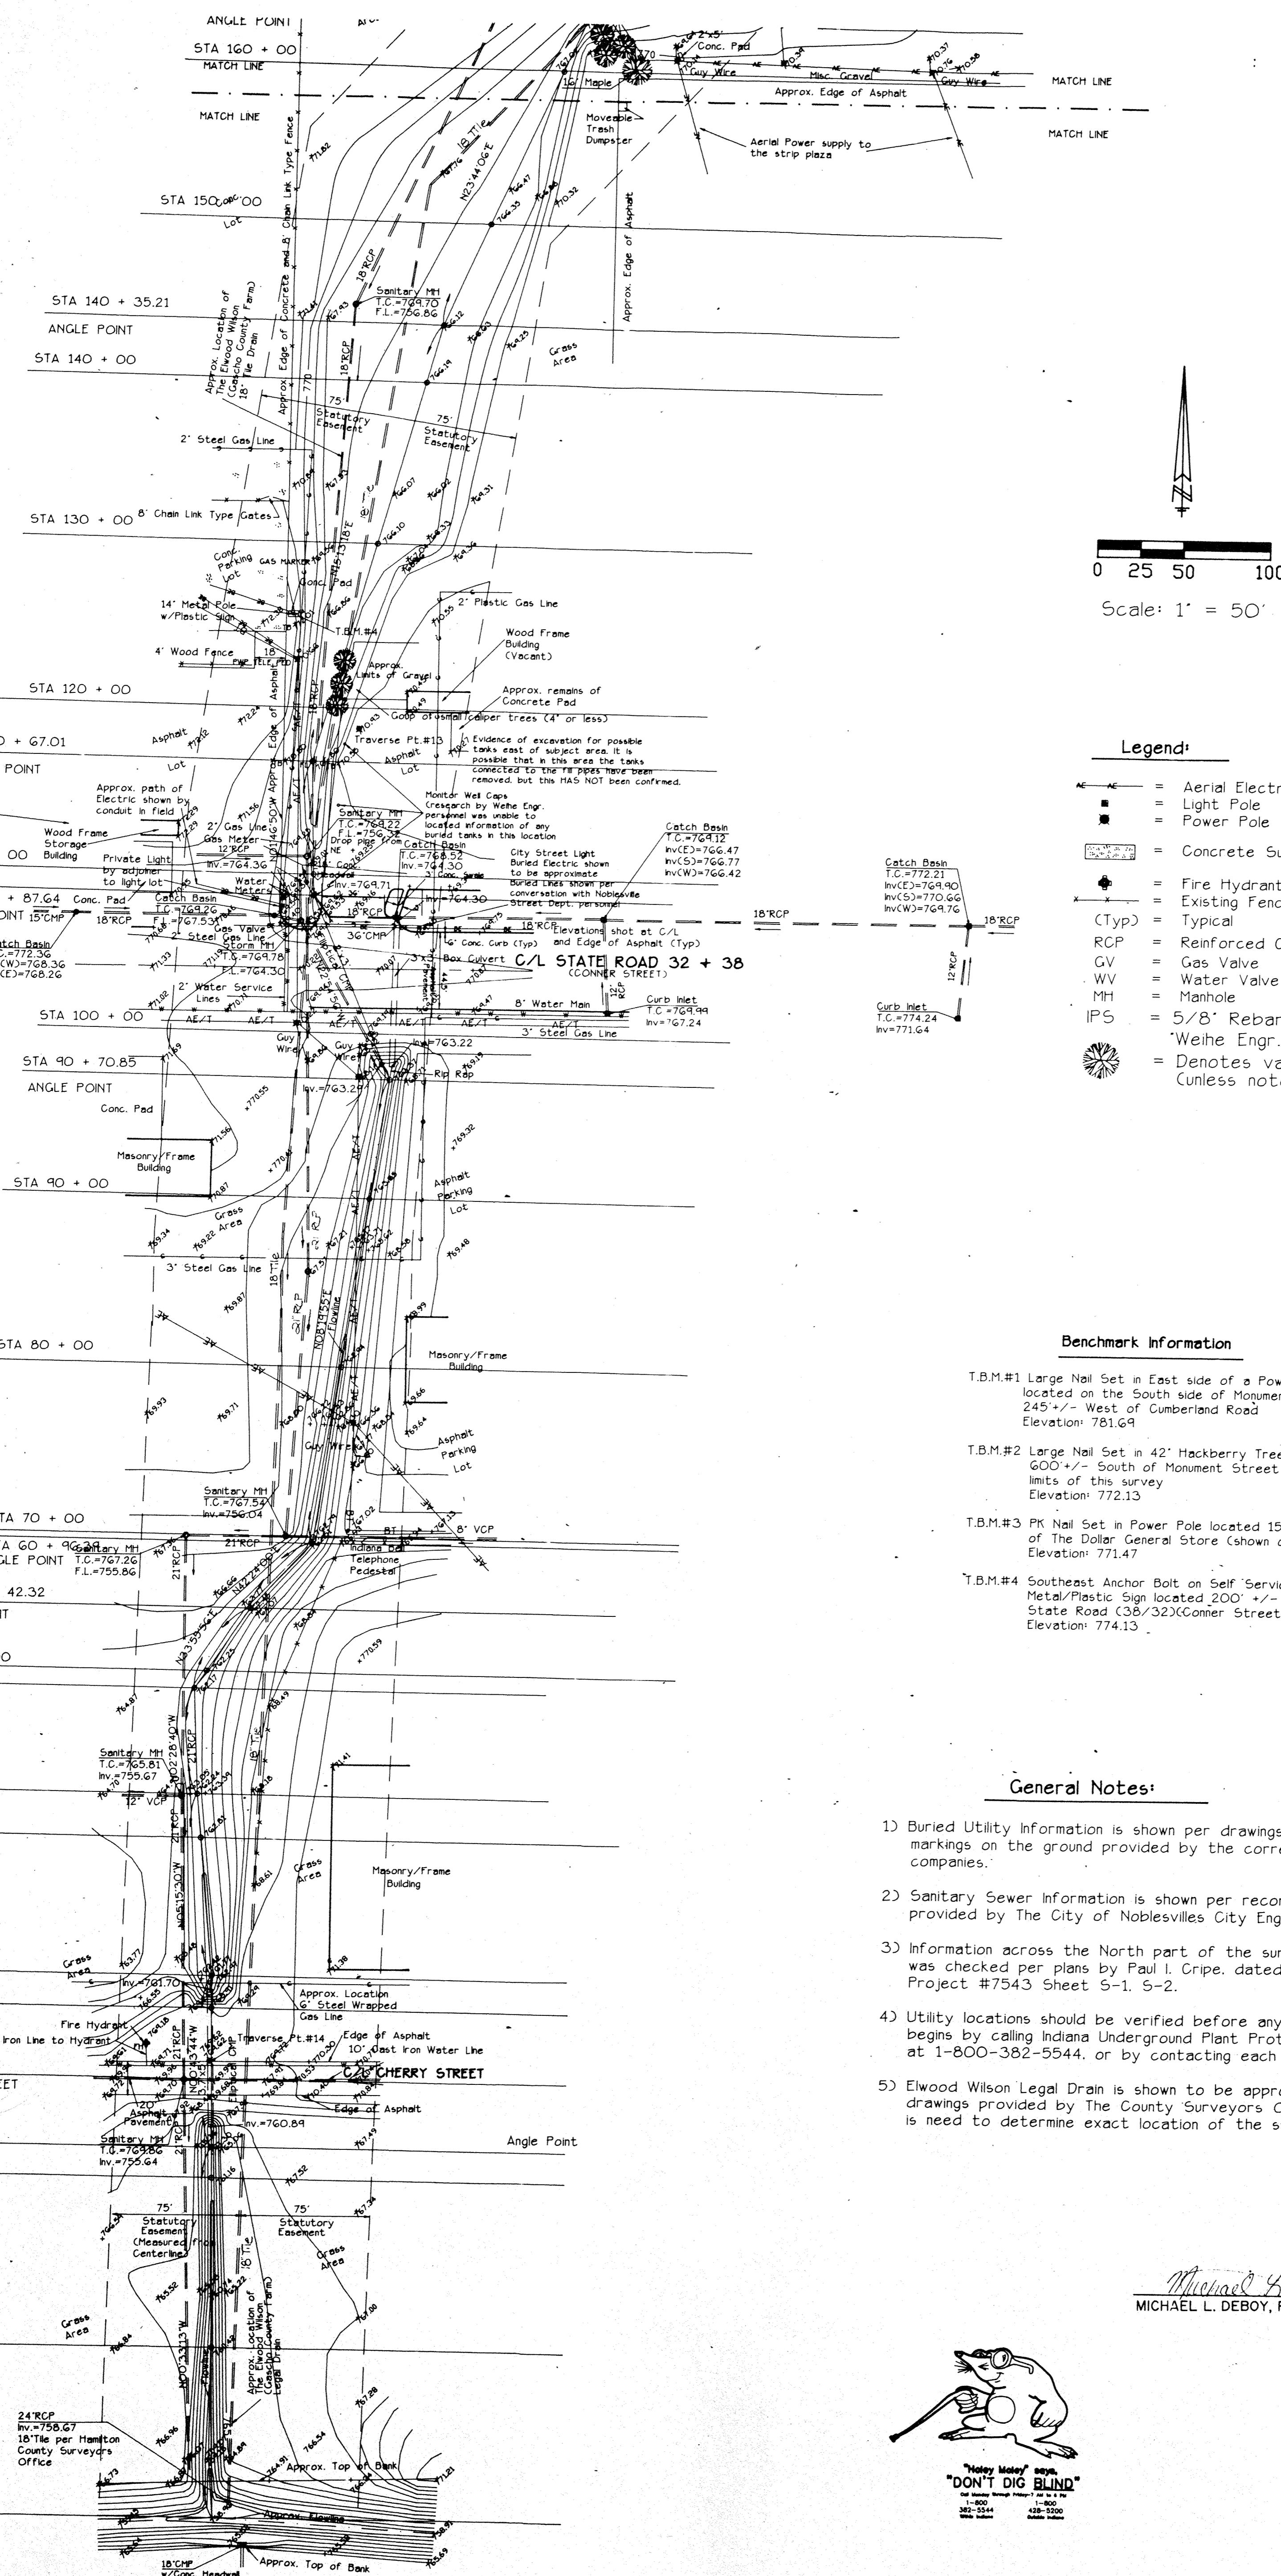

Michael L. DeBoy
MICHAEL L. DEBOY, REG. L.S., IN#S0539



"Mickey Moley" says
"DON'T DIG BLIND"
Call Mickey Moley Products, Inc. 1-800-382-5544
428-2200
White Sulphur Springs, West Virginia

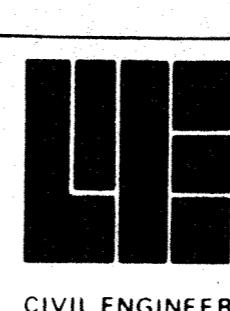

WEIHE ENGINEERS INC.


10505 NORTH COLLEGE AVENUE
INDIANAPOLIS, INDIANA 46280
(317) 846-6611

ALLAN H. WEIHE, P.E., L.S.
PRESIDENT


CIVIL ENGINEERS

LAND SURVEYORS


LAND PLANNERS

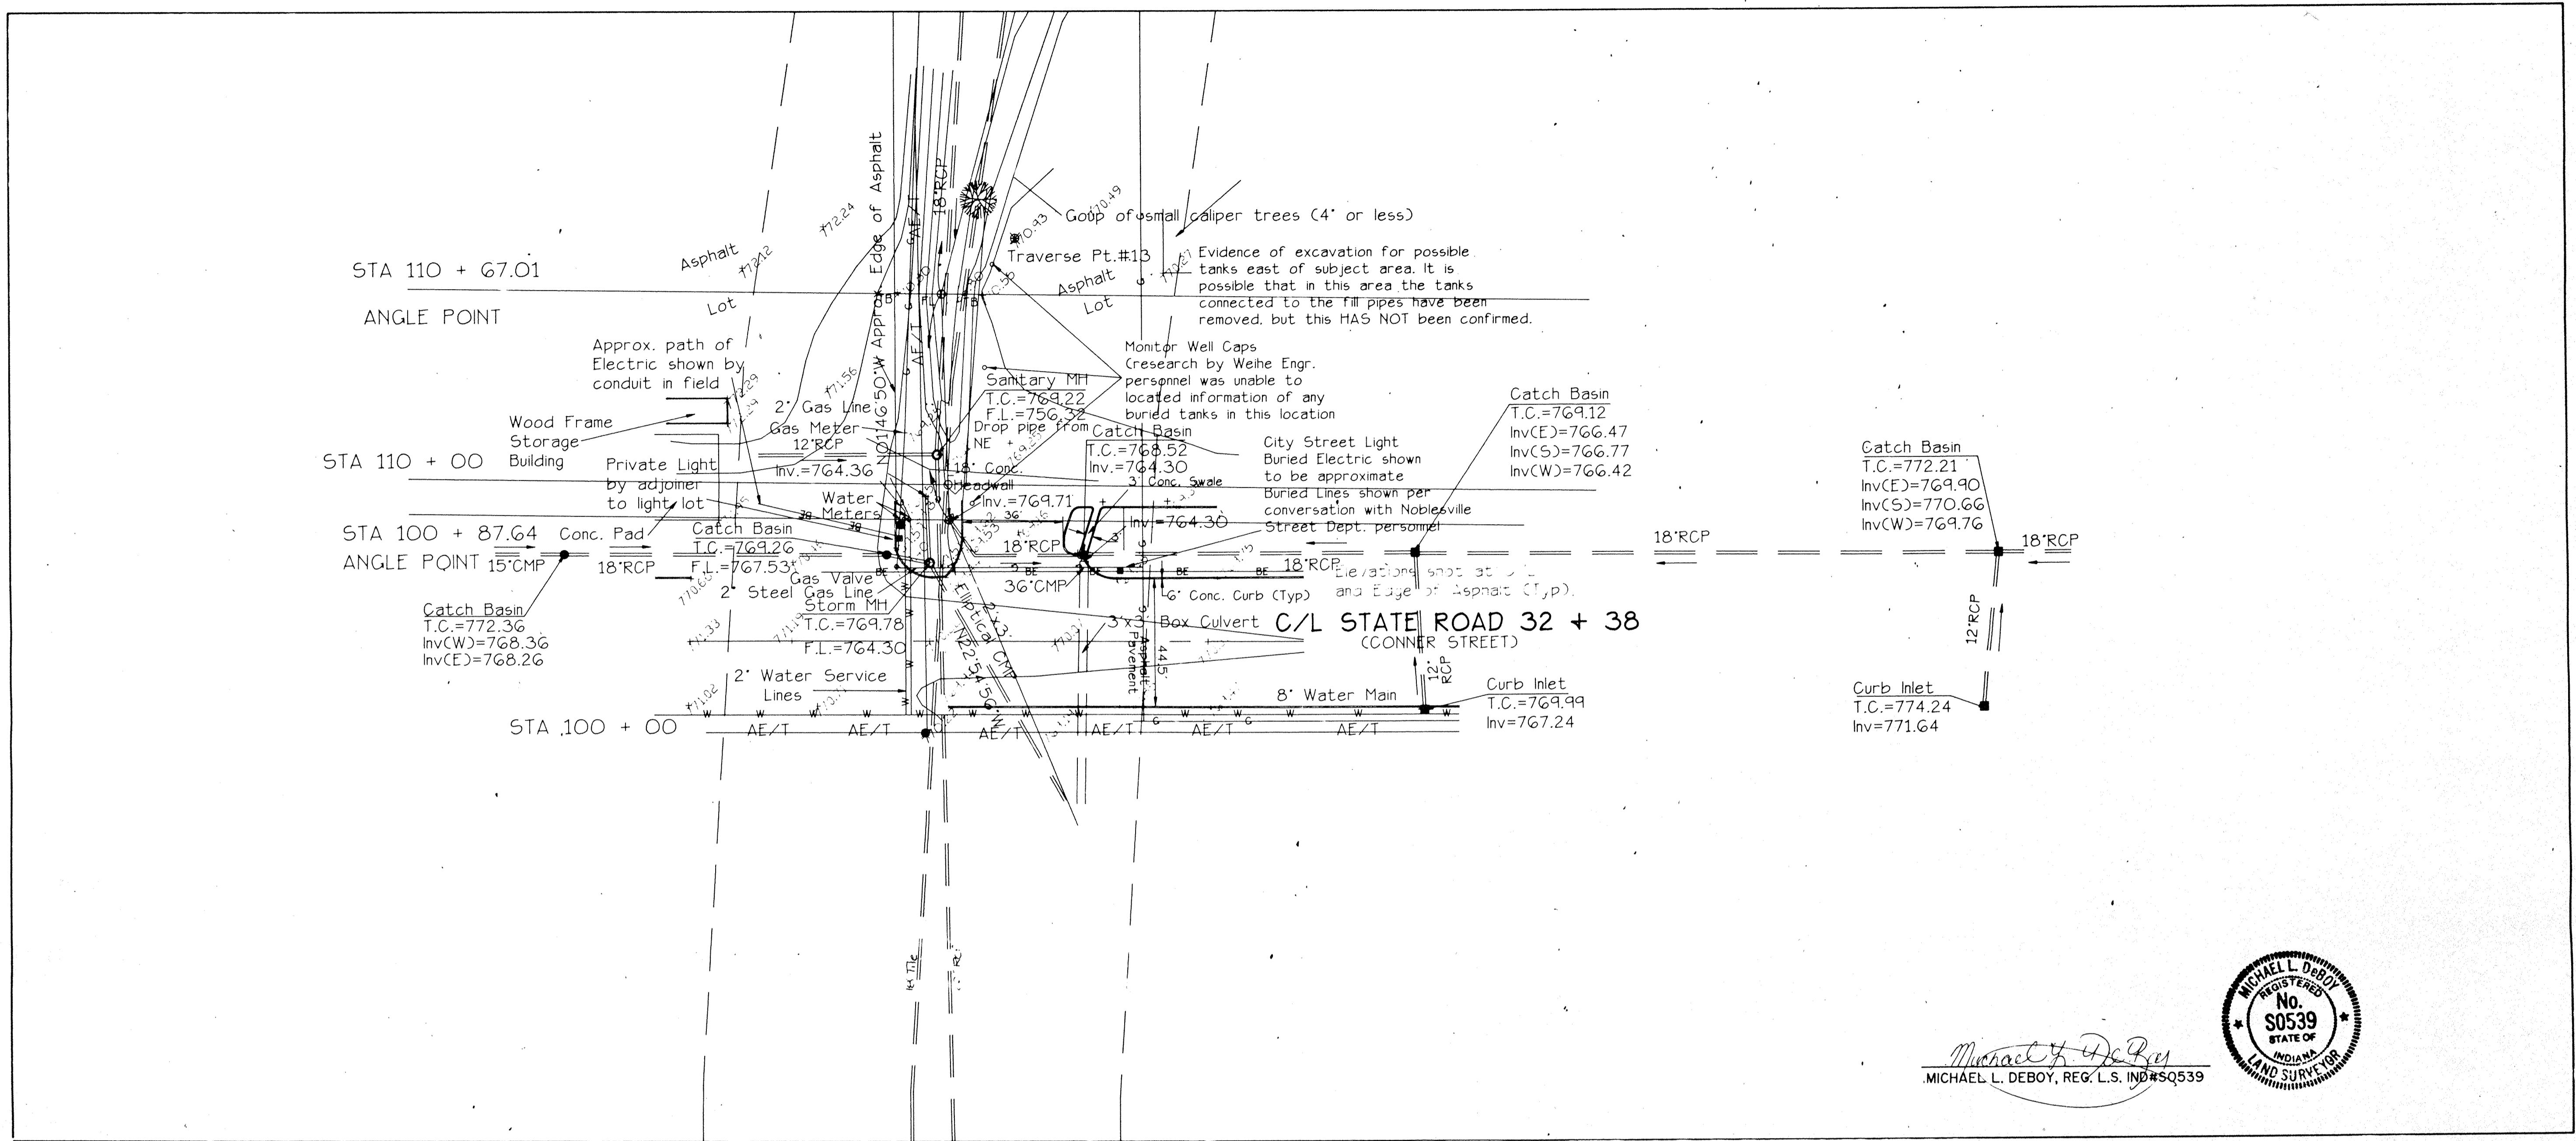

Michael L. DeBoy
MICHAEL L. DEBOY, REG. L.S. IND#SQ539

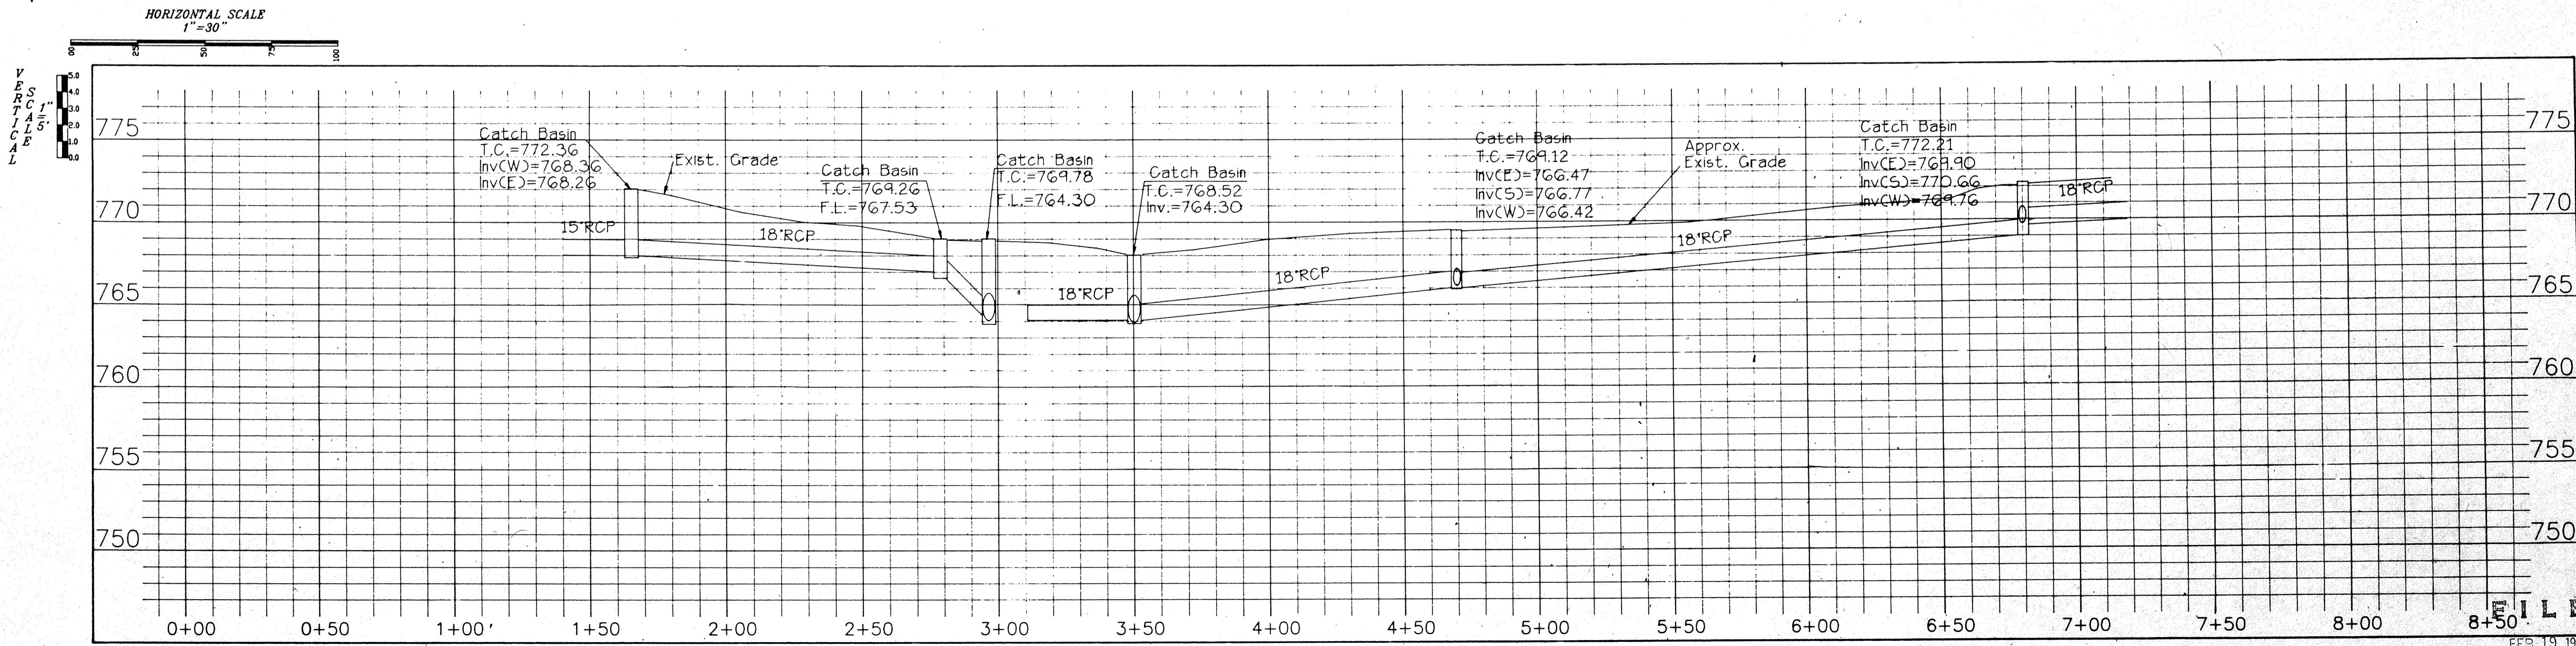

MATCH LINE A-A (SEE SHEET SD-2)

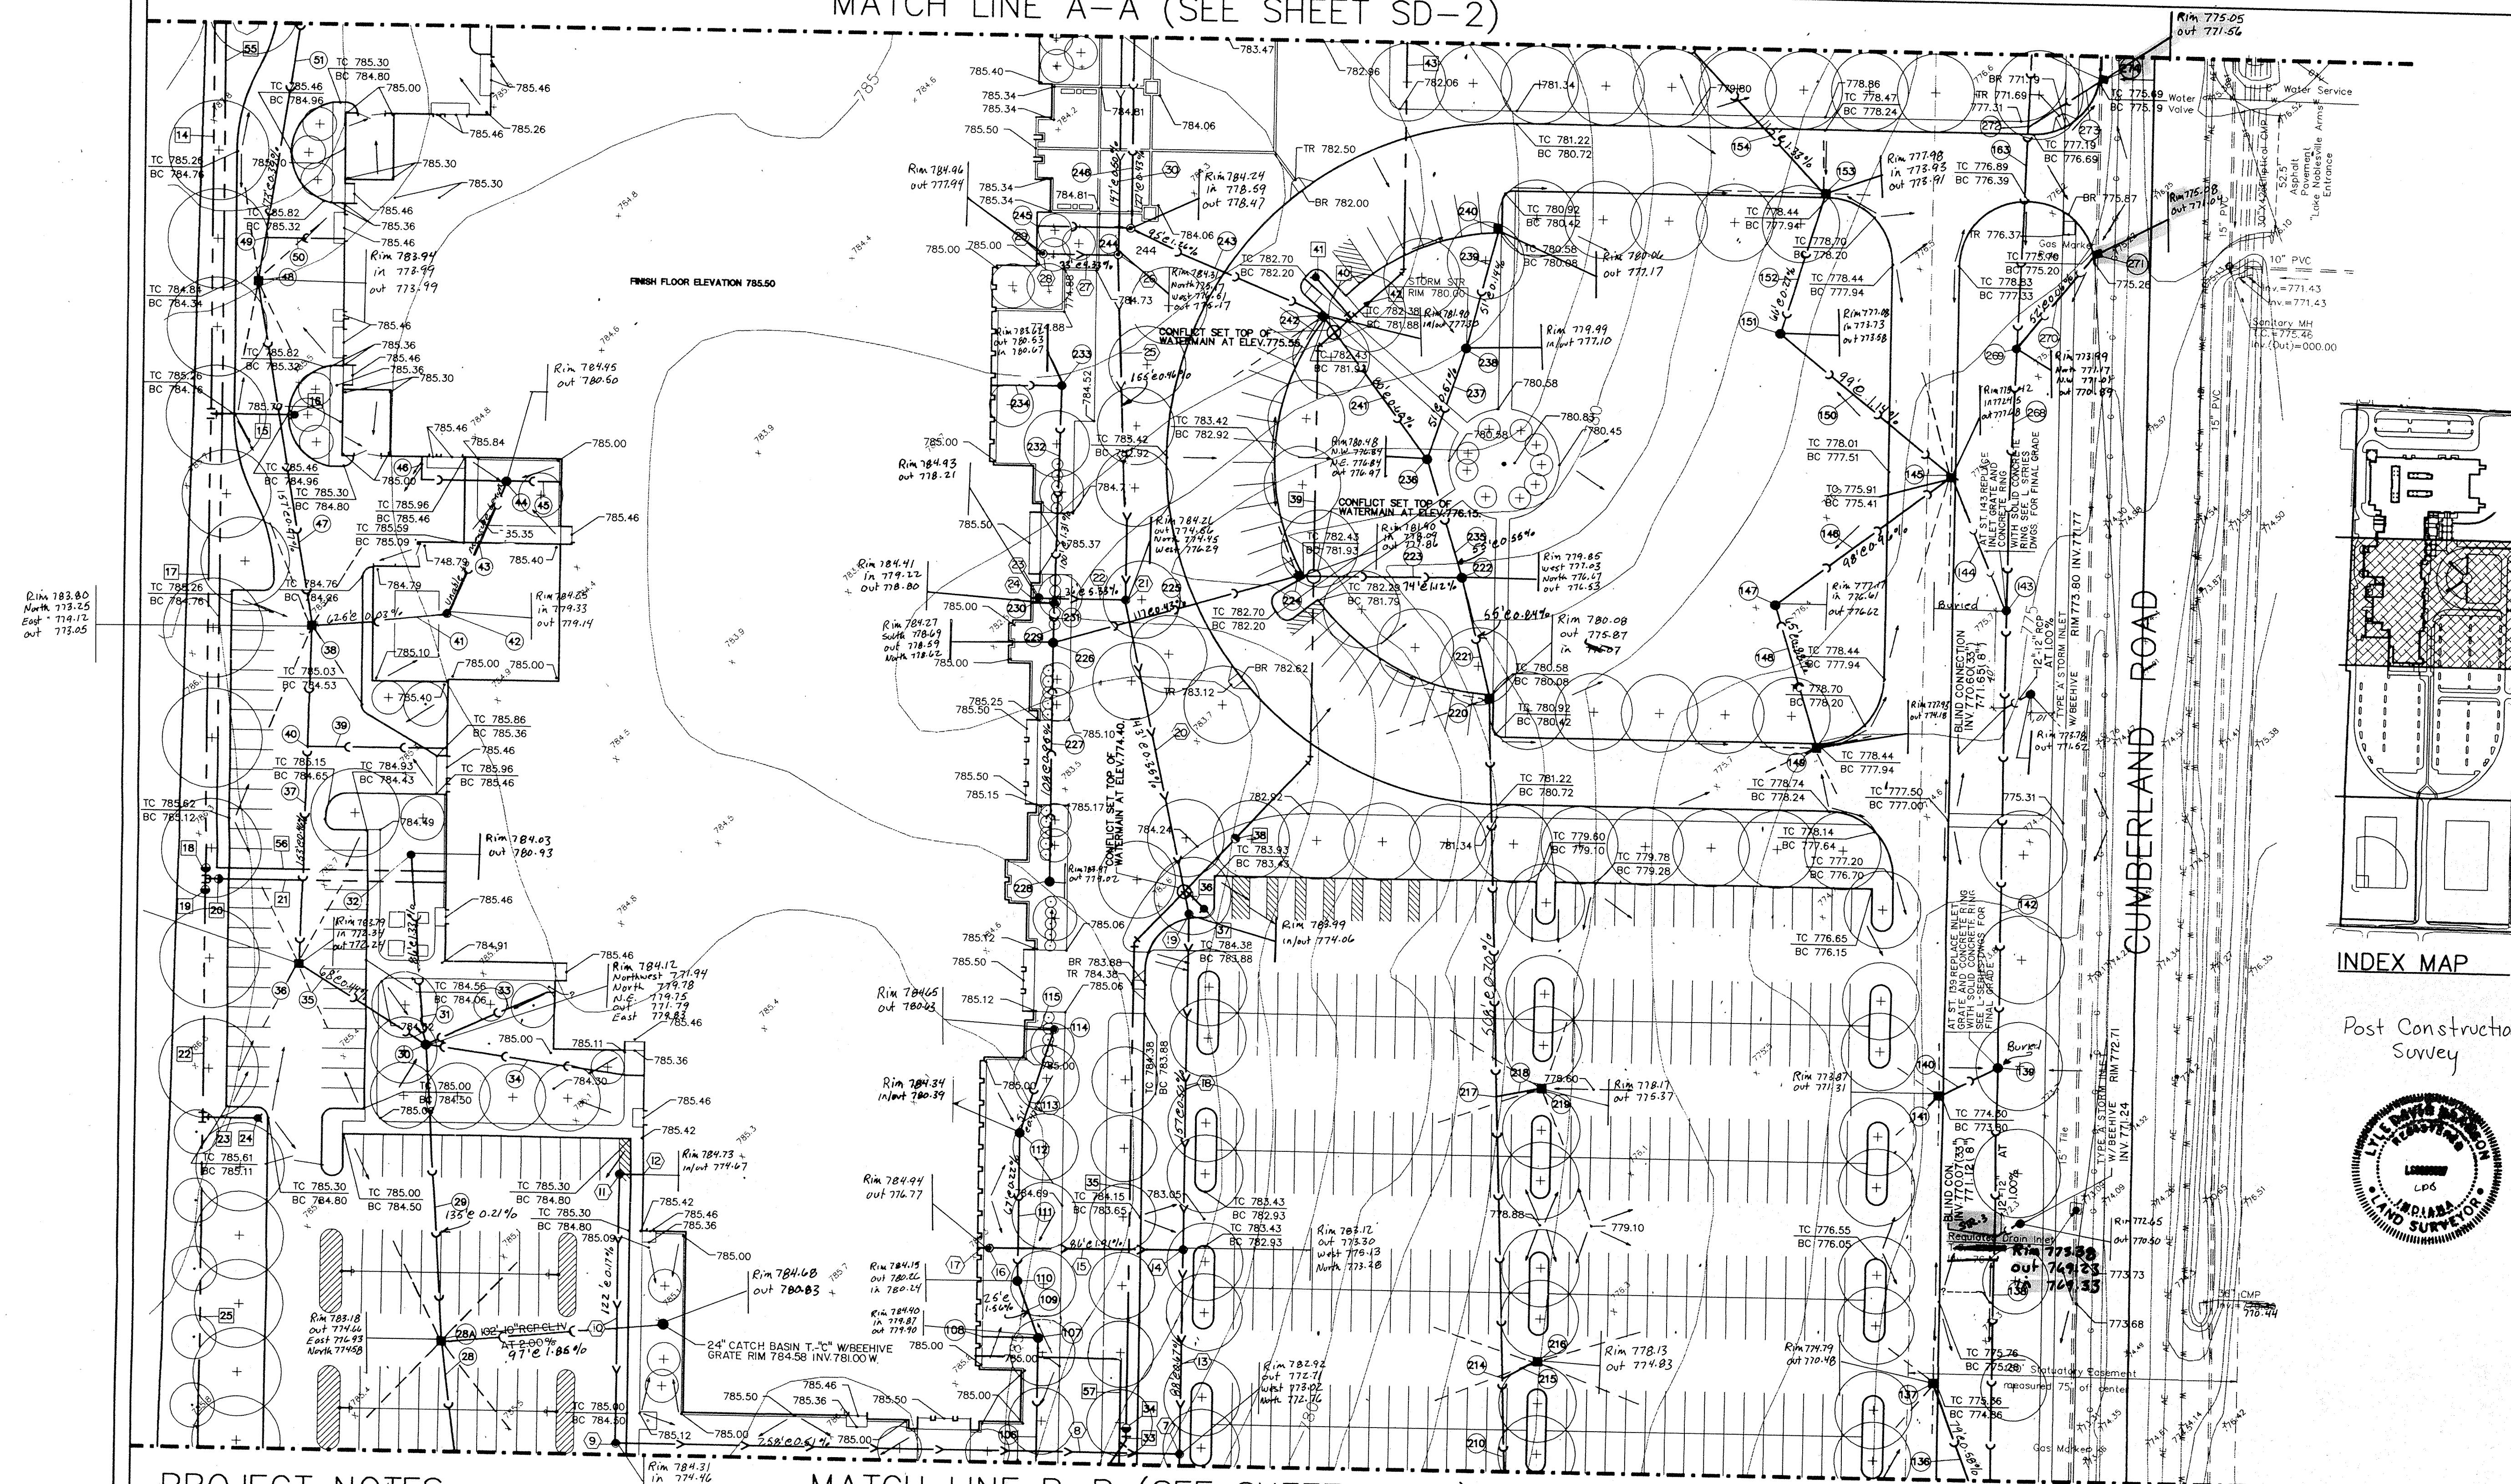

PROJECT NOTES

MATCH LINE B-B (SEE SHEET SD-4)

28. 187 L.F. 36" R.C.P. STORM SEWER CL. III AT 0.23%.
 28A. 60" DIA. STORM INLET RIM 783.00, INV. 771.62, 778.96 E
 29. 135 L.F. 36" R.C.P. STORM SEWER CL. III AT 0.16%.
 30. 60" DIA. CATCHBASIN RIM 783.90, INV. 772.07 NW (33"), 771.82 S (36"), 780.00 N (10"), 780.00 (6"), 780.00 (8")
 31. 67 L.F. 10" PVC SDR 26 STORM SEWER AT 1.0%. 86' @ 1.33%
 32. 29" DIA. CATCHBASIN RIM 784.15, INV. 780.87.
 33. 63 L.F. 8" P.V.C. SDR 26 ROOF DRAIN AT 2.0%.
 34. 100 L.F. 6" F.V.C. SDR 26 ROOF DRAIN AT 1.5%.
 35. 68 L.F. 33" R.C.P. STORM SEWER CL. III AT 0.21%. 0.44%
 36. 60" DIA. STORM INLET RIM 783.76, INV. 772.46 N 772.21 SE (33)
 37. 153 L.F. 30 R.C.P. STORM SEWER CL. III AT 0.34%. 0.46%
 38. 60" DIA. STORM INLET RIM 783.74, INV. 773.23 N (27"), 772.98 S (30"), 778.60 E (10").
 39. 63 L.F. 6" P.V.C. SDR 26 ROOF DRAIN AT 11.78%.
 40. BLIND CONNECTION INV. 773.83 (6"), 772.83 (30").
 41. 60 L.F. 10" R.C.P. STORM SEWER CL. IV AT 1.5%. 62.5' @ 0.03%
 42. 48" DIA. CATCHBASIN RIM 784.31, INV. 779.50.
 43. 65 L.F. 10" R.C.P. STORM SEWER CL. IV AT 1.54%.
 44. 48" DIA. CATCHBASIN RIM 784.46, INV. 780.50.
 45. 25 L.F. 6" F.V.C. SDR 26 ROOF DRAIN AT 3.0%.
 46. 48 L.F. 6" P.V.C. SDR 26 ROOF DRAIN AT 1.56%.
 47. 158 L.F. 27" R.C.P. STORM SEWER CL. IV AT 0.46%. 157' @ 0.47%
 48. 60" DIA. STORM INLET RIM 784.14, INV. 773.96.
 49. BLIND CONNECTION INV. 774.60 (10").
 50. 35 L.F. 10" R.C.P. ROOF DRAIN AT 17.6%.
 51. 175 L.F. 27" R.C.P. STORM SEWER CL. IV AT 0.45%. 173' @ 0.39%
 106. 65 L.F. 15" R.C.P. STORM SEWER CL. IV AT 0.8%.
 107. 48" DIA. STORM MANHOLE RIM 784.75, INV. 779.95, 780.70 W (8").
 108. 28 L.F. 8" P.V.C. SDR 26 ROOF DRAIN AT 2.0%.
 109. 2526 L.F. 15" R.C.P. STORM SEWER CL. IV AT 0.5%. 1.56%
 110. 48" DIA. CATCHBASIN RIM 784.00, INV. 780.0R.
 111. 67 L.F. 15" R.C.P. STORM SEWER CL. IV AT 0.4%. 0.22%
 112. 48" DIA. CATCHBASIN RIM 784.30, INV. 780.35.
 113. 50 L.F. 15" R.C.P. STORM SEWER CL. IV AT 0.4%. 51' @ 0.47%
 114. 48" DIA. STORM MANHOLE RIM 784.80, INV. 780.80, 780.55 S (15").
 115. 13 L.F. 12" R.C.P. ROOF DRAIN AT 1.5%.
 136. 71 L.F. 10" R.C.P. STORM SEWER CL. IV AT 1.0%.
 137. 24" DIA. STORM INLET RIM 774.86, INV. 771.36.
 138. 210 L.F. 33" R.C.P. STORM SEWER CL. III AT 0.25%
 139. 60" DIA. CATCHBASIN RIM 774.04, INV. 770.26, 771.02 SW (12").
 140. 28 L.F. 12" R.C.P. STORM SEWER CL. IV AT 1.0%
 141. 24" DIA. STORM INLET RIM 773.80, INV. 771.28

142. 207 L.F. 33" R.C.P. STORM SEWER CL. III AT 0.21%.
 143. 60" DIA. CATCHBASIN RIM 774.50, INV. 770.69 S (33"), 770.94 N (30"), 771.65 NW (18")
 144. 65 L.F. 18" R.C.P. STORM SEWER CL. IV AT 1.0%.
 145. 48" DIA. STORM INLET RIM 775.41, INV. 772.30 SE, 772.78 SW, 772.53 NW
 146. 190 L.F. 12" R.C.P. STORM SEWER CL. IV AT 0.4%. 0.46%
 147. 48" DIA. CATCHBASIN RIM 777.21, INV. 773.78 NE (12"), 773.98 S (10")
 148. 66 L.F. 10" R.C.P. STORM SEWER CL. IV AT 0.7%. 0.88%
 149. 24" DIA. STORM INLET RIM 777.94, INV. 774.45.
 150. 99 L.F. 15" R.C.P. STORM SEWER CL. IV AT 0.9%. 1.14%
 151. 48" DIA. CATCHBASIN RIM 777.21, INV. 773.45.
 152. 66 L.F. 15" R.C.P. STORM SEWER CL. IV AT 0.6%.
 153. 48" DIA. STORM INLET RIM 777.94, INV. 773.85.
 154. 110 L.F. 15" R.C.P. STORM SEWER CL. IV AT 1.4%. 1.33%
 163. 155 L.F. 30" R.C.P. STORM SEWER CL. III AT 0.15%
 210. 507 L.F. 24" R.C.P. STORM SEWER AT 0.66%. CL. IV. 508' @ 0.70%
 214. BLIND CONNECTION INV. 773.80 (24"), 774.30 (12").
 215. 18 L.F. 12" R.C.P. STORM SEWER AT 2.2%.
 216. 24" DIA. STORM INLET RIM 778.18, INV. 774.70.
 217. BLIND CONNECTION INV. 774.64 (24"), 775.14 (12").
 218. 20 L.F. 12" R.C.P. STORM SEWER AT 0.7%.
 219. 24" DIA. STORM INLET RIM 778.18, INV. 775.28.
 220. 48" DIA. STORM INLET RIM 780.08, INV. 776.08, N (21"), 775.83 S (24")
 221. 55 L.F. 21" R.C.P. STORM SEWER CL. IV AT 0.6%. 0.84%
 222. 48" DIA. CATCHBASIN RIM 780.00, INV. 776.41 S (21"), 776.66 N (18"), 777.16 W (12").
 223. 74 L.F. 12" R.C.P. STORM SEWER CL. IV AT 1.04%. 1.12%
 224. 48" DIA. STORM INLET RIM 781.93, INV. 777.90.
 225. 117 L.F. 12" R.C.P. STORM SEWER CL. IV AT 0.73%. 0.43%
 226. 48" DIA. CATCHBASIN RIM 784.20, INV. 778.76 N.E, 779.50 S (12").
 227. 108 L.F. 10" R.C.P. STORM SEWER CL. IV AT 1.0%. 0.95%
 228. 24" DIA. CATCHBASIN RIM 784.58, INV. 780.58.
 229. 17 L.F. 12" R.C.P. STORM SEWER CL. IV AT 0.8%.
 230. 10 L.F. 8" P.V.C. SDR 26 ROOF DRAIN AT 2.0%.
 231. 48" DIA. STORM MANHOLE RIM 784.40, INV. 781.05 W (8"), 778.90 S (12"), 779.10 N (10")
 232. 100 L.F. 10" R.C.P. STORM SEWER CL. IV AT 1.45%. 1.31%
 233. 48" DIA. CATCHBASIN RIM 783.40, INV. 780.90 SW (8"), 780.70 S (10")
 234. 35 L.F. 8" P.V.C. SDR 26 ROOF DRAIN AT 1.0%
 235. 55 L.F. 18" R.C.P. STORM SEWER CL. IV AT 0.6%. 0.55%

SANITARY SEWER

7. 48" DIA. SANITARY MANHOLE RIM 782.62, INV. 773.06 N, 773.84 W, 772.89 S.
 8. 258" L.F. 10" P.V.C. SDR 26 SANITARY SEWER AT 0-28%.0-51%.
 9. 48" DIA. SANITARY MANHOLE RIM 784.45, INV. 774.56.
 10. 122" L.F. 10" P.V.C. SDR 26 SANITARY SEWER AT 0-28%.0-17%.
 11. 48" DIA. SANITARY MANHOLE RIM 784.75, INV. 774.90.
 12. 10 L.F. 10" P.V.C. SDR 26 SANITARY SEWER AT 1.0%, INV. AT THE BUILDING
 775.00.
 13. 288.90 L.F. 8" P.V.C. SDR 26 SANITARY SEWER AT 0-4%.0-67%.
 14. 48" DIA. SANITARY MANHOLE RIM 783.15, INV. 773.42 N-S, 775.30 W.
 15. 208.6 L.F. 8" P.V.C. SDR 26 SANITARY SEWER AT 1-5%.1-91%.
 16. 48" DIA. SANITARY MANHOLE RIM 784.95, INV. 778.70 W, 777.50 E.
 17. 5 L.F. 6" P.V.C. SDR 26 SANITARY SEWER AT 1.0%, INV. AT THE BUILDING IS
 778.75.
 18. 157.152 L.F. 8" P.V.C. SDR 26 SANITARY SEWER AT 0-4%.0-50%
 19. 48" DIA. SANITARY MANHOLE RIM 784.15, INV. 774.03.
 20. 243.144 L.F. 8" P.V.C. SDR 26 SANITARY SEWER AT 0-4%.0-35%.
 21. 48" DIA. SANITARY MANHOLE RIM 783.90, INV. 776.56 W, 774.61 N-S.
 22. 38 L.F. 6" P.V.C. SDR 26 SANITARY SEWER AT 5.76%.
 23. 48" DIA. SANITARY MANHOLE RIM 784.95, INV. 780.70 W, 778.75E.
 24. 5 L.F. 6" P.V.C. SDR 26 SANITARY SEWER AT 1.0%, INV. AT THE BUILDING IS
 780.75.
 25. 156.156 L.F. 8" P.V.C. SDR 26 SANITARY SEWER AT 0-4%.0-46%.
 26. 48" DIA. SANITARY MANHOLE RIM 784.45, INV. 775.23 N-S, 776.93 W.
 27. 35 L.F. 6" P.V.C. SDR 26 SANITARY SEWER AT 3-00%.4-33%.
 28. 48" DIA. SANITARY MANHOLE RIM 774.95, INV. 778.95 W, 777.92 E.
 29. 5 L.F. 6" P.V.C. SDR 26 SANITARY SEWER AT 1.0%, INV. AT THE BUILDING
 779.00.
 30. 148 L.F. 8" P.V.C. SDR 26 SANITARY SEWER AT 0-4%.

WATERMAIN

14. 357 L.F. 10" P.V.C. AWNA C-900 W/FITTINGS.
15. 10" X 6" TEE W/37 L.F. 6" P.V.C. AWNA C-900 W/FITTINGS.
16. BREAK FLANGE FIRE HYDRANT G.R. EL. 785.40.
17. 210 L.F. 10" P.V.C. AWNA C-900 W/FITTINGS.
18. 10" GATE VALVE AND BOX RIM ELEV. 785.00.
19. 10" GATE VALVE AND BOX RIM ELEV. 785.00.
20. 8" GATE VALVE AND BOX RIM ELEV. 784.90.
21. 10" X 8" TEE W/110 L.F. 8" P.V.C. AWNA C-900 W/FITTINGS.
22. 108 L.F. 10" P.V.C. AWNA C-900 W/FITTINGS.
23. 10" X 6" TEE W/25 L.F. 6" P.V.C. AWNA C-900.
24. BREAK FLANGE FIRE HYDRANT G.R. ELEV. 785.40.
25. 358 L.F. 10" P.V.C. AWNA C-900 W/FITTINGS.
33. 55 L.F. 8" P.V.C. AWNA C-900 W/FITTINGS.
34. 8" GATE VALVE AND BOX RIM EL. 783.60.
35. 285 L.F. 8" P.V.C. AWNA C-900 W/FITTINGS.
36. 8" X 6" TEE W/12 L.F. 6" P.V.C. AWNA C-900 W/FITTINGS.
37. BREAK FLANGE FIRE HYDRANT G.R. ELEV. 783.80.
38. 8" GATE VALVE AND BOX RIM ELEV. 783.60.
39. 370 L.F. 8" P.V.C. AWNA C-900 W/FITTINGS.
40. 8" X 6" TEE W/24 L.F. 6" P.V.C. AWNA C-900 W/FITTINGS.
41. BREAK FLANGE FIRE HYDRANT GRADE RING ELEV. 777.60.
42. 8" X 6" REDUCER.
43. 220 L.F. 6" P.V.C. AWNA C-900 W/FITTINGS
55. 10" X 6" DOMESTIC TAP BY WATER CO.
56. 1145 L.F. 6" DUCTILE IRON DOMESTIC WATERMAIN W/FITTINGS.

NOTE: WITHIN THE CONFINES OF THE SITE ALTERNATE MATERIAL
MAYBE SUBSTITUTED AS FOLLOWS: SEE SPECIFICATION
SECTION 15417 FOR ADDITIONAL ALTERNATE MATERIALS.

1. ADS N-12 INSTEAD OF R.C.P. CLASS III.
2. HANCOR HI-Q HDPE PIPE INSTEAD OF R.C.P. CLASS
III.
3. R.C.P. CLASS III SHALL BE USED UNDER ALL DRIVES
WITHOUT EXCEPTION.


UTILITY PLAN

FILED
FEB 19 1997

FEB 19 1997
OFFICE OF HAMILTON COUNTY SURVEYOR

JOB NO.92057
ADDI-SD-3

marchris/moore associates
of Indiana
consulting engineers
9245 North Meridian Street
Suite 105
Indianapolis, IN 46260-1812
(317) 835-2520 FAX 848-2765

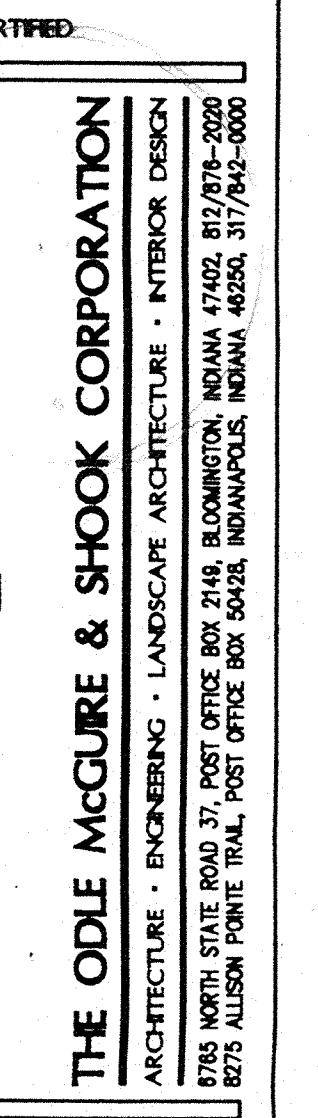
CERTIFIED

THE ODEL MCGUIRE & SHOCK CORPORATION
ARCHITECTURE • ENGINEERING • LANDSCAPE ARCHITECTURE • INTERIOR DESIGN
R75 NORTH STATE ROAD 37 POST OFFICE BOX 2146 BLOOMINGTON, INDIANA 47402
R75 ALLISON PARK TRAIL POST OFFICE BOX 5020 INDIANAPOLIS, INDIANA 46250
R275 317/374-2000 317/374-2000


REVISIONS
7-6-93 PER ARCHITECT
II-01-96 PER MOORE ENG.

NEW SCHOOL FOR
NOBLESVILLE HIGH SCHOOL
NOBLESVILLE INDIANA

PROJECT #91066
DATE: JUNE 3, 1993
drawn by:
checked by:

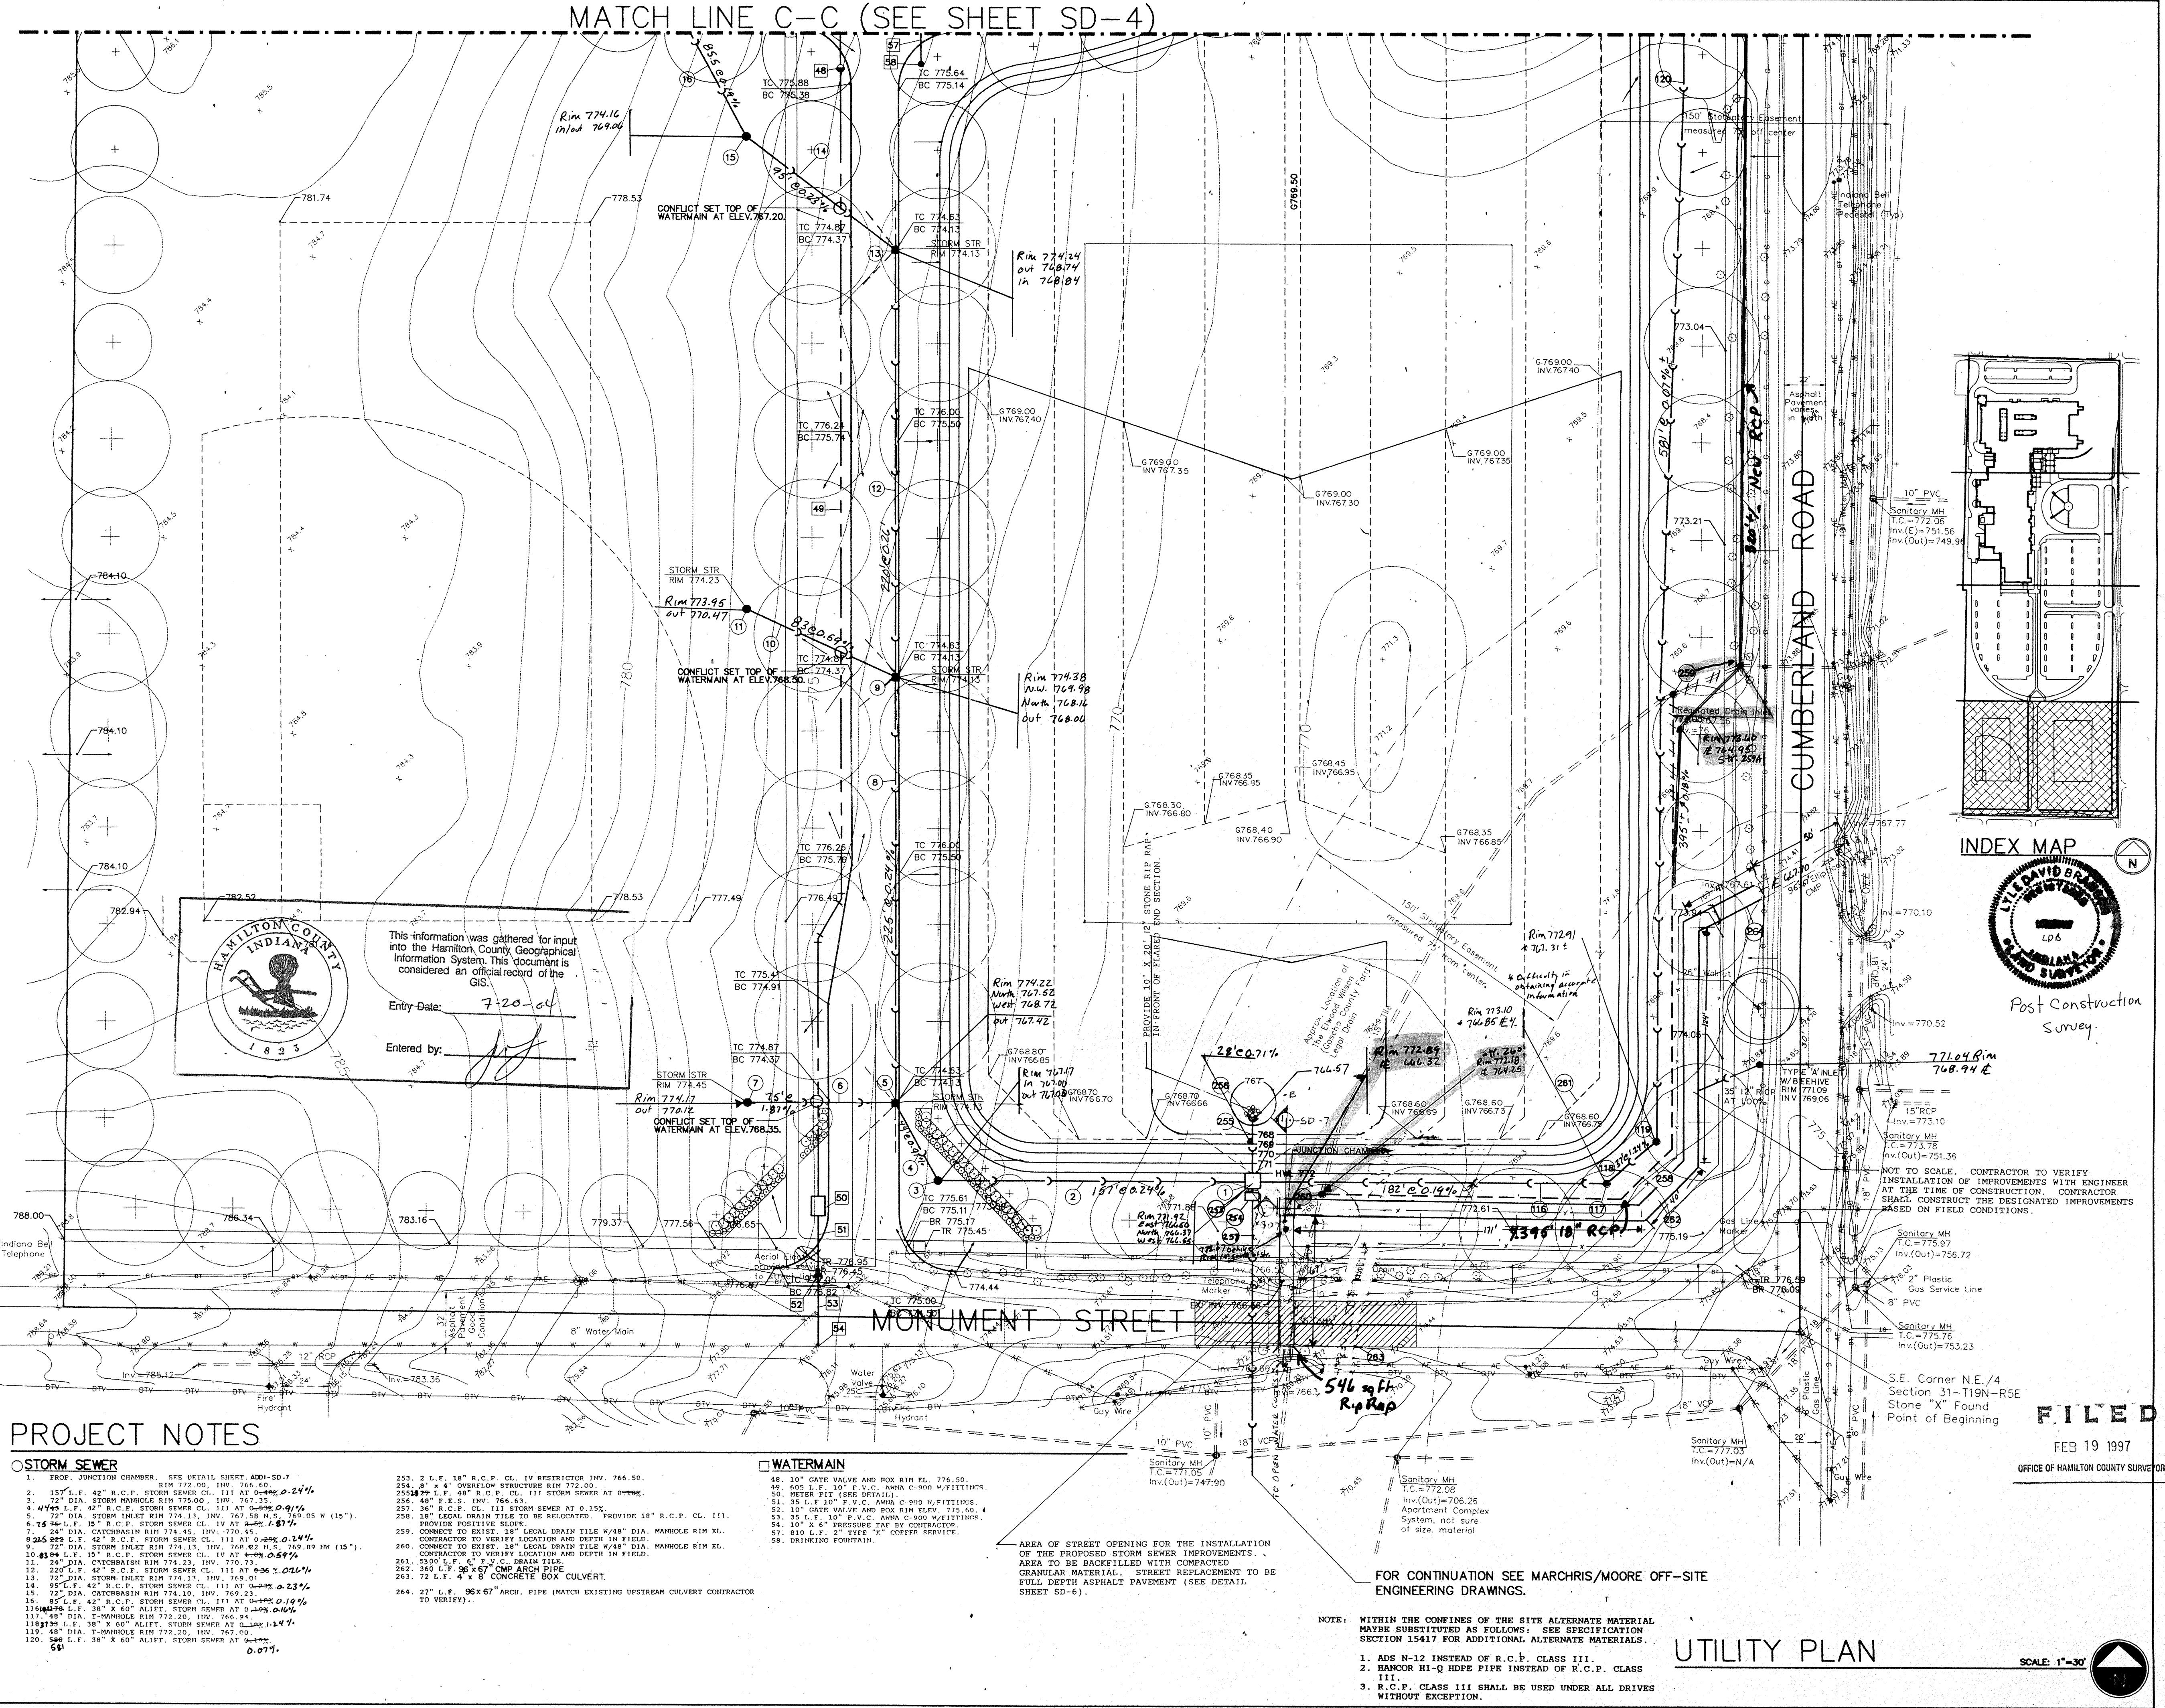JOB NO.92057
ADDI-SD-5



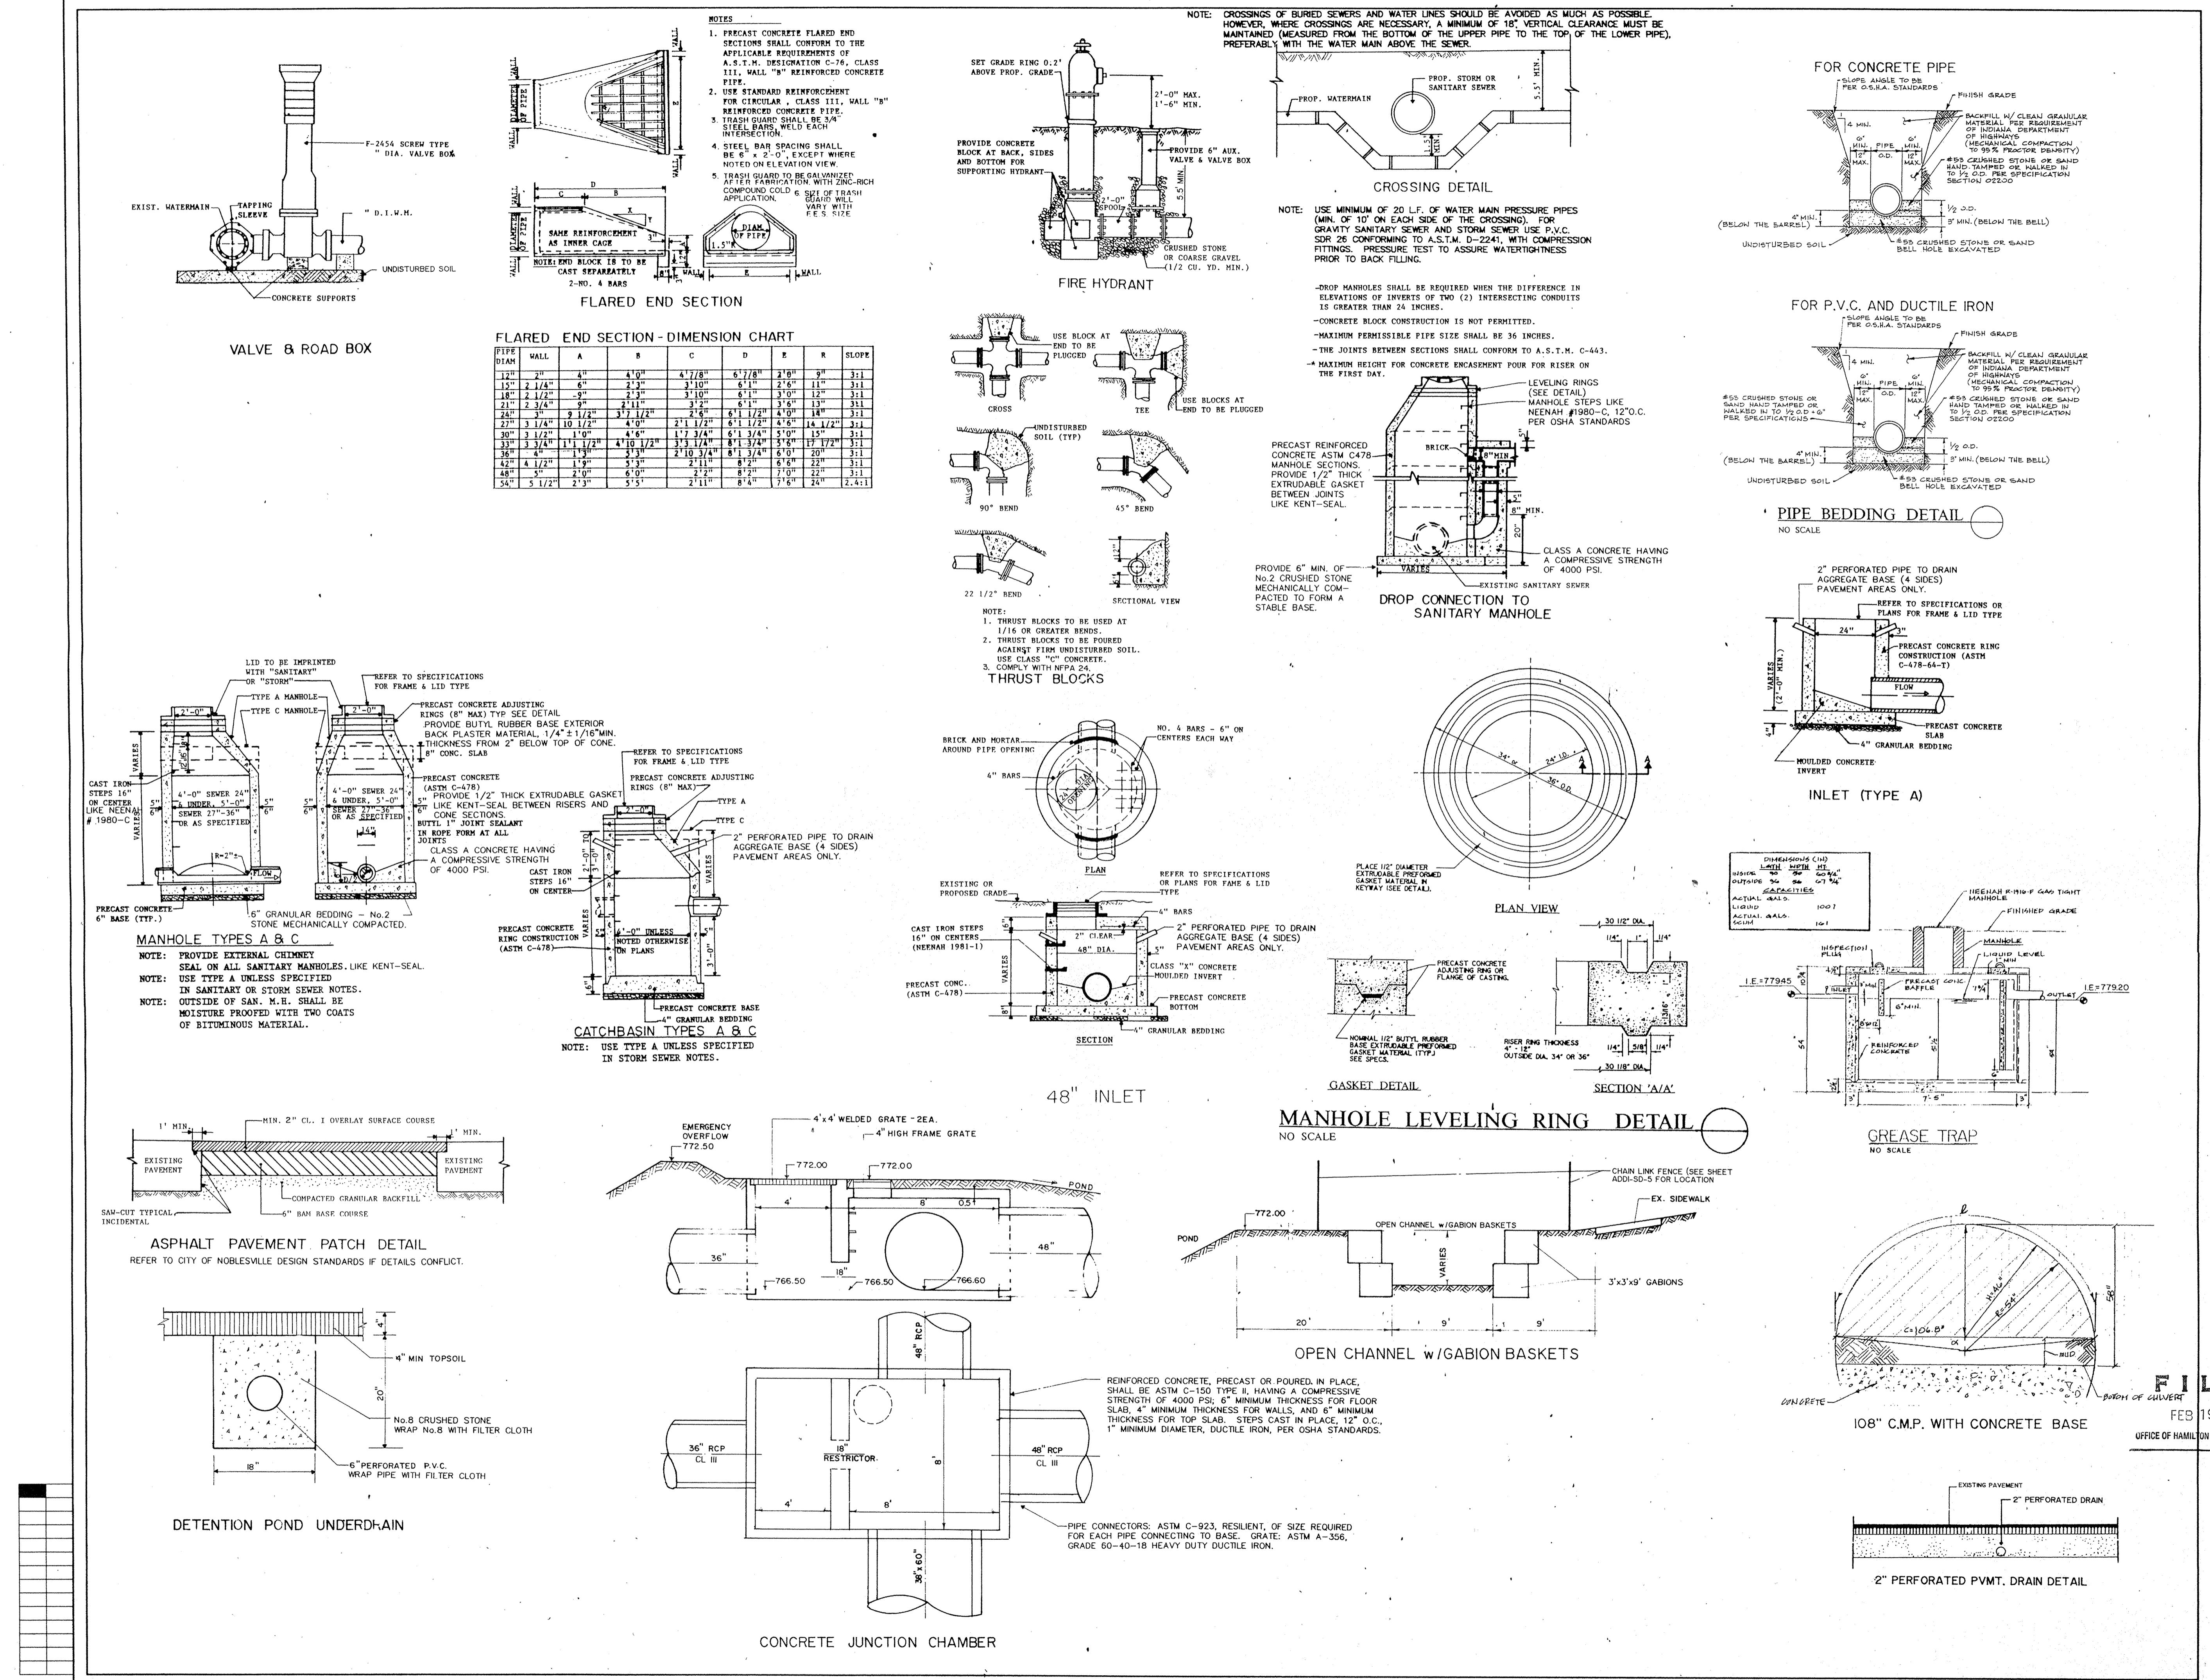

marchis/more associates
of Indiana
consulting engineers
9245 North Meridian Street
Suite 105
Indianapolis, IN 46260-1812
(317) 843-2520 FAX 848-2765

CERTIFIED
THE ODELL McCURE & SHOCK CORPORATION
ARCHITECTURE • ENGINEERING • LANDSCAPE ARCHITECTURE • INTERIOR DESIGN
6785 NORTH STATE ROAD 37, POST OFFICE BOX 219, BLOOMINGTON, INDIANA 47402
6785 ALISON PARKETTE, POST OFFICE BOX 5042, INDIANAPOLIS, INDIANA 46256
REVISIONS 7-6-93 FOR ARCHITECT

NEW SCHOOL FOR
NOBLESVILLE HIGH SCHOOL
NOBLESVILLE, INDIANA

PROJECT NO. 91066
DATE
drawn by:
checked by:

JOB NO 92057
ADDI-SD-6

