

Drain: CENTENNIAL DRAIN **Drain #:** 315
Improvement/Arm: CENTENNIAL - SECTION 3
Operator: JDH **Date:** 11/10/03
Drain Classification: Urban/Rural **Year Installed:** 2001

GIS Drain Input Checklist

- Pull Source Documents for Scanning gpa 11/10
- Digitize & Attribute Tile Drains N/A
- Digitize & Attribute Storm Drains gpa 11-13
- Digitize & Attribute SSD N/A
- Digitize & Attribute Open Ditch gpa 11-13
- Stamp Plans gpa 11-13
- Sum drain lengths & Validate gpa 11-13
- Enter Improvements into Posse gpa
- Enter Drain Age into Posse 11-17 jw/j
- Sum drain length for Watershed in Posse 11-17 jw/j
- Check Database entries for errors gpa 11-13

Gasb 34 Footages for Historical Cost Drain Length Log

Drain-Improvement: CENTENNIAL DRAW - CENTENNIAL - SECTION 3

Sum: 9257.3' 9257.9' + .6'

Final Report:

Comments:

SURVEY REPORT SHOWS 2/36.2' FOR 24" LENGTH

AS ODDS SHOW 2136.8¹ FOR 24" LENGTH.



SURVEYOR'S OFFICE
Hamilton County

Kenton C. Ward, Surveyor

Phone (317) 776-8495

Fax (317) 776-9628

Suite 146

One Hamilton County Square
Noblesville, Indiana 46060-2230

To: Hamilton County Drainage Board

August 14, 2000

Re: Centennial Drain, Section 3 Arm

Attached is a petition, non-enforcement request, plans, calculations, quantity summary and assessment roll for the Section 3 Arm, Centennial Drain. I have reviewed the submittals and petition and have found each to be in proper form.

I have made a personal inspection of the land described in the petition. Upon doing so, I believe that the drain is practicable; will improve the public health; benefit a public highway and be of public utility; and that the costs, damages, and expenses of the proposed drain will probably be less than the benefits accruing to the owners of land likely to be benefited. The drain will consist of the following:

6"	SSD	4,745 ft	18"	RCP	1,109 ft	36"	RCP	851 ft
12"	RCP	3,289 ft	24"	RCP	2,008 ft	Open Ditch	195 ft	
15"	RCP	529 ft	30"	RCP	1,371 ft			

The total length of the drain will be 14,097 feet.

The open ditch sections are those areas between structures 500 and 500B and structures 443 and 443B. These are located south of Lots 308, 309 and 323, 324 respectively.

The subsurface drains (SSD) to be part of the regulated drain are those main lines between lots of in rear yards. The SSD under curbs are not to be part of the regulated drain. Only the main SSD lines which are located within the platted easements are to be maintained as regulated drain. Laterals for individual lots will not be considered part of the regulated drain. The portion of the SSD which will be regulated are as follows: Rear of Lots 314; 315; 325-328; 343-347; 350-353; 353-358; 359-362; 369-372; 375-378; 379-383; 391-395; 396-400; 401-406; 414; 418-421; 424-429; 430-436; 437-439; 440-445; South line of Common Area 12, Common Area 8.

State of Indiana)
)
County of Hamilton)

TO: HAMILTON COUNTY DRAINAGE BOARD
c/o Hamilton County Surveyor
Courthouse
Noblesville, IN 46060

In the matter of Centennial subdivision, Section
Three Drain petition.

Petitioner is the owner of all lots in the land affected by the proposed new regulated drain. The drainage will affect various lots in Centennial Section 3, a subdivision in Hamilton County, Indiana. The general route of such drainage shall be in existing easements and along public roads as shown in the plans on file in the Surveyor's Office.

Petitioner believes that the cost, damages, and expenses of the proposed improvement will be less than the benefits which will result to the owners of the land likely to be benefitted thereby. Petitioner believes the proposed improvements will:

- (a) improve public health
- (b) benefit a public street
- (c) be of public utility

Petitioner agrees to pay the cost of construction of the drainage system and requests periodic maintenance assessments by the Board thereafter.

The Petitioner also agrees to the following:

1. To provide the Drainage Board a Performance Bond for the portion of the drainage system which will be made a regulated drain. The bond will be in the amount of 100% of the Engineers estimate. The bond will be in effect until construction of 100% of the system is completed and so certified by the Engineer.
2. The Petitioner shall retain an Engineer throughout the construction phase. At completion of the project the Petitioner's Engineer shall certify that the drainage system which is to be maintained as a regulated drain has been constructed as per construction plans.
3. The Petitioner agrees to request in writing to the County Surveyor any changes from the approved plan and must receive written authorization from the County Surveyor prior to implementation of the change. All changes shall be documented and given to the Surveyor to be placed in the Drain File.

4. The Petitioner shall instruct his Engineer to provide a reproducible print on a 24" x 36" mylar of the final design of the Drainage System. This shall be submitted to the County Surveyor prior to the release of the Performance Bond.
5. The Petitioner shall comply with the Erosion Control Plan as specified on the construction plans. Failure to comply with the Erosion Control Plan shall be determined by the Board as being an obstruction to the drainage system. The County Surveyor shall immediately install or repair the needed measures at Petitioners cost as per IC 36-9-27-46.

The Petitioner further requests that the Drain be classified as an Urban Drain.



Signed

MICHAEL J. KELLER
Printed Name

Signed

Printed Name

Recorded Owner(s) of Land Involved

Date _____

HAMILTON COUNTY DRAINAGE BOARD
COURT HOUSE
NOBLESVILLE, IN

In Re: _____
Hamilton County, Indiana

PETITION FOR RELOCATION AND RECONSTRUCTION AND PARTIAL VACATION

CEC Associates, LLC (hereinafter "Petitioner"), hereby petitions the Hamilton County Drainage Board for authority to relocate and improve and vacate various sections of the Osborn-Collins Drain, and in support of said petition advises the Board that:

1. Petitioner owns real estate through which a portion of the Osborn-Collins Drain runs.
2. Petitioner plans to develop its real estate with roads, buildings, utilities, storm drains, sanitary sewers and other structures.
3. Petitioner's proposed development of its real estate will require relocation and reconstruction and partial vacation of portions of the Osborn-Collins Drain, as specifically shown on engineering plans and specifications filed with the Hamilton County Surveyor.
4. The work necessary for the proposed relocation and reconstruction will be undertaken at the sole expense of the Petitioner and such work will result in substantial improvement to the Osborn-Collins Drain, without cost to other property owners on the watershed of the Osborn-Collins Drain.

WHEREFORE, Petitioner requests that an Order issue from the Hamilton County Drainage Board authorizing relocation and reconstruction of the Osborn-Collins Drain, in conformance with applicable law and plans and specifications on file with the Hamilton County Surveyor.

Michael J. Keller
Signed

Michael J. Keller
Printed Name


HAMILTON COUNTY DRAINAGE BOARD
NOBLESVILLE, INDIANAIN RE: _____)
Hamilton County, Indiana)PETITION FOR RELOCATION AND RECONSTRUCTION

CEC Associates, LLC _____ (hereinafter "Petitioner"),

hereby petitions the Hamilton County Drainage Board for authority to relocate and improve a section of the _____ Drain, and in support of said petition advises the Board that:

1. Petitioner owns real estate through which a portion of the Osborn-Collins Drain runs.
2. Petitioner plans to develop its real estate with roads, buildings, utilities, storm drains, sanitary sewers and other structures.
3. Petitioner's proposed development of its real estate will require relocation and reconstruction of a portion of the Osborn-Collins Drain, as specifically shown on engineering plans and specifications filed with the Hamilton County Surveyor.
4. The work necessary for the proposed relocation and reconstruction will be undertaken at the sole expense of the Petitioner and such work will result in substantial improvement to the Osborn-Collins Drain, without cost to other property owners on the watershed of the Osborn-Collins Drain.
5. Proposed relocation and reconstruction will not adversely affect other land owners within the drainage shed.
6. Petitioner requests approval of the proposed relocation and reconstruction under IC 36-9-27-52.5.

WHEREFORE, Petitioner requests that an Order issued from the Hamilton County Drainage Board authorizing relocation and reconstruction of the Osborn-Collins Drain, in conformance with applicable law and plans and specifications on file with the Hamilton County Surveyor.

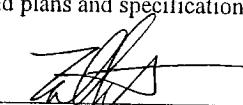

Signed John W. Clegg
Printed



51

SUBDIVISION IMPROVEMENTS PERFORMANCE BOND

Bond No. 8859565

KNOW ALL MEN BY THESE PRESENTS:

That we, Estridge Development Company, Inc., as Principal,
and Developers Surety and Indemnity Company, a Corporation organized and doing business under and by virtue of the
laws of the State of Iowa and duly licensed to conduct a general surety business in the State of IN, as Surety,
are held and firmly bound unto Hamilton County Board of Commissioners as Obligee
in the sum of Twenty One Thousand Five Hundred and No/100 Dollars
(\\$ 21,500.00) Dollars for which payment, well and truly to be made, we bind ourselves, our heirs, executors and
successors, jointly and severally firmly by these presents.

Whereas, Principal is the owner and developer of real property described as Centennial Section 3

Whereas, Principal, has, as a condition to approval of the plat for the real property, agreed to construct certain land
improvements, consisting of Erosion Control, as specified
in the plans and specifications prepared by _____; and

Whereas, Principal is required to provide security for the faithful performance of such improvements.

NOW THEREFORE, the condition of this obligation is such that so long as Principal shall well and truly perform
the conditions for plat approval, and delivers them, in good and workmanlike condition, within the time specified in such
conditions, or any extension thereof, granted by Obligee, with or without notice to Surety, then this obligation shall be void,
otherwise to remain in full force and effect, subject further to the following terms and conditions:

1. The obligation of surety shall, in no event, exceed the penal sum hereof.
2. In the event of litigation between Obligee, Surety and Principal, arising out of any breach, or to enforce any
right or obligation hereby created, the prevailing party shall be entitled to the recovery of costs and reasonable
attorneys fees.
3. This bond shall remain in full force and effect until release by the Obligee, provided further that the penal sum
hereof may be reduced upon resolution of Obligee.
4. Neither this bond, nor any right or obligation hereunder may be assigned, conveyed or hypothecated except
upon the express, written, consent of Surety and Principal.

WITNESSETH my hand and seal this 1st day of November, 20 00.

Estridge Development Company, Inc.

Principal

BY:

K. P. Den

Title: President

Developers Surety and Indemnity Company

Surety

BY:

Cynthia L. Jenkins

Cynthia L. Jenkins
Attorney-in-Fact

SIP0300

ATTEST:

HAMILTON COUNTY AUDITOR

BOARD OF COMMISSIONERS
OF THE COUNTY OF HAMILTON

DATE

CERTIFICATE OF COMPLETION AND COMPLIANCE

To: Hamilton County Surveyor

Re: CENTENNIAL, SECTION 3

I hereby certify that:

1. I am a Registered Land Surveyor or Engineer in the State of Indiana.
2. I am familiar with the plans and specifications for the above referenced subdivision.
3. I have personally observed and supervised the completion of the drainage facilities for the above referenced subdivision.
4. The drainage facilities within the above referenced subdivision to the best of my knowledge, information and belief have been installed and completed in conformity with all plans and specifications.

Signature:

Date:

3/31/01

Type or Print Name: J. CORT CROSBY P.E.

Business Address: 8901 OTIS AVE

INDIANAPOLIS, IN 46216-1037

Telephone Number: (317) 826-7306


SEAL



INDIANA REGISTRATION NUMBER

920350

Revised 10/95

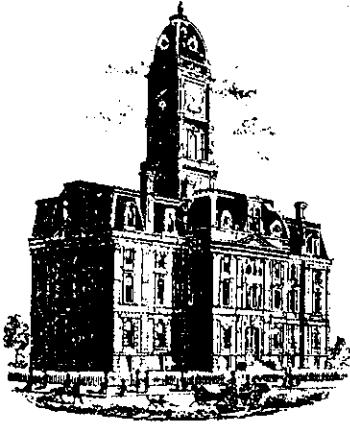

Kenton C. Ward, Surveyor

Phone (317) 776-8495

Fax (317) 776-9628

Suite 188

One Hamilton County Square

Noblesville, Indiana 46060-2230

To: Hamilton County Drainage Board

June 5, 2003

Re: Centennial Drain: Sec. 3 Arm

Attached are as-builts, certificate of completion & compliance, and other information for Centennial Sec. 3. An inspection of the drainage facilities for this section has been made and the facilities were found to be complete and acceptable.

During construction, changes were made to the drain, which will alter the plans submitted with my report for this drain-dated August 14, 2000. The report was approved by the Board at the hearing held September 25, 2000. (See Drainage Board Minutes Book 5, Pages 469-470)
The changes are as follows:

Structure:	T.C.:	I.E.:	Pipe:	Length:	Plans:	Original Difference:
497	909.32	906.67				
496	911.61	906.16	12	135	136	-1
496	911.61	906.16				
495	911.54	906.09	12	27.8	28	-0.2
495	911.54	906.09				
494	908.79	905.59	12	141.1	141	0.1
494	908.79	905.59				
476	907.5	903.6	12	380.8	383	-2.2
476	907.5	902.2				
475	906.11	901.61	24	111.3	110	1.3
475	906.11	901.61				
474	906.11	901.51	24	23.8	24	-0.2
474	906.11	901.51				
471	905.93	901.33	24	34.4	33	1.4
471	905.93	901.33				
470	905.93	900.73	30	316.5	316	0.5
470	905.93	900.73				
469	904.1	900.4	30	269.2	270	-0.8
479	907.4	904.95				
478	908.51	904.36	12	135.6	136	-0.4
478	908.51	904.31				

477	908.51	904.21	12	28.5	28	0.5
477	908.51	904.16				
476	907.9	903.1	12	143.5	141	2.5
473A	906.27	903.82				
473	907.33	903.63	12	135.5	135	0.5
473	907.33	903.63				
472	907.16	903.46	12	27.9	28	-0.1
472	907.16	903.46				
471	905.93	902.83	12	143.7	141	2.7
469	904.1	900.4				
468	904.61	900.11	30	113.6	115	-1.4
468	904.61	900.11				
467	904.58	899.74	30	28	28	0
467	904.58	899.74				
454	903.6	899.58	36	158	156	2
454	903.6	899.58				
452	903.49	899.24	36	201	203	-2
452	903.49	899.24				
444	902.62	898.82	36	177.2	176	1.2
444	902.62	898.82				
443		898.56	36	21	20	1
466	905.73	902.43				
465	905.6	902.35	12	33.5	33	0.5
465	905.6	902.35				
469	904.1	900.55	12	140	139	1
463	904.56	901.86				
462	904.56	901.06	12	134.1	135	-0.9
462	904.56	900.97				
461	904.74	900.66	15	27.7	28	-0.3
461	904.74	900.66				
458	903.85	900.45	18	125.8	125	0.8
458	903.85	900.45				
457	905.35	900.2	18	135.3	135	0.3
457	905.35	900.2				
456	905.61	900.11	18	23.9	24	-0.1
456	905.61	900.11				
454	903.6	899.8	18	180.1	180	0.1
455	904.54	901.84				
454	903.6	900.95	12	207.1	206	1.1
453	902.36	900.19				
452	903.49	899.49	12	46	48	-2
451	904.23	901.23				
450	904.18	900.98	12	23.9	24	-0.1
450	904.18	900.98				
449	902.99	900.34	12	77.1	77	0.1
449	902.99	900.34				
448	902.4	899.75	12	180.9	184	-3.1
448	902.4	899.75				

447	903.25	899.71	15	25	23	2
447	903.25	899.71				
446	903.48	899.43	15	23.7	24	-0.3
446	903.48	899.43				
445	902.84	899.21	18	138.9	133	5.9
445	902.84	899.21				
444	902.62	898.82	18	64.4	63	1.4
506	907.53	902.93				
504	905.07	902.42	12	113	110	3
504	905.07	902.42				
503	905.05	902.05	12	27.8	28	-0.2
503	905.05	902.05				
502	903.96	899.51	12	148.8	148	0.8
505	908.18	903.18				
504	905.07	902.42	12	98	100	-2
442	902.42	899.42				
441	902.5	899.33	12	24	24	0
441	902.5	899.33				
441A	903.98	898.83	15	49	48	1
441A	903.98	898.83				
440		898.51	15	118.6	122	-3.4
522	905.69	903.04				
521	907.33	902.18	12	19.3	17	2.3
518	905.21	901.86				
517	906.52	901.57	12	57.9	55	2.9
524	906.38	903.43				
523	906.48	902.92	12	24	24	0
523	906.48	902.92				
521	907.33	902.38	15	133.9	135	-1.1
521	907.33	902.18				
520	906.39	901.94	18	143.5	143	0.5
520	906.39	901.94				
519	906.43	901.9	18	24	24	0
519	906.43	901.9				
517	906.52	901.57	18	97.6	99	-1.4
517	906.52	901.47				
516	906.18	901.33	18	12.5	16	-3.5
516	906.18	901.33				
515	906.11	901.06	18	23.9	24	-0.1
515	906.11	901.06				
514	904.09	900.89	24	143.4	143	0.6
514	904.09	900.89				
513	904.25	900.63	24	140.8	141	-0.2
513	904.25	900.63				
512	904.33	900.53	24	27.9	28	-0.1
512	904.33	900.53				
511	904.98	900.38	24	39.5	41	-1.5
511	904.98	900.38				

510	903.91	900.21	24	95.1	92	3.1
540	908.985	905.85				
539	908.93	905.23	12	24	24	0
539	908.93	905.23				
538	907.83	905.13	12	23.4	23	0.4
541	901.98					
538	907.83	901.78	24	122	123	-1
538	907.83	901.78				
537	909.86	901.56	24	122	123	-1
537	909.86	909.56				
536	910.06	901.41	24	24	24	0
536	910.06	901.41				
535	907.71	901.28	24	123	123.6	-0.6
535	907.71	901.28				
534	907.79	901.14	24	122.2	123	-0.8
534	907.79	901.14				
533	907.84	901.09	24	24	0	
533	907.84	901.09				
530	905.7	900.9	24	143.1	143	0.9
530	905.7	900.9				
529	905.26	900.81	24	141.3	141	0.3
529	905.26	900.81				
528	905.28	900.78	24	28.1	28	0.1
528	905.28	900.78				
527	909.63	900.7	24	62.8	63	-0.2
527	909.63	900.7				
526	904.35	900.54	24	88.6	87	1.6
526	904.35	900.54				
525	904.35	900.35	24	28.1	28	0.1
525	904.35	900.35				
510	903.91	900.11	24	159.7	158	-0.3
532	907.25	903.5				
531	907.34	903.14	12	24.1	24	0.1
531	907.34	903.14				
530	905.1	902.7	12	22.8	23	-0.2
565		903.8				
564	908.38	903.98	24	17.5	20	-2.5
564	908.38	903.98				
563	908.53	903.83	24	24.2	24	0.2
563	908.53	903.83				
561	907.19	903.59	24	131.6	132	-0.4
561	907.19	903.49				
560	907.24	903.39	24	24.1	24	0.1
560	907.24	903.39				
559	907.59	903.16	24	133.7	131	2.7
559	907.59	903.24				
558	908.05	902.95	36	156.1	156	0.1
558	908.05	902.95				

557	907.85	902.9	36	28.4	28	0.4
557	907.85	902.9				
551		902.7	36	114.4	112	2.4
562	906.93	904.23				
561	907.19	903.59	12	40.9	41	-0.1
510	903.91	900.01				
509	904.37	899.88	30	249	249	0
509	904.37	899.88				
508	903.86	899.69	30	127.8	128	-0.2
508	903.86	899.69				
507	903.85	899.62	30	24.1	24	0.1
507	903.85	899.62				
502	903.96	899.51	30	59.6	60	-0.4
502	903.96	899.51				
501	902.57	899.31	30	161.3	161	0.7
501	902.57	899.31				
500		899.07	30	18.6	20	-1.4
500B		897.96				
500A		897.85	12	25	25	0
443B		898.08				
443A		897.68	12	25.1	25	0.1
526A	907.11	904.31				
526	904.35	900.55	12	109.2	110	-0.8
555	907.75	905				
554	908.77	904.77	12	86.6	83	3.6
556	908.23	905.43				
554	908.77	904.77	12	96.9	100	-3.1
554	908.77	904.77				
553	908.34	904.64	12	48	49	-1
553	908.34	904.64				
552	908.42	904.37	12	28.5	28	0.5
552	908.42	904.37				
551		903.43	12	145.2	146	-0.8

RCP Pipe Totals:

12	3354.5
15	377.9
18	969.9
24	2136.2
30	1367.7
36	856.1

Other Drain:	
Open Ditch	195

The length of the drain due to the changes described above is now **9257 feet**.

Note: The sub-surface drain under the curb is no longer considered a part of the regulated drain. This decision was made in the Hamilton County Commissioners' meeting and recorded in the minutes for March 8, 1999

The non-enforcement was approved by the Board at its meeting on September 25, 2000 and recorded under instrument #2001_00002889.

The bond or letter of credit from Frontier Insurance Co, number 885649A, 885956S; dated June 29, 2000, November 1, 2000; in the amount of \$432,306 and \$21,500; was released April 23, 2001 and October 8, 2001.


I recommend the Board approve the drain's construction as complete and acceptable.

Sincerely,




Kenton C. Ward,
Hamilton County Surveyor

KCW/slm

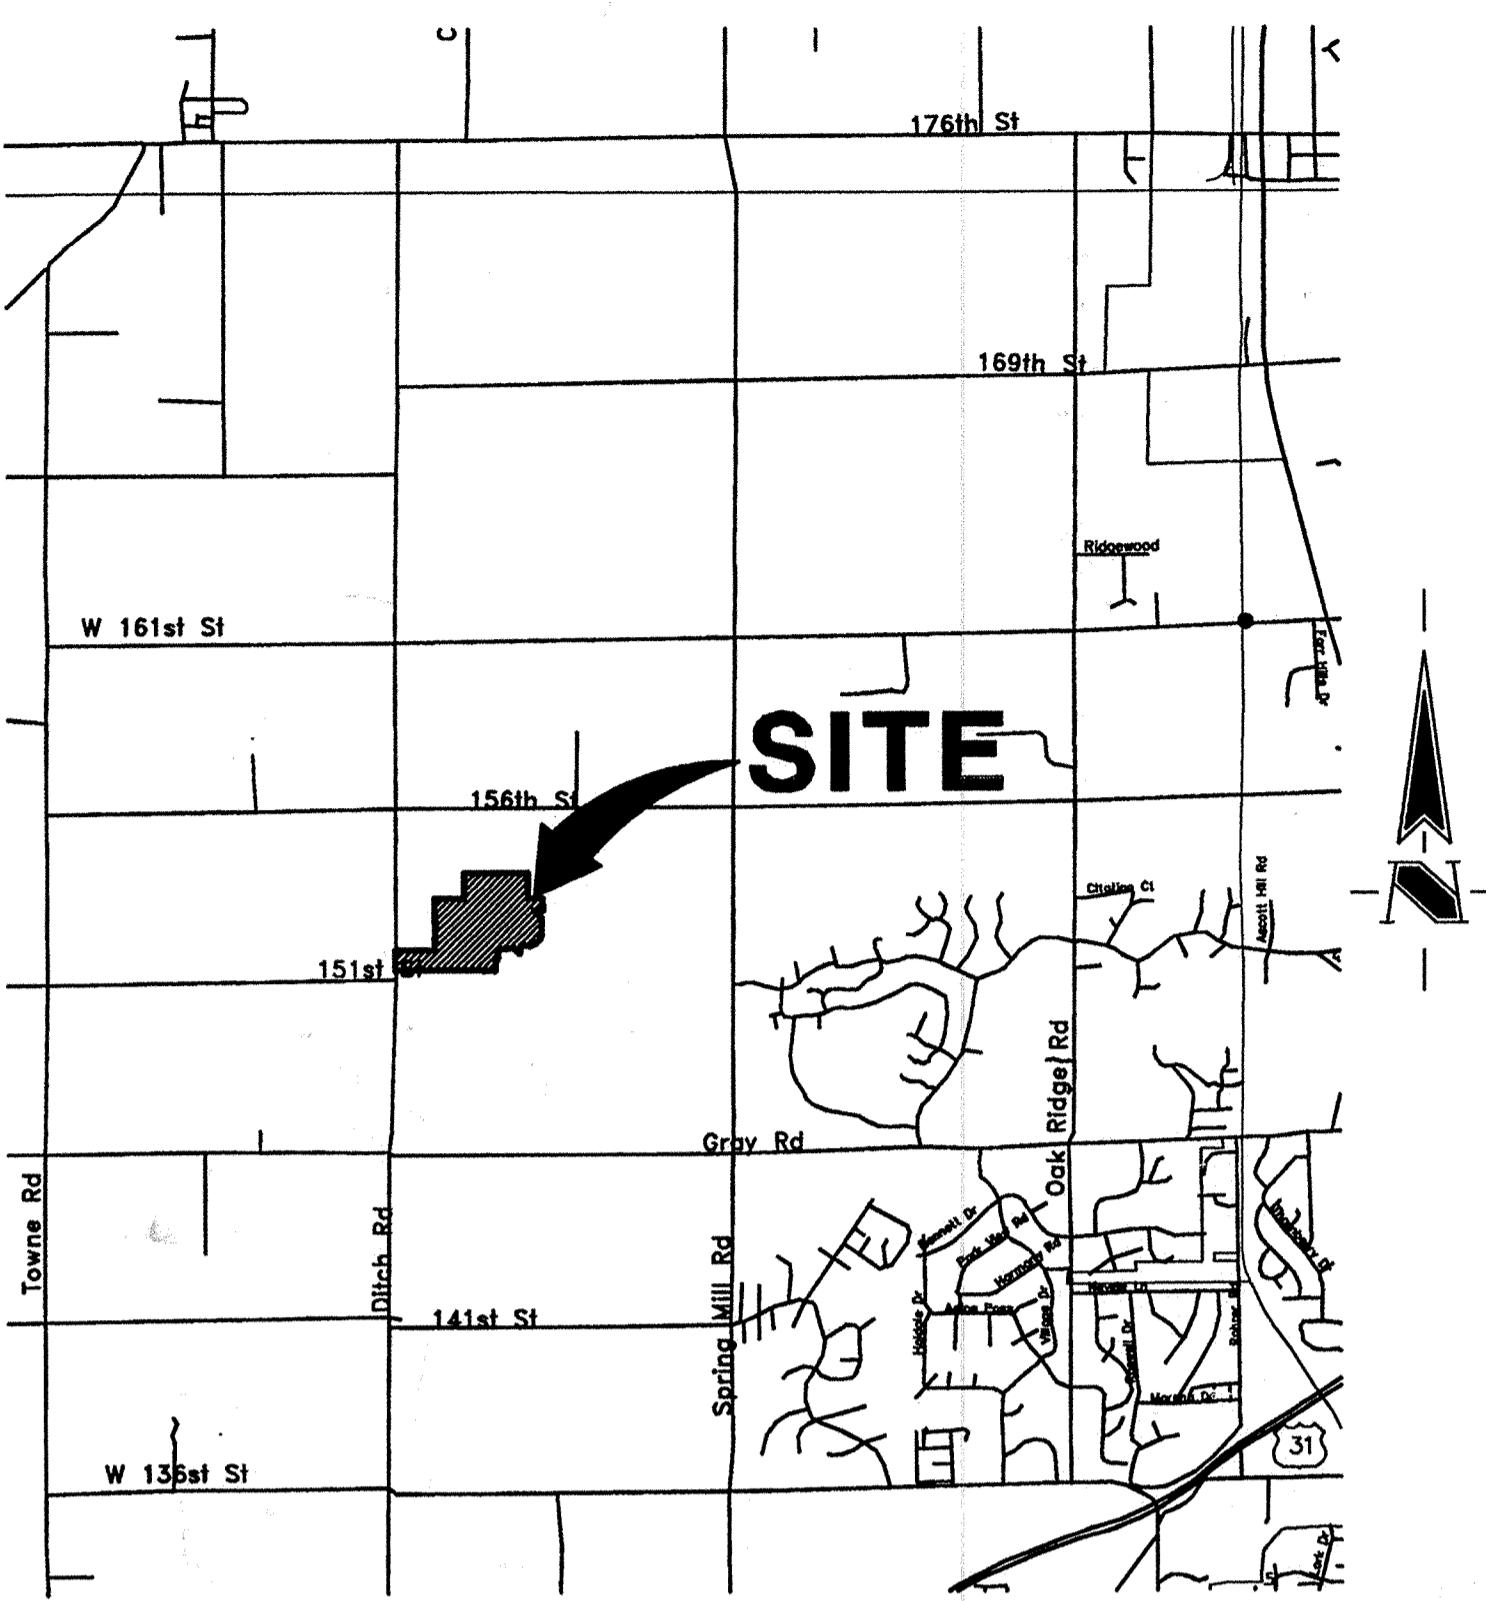


AREA MAP

SCALE: 1"=3000'

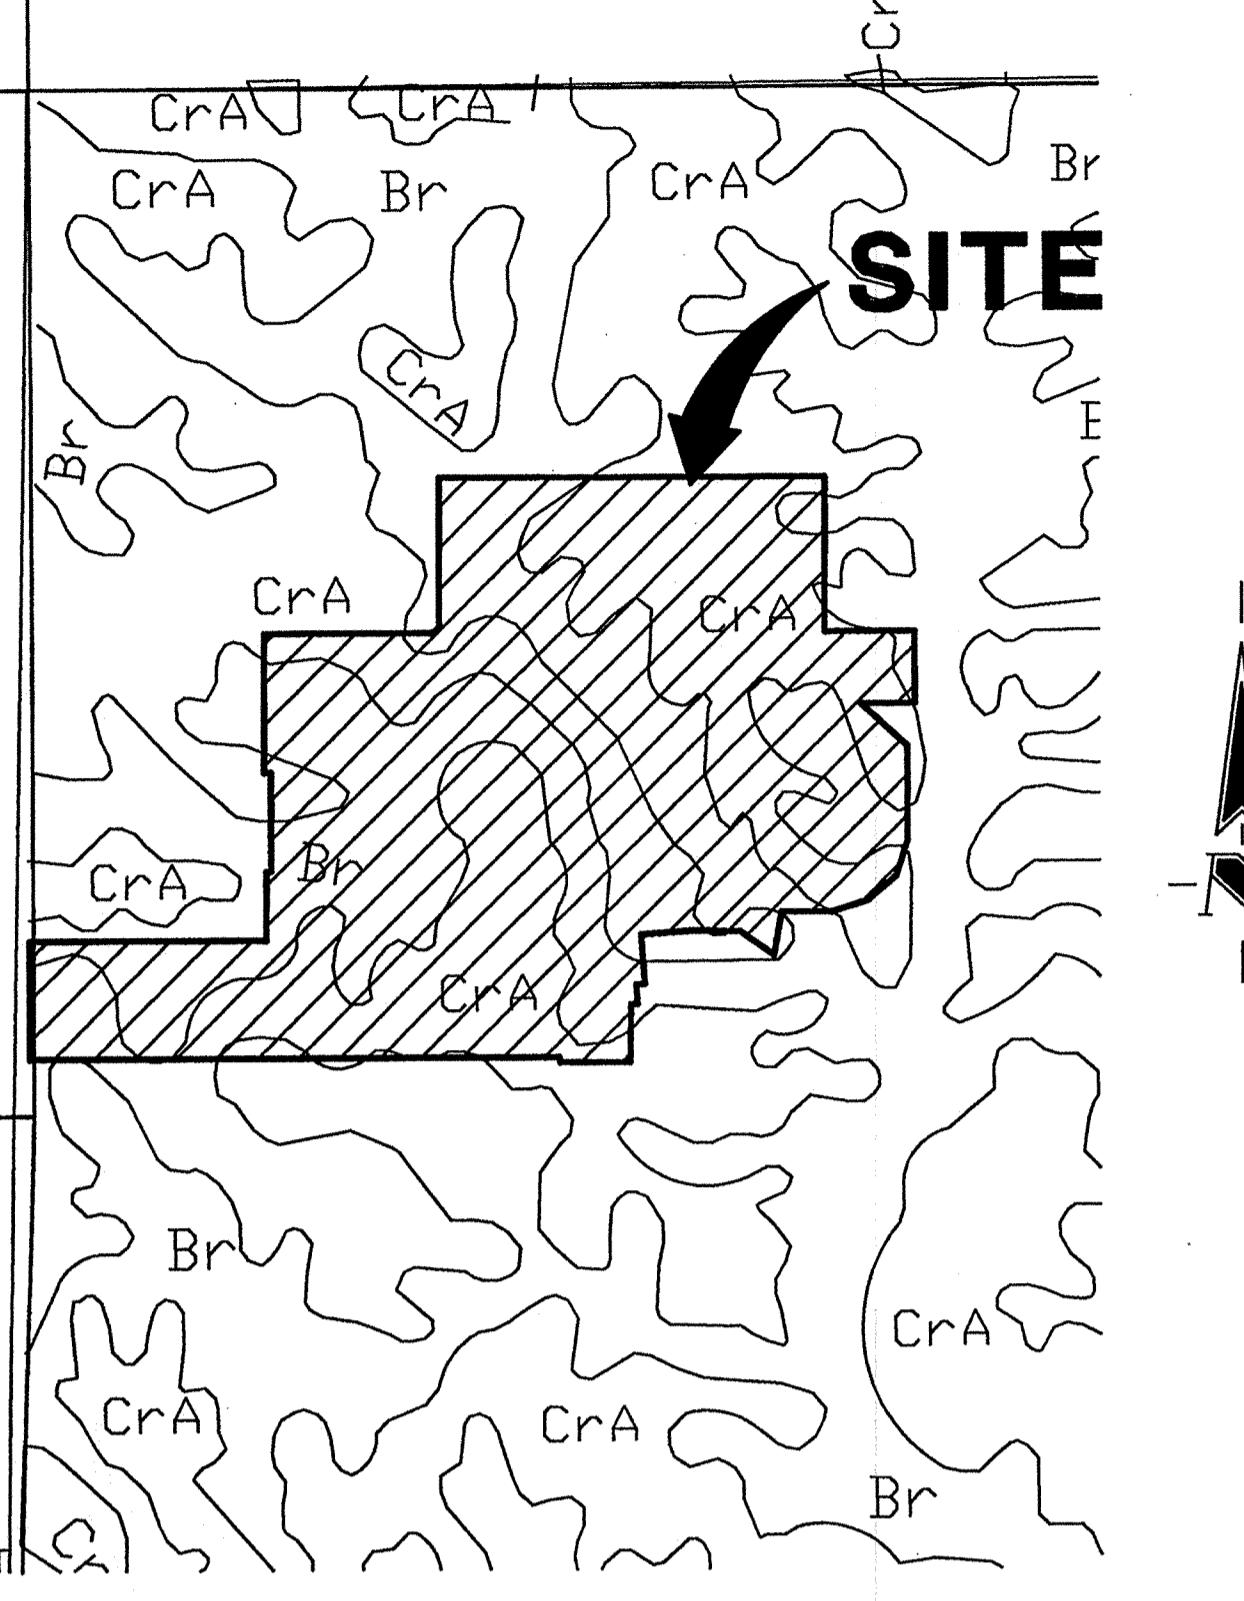

SOILS MAP

SCALE: 1"=500'

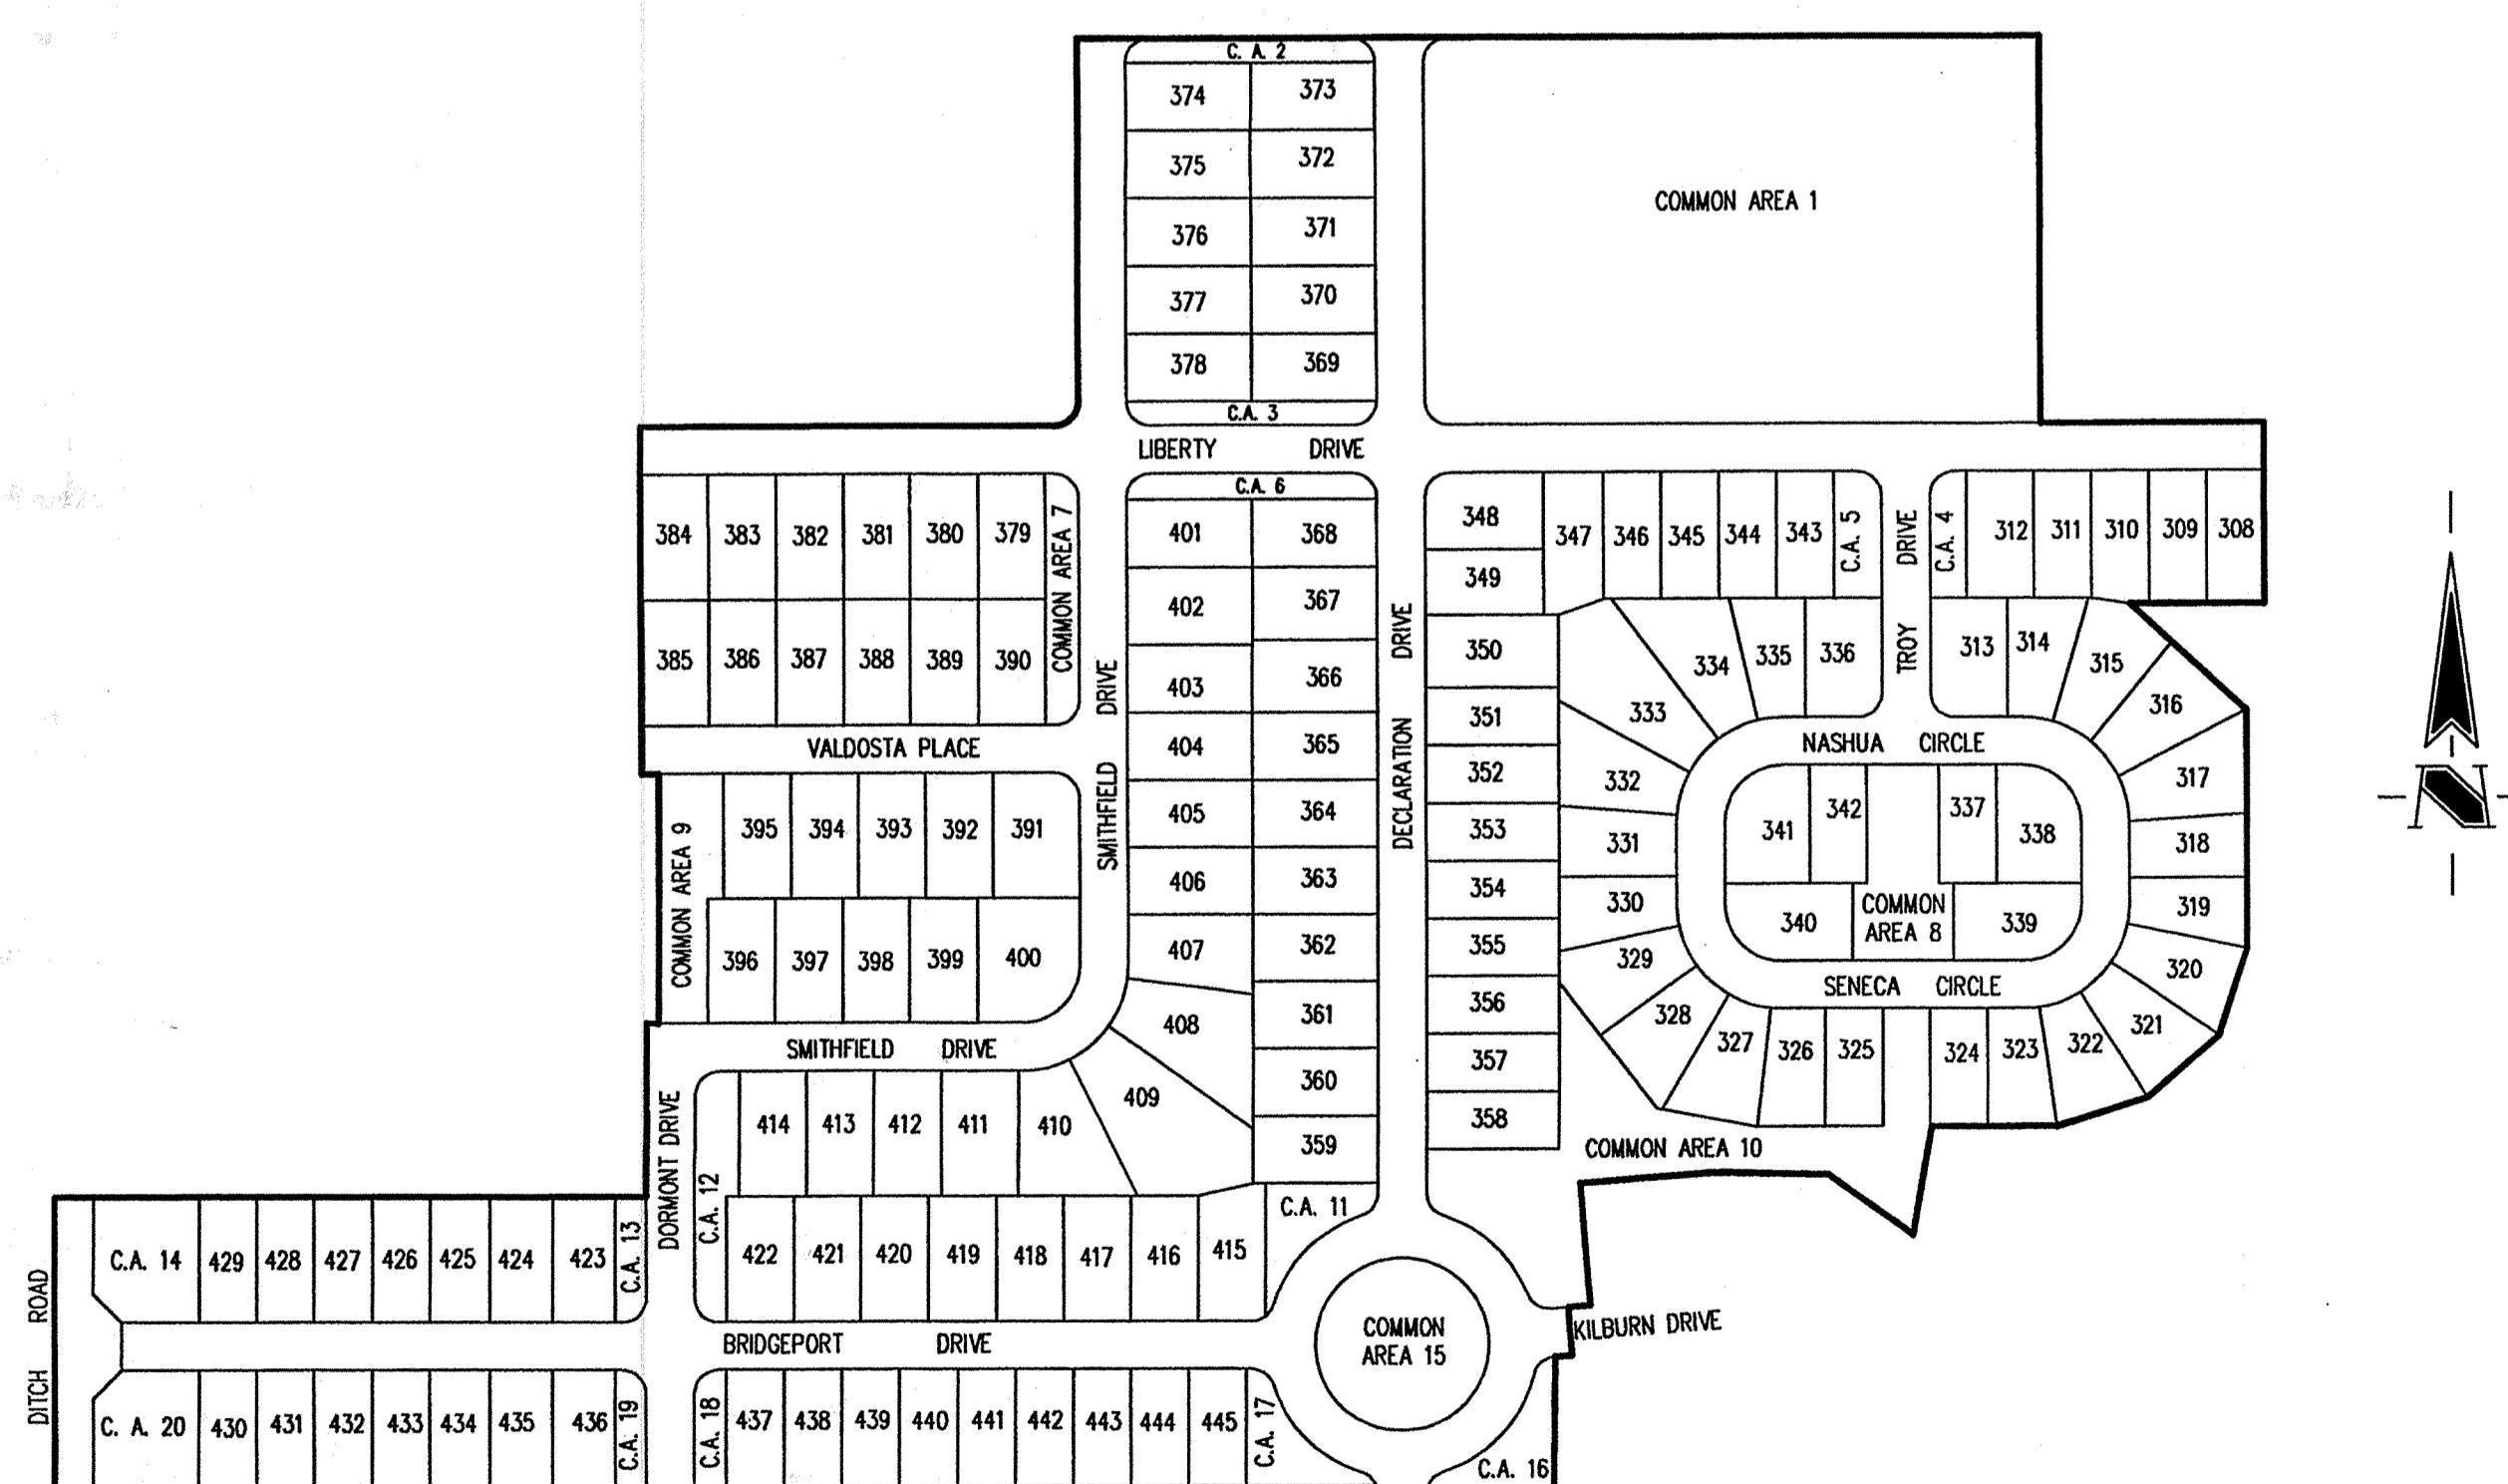

SITE MAP

SCALE: 1"=200'

- SEC. 15-T18N-R3E -

CENTENNIAL SECTION 3

(CONSTRUCTION PLANS)

HAMILTON COUNTY WESTFIELD, INDIANA

DEVELOPER:

ESTRIDGE DEVELOPMENT CO., INC.

1041 WEST MAIN STREET

CARMEL, INDIANA 46032

(317) 582-2456

INDEX	
SHEET No.	DESCRIPTION
C100	COVER SHEET
C101-C104	DEVELOPMENT PLAN
C105	STRUCTURE DATA AND INFORMATION
C106-C109	EROSION CONTROL PLAN
C110	EROSION CONTROL DETAILS
C201-C207	STREET PLAN
C301	ENTRANCE PLAN
C302, C303	INTERSECTION DETAILS
C304	TRAFFIC CONTROL PLAN
C305	MAINTENANCE OF TRAFFIC
C401-C409	SANITARY SEWER PLAN
C601-C608	STORM SEWER PLAN
C701-C703	WATER DISTRIBUTION PLAN
C704	WATER DISTRIBUTION DETAILS
C801-C804	GENERAL DETAILS
C901	SPECIFICATIONS


* 25 MPH DESIGN SPEED PER
HAMILTON CO. H.W. DEPT.



The
Schneider
Corporation

3020 North Post Road
Indianapolis, Indiana 46226-6518
Engineering
Surveying
Landscape Architecture
GIS & LIS
317-898-8282
317-899-8010 Fax
Geology

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CORPORATION. THE HOLDER IS RESPONSIBLE
FOR VERIFYING THAT THESE DOCUMENTS
ARE THE MOST CURRENT PRIOR TO USE.

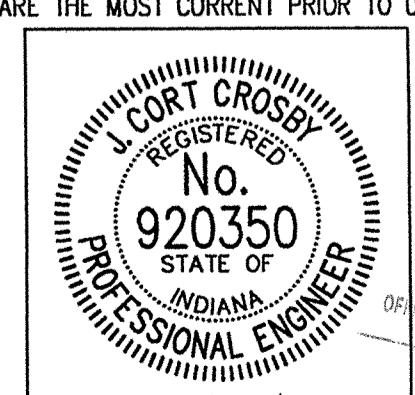

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APR 5 2001

DATE: 3/31/01
SHEET C100
OF 49

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J. Cort Crosby
CERTIFIED BY: J. CORT CROSBY, P.E.
E-MAIL ADDRESS:
ccrosby@theschneidercorp.com

REVISIONS:		
DATE: 07/03/00	BY: DRP	DESCRIPTION: C100, C101, C606-C608, C802. (PER HAMILTON COUNTY SURVEYOR'S COMMENTS.)
08/11/00	PRC	Sheets not revised: C103, C108, C110, C204, C303, C305, C406-C408, C704, C801-C804, C901.
10/18/00	PRC	C100 & C901.
10/31/00	PRC	C100-C104, C106, C201-C207 & C601-C608.
11/09/00	PRC	C100, C104 & C301.
03/23/01	DRP	C100, C101-C104, C601-C608

PROJECT ENGINEER: _____
CHECKED BY: _____ DATE CHECKED: _____

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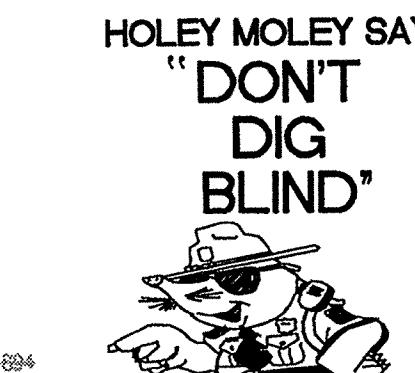
JOB No. (753.003)

FILE NAME: J:\753\003\DWGS\C100

STORM SEWER
SUB-SURFACE DRAIN
RECORD DRAWINGS

GENERAL NOTES

- ALL GRADES AT BOUNDARY SHALL MEET EXISTING GRADES.
- IT SHALL BE THE RESPONSIBILITY OF EACH SUBCONTRACTOR TO VERIFY ALL EXISTING UTILITIES AND CONDITIONS PERTAINING TO HIS PHASE OF WORK. IT SHALL ALSO BE THE SUBCONTRACTOR'S RESPONSIBILITY TO CONTACT THE OWNERS OF THE VARIOUS UTILITIES FOR PROPER STAKE LOCATION OF EACH UTILITY BEFORE WORK IS STARTED. THE SUBCONTRACTOR SHALL NOTIFY IN WRITING THE OWNER AND THE ENGINEER OF ANY CHANGES, OMISSIONS, OR ERRORS FOUND ON THESE PLANS OR IN FIELD BEFORE WORK IS STARTED OR RESUMED.
- STANDARD SPECIFICATIONS FOR THE HAMILTON WESTERN UTILITIES SHALL APPLY FOR ALL SANITARY SEWERS.
- ANY PART OF THE SANITARY OR STORM SEWER TRENCHES RUNNING UNDER PAVED AREAS TO BE BACKFILLED WITH GRANULAR MATERIAL.
- THE SIZE AND LOCATION OF EXISTING UTILITIES SHOWN ARE PER INFORMATION PROVIDED BY THE RESPECTIVE UTILITY COMPANIES. ALL UTILITY COMPANIES SHOULD BE NOTIFIED PRIOR TO ANY EXCAVATION FOR FIELD LOCATION OF SERVICES.
- SERVICE WALKS SHALL BE NON-REINFORCED CONCRETE 4" THICK AND 4' IN WIDTH.
- 4' CONCRETE SERVICE WALK ACROSS FRONTAGE OF EACH LOT TO BE CONSTRUCTED BY OTHERS.
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- TEMPORARY TRAFFIC CONTROL DURING CONSTRUCTION TO CONFORM TO APPLICABLE LOCAL AND STATE STANDARDS.
- ALL CONSTRUCTION ACTIVITY ON THIS SITE TO BE PERFORMED IN COMPLIANCE WITH APPLICABLE O.S.H.A. STANDARDS FOR WORKER SAFETY.
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IT IS AGAINST THE LAW TO EXCAVATE
WITHOUT NOTIFYING THE UNDERGROUND
LOCATION SERVICE TWO (2) WORKING
DAYS BEFORE COMMENCING WORK.

ASSUMED NORTH
SCALE: 1"=50'

NOTE:
FOR STRUCTURE DATA TABLES
AND OTHER INFORMATION SEE
SHEET C105.

BENCHMARK

BM - U.S.G.S. 93 RHP (1951)
BRASS DISK IN CONCRETE POST S.W. CORNER OF 146TH AND
DITCH ROAD.
ELEV. = 903.373

TBM #9
R.R. SPIKE 1.3' UP NORTH SIDE OF MAPLE± S.E. CORNER SITE.
ELEV. = 908.39

Revisions
1. DRP 07/3/00 ADDED EXISTING 4" & 7" DRAIN TILE LOCATIONS, ADDED RIP-RAP AT
PRC 08/11/00 REV. LAYOUT IN LOOP AREA, LOT & STREET GRADING, ADJUSTED
STORM SEWERS, SSOS & WATER.
3. PRC 10/31/00 REMOVED REAR YARD SSOS, ADDED TEES AT FRONT OF LOTS &
ADJUSTED SIDE YARD ESMT. ON LOT 312.
4. DRP 03/23/01 STORM SEWER & SUB-SURFACE RECORD DRAWING.
5. DRP 03/23/01 SUB-SURFACE DRAIN RECORD DRAWING.

CERTIFICATION FOR "RECORD DRAWING"

NOTE:
Record drawing certification for sub-surface drain marker
location only.



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3/3/01

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CENTENNIAL SECTION 35 2001
WESTFIELD, INDIANA HAMILTON COUNTY SURVEYOR


DEVELOPMENT PLAN SUB-SURFACE DRAIN LOCATIONS


Date	Project No.	Drawn	PRC	Approv.
04/12/00	753.003			

Computer Files
J:\753\003\DWGS\C101XSD
XREF: J:\753\003B
XREF: J:\753\002\DWGS\002BS
XREF: J:\753\005\DWGS\005BS

Sheet No. **C101**

SUB-SURFACE DRAIN RECORD DRAWING

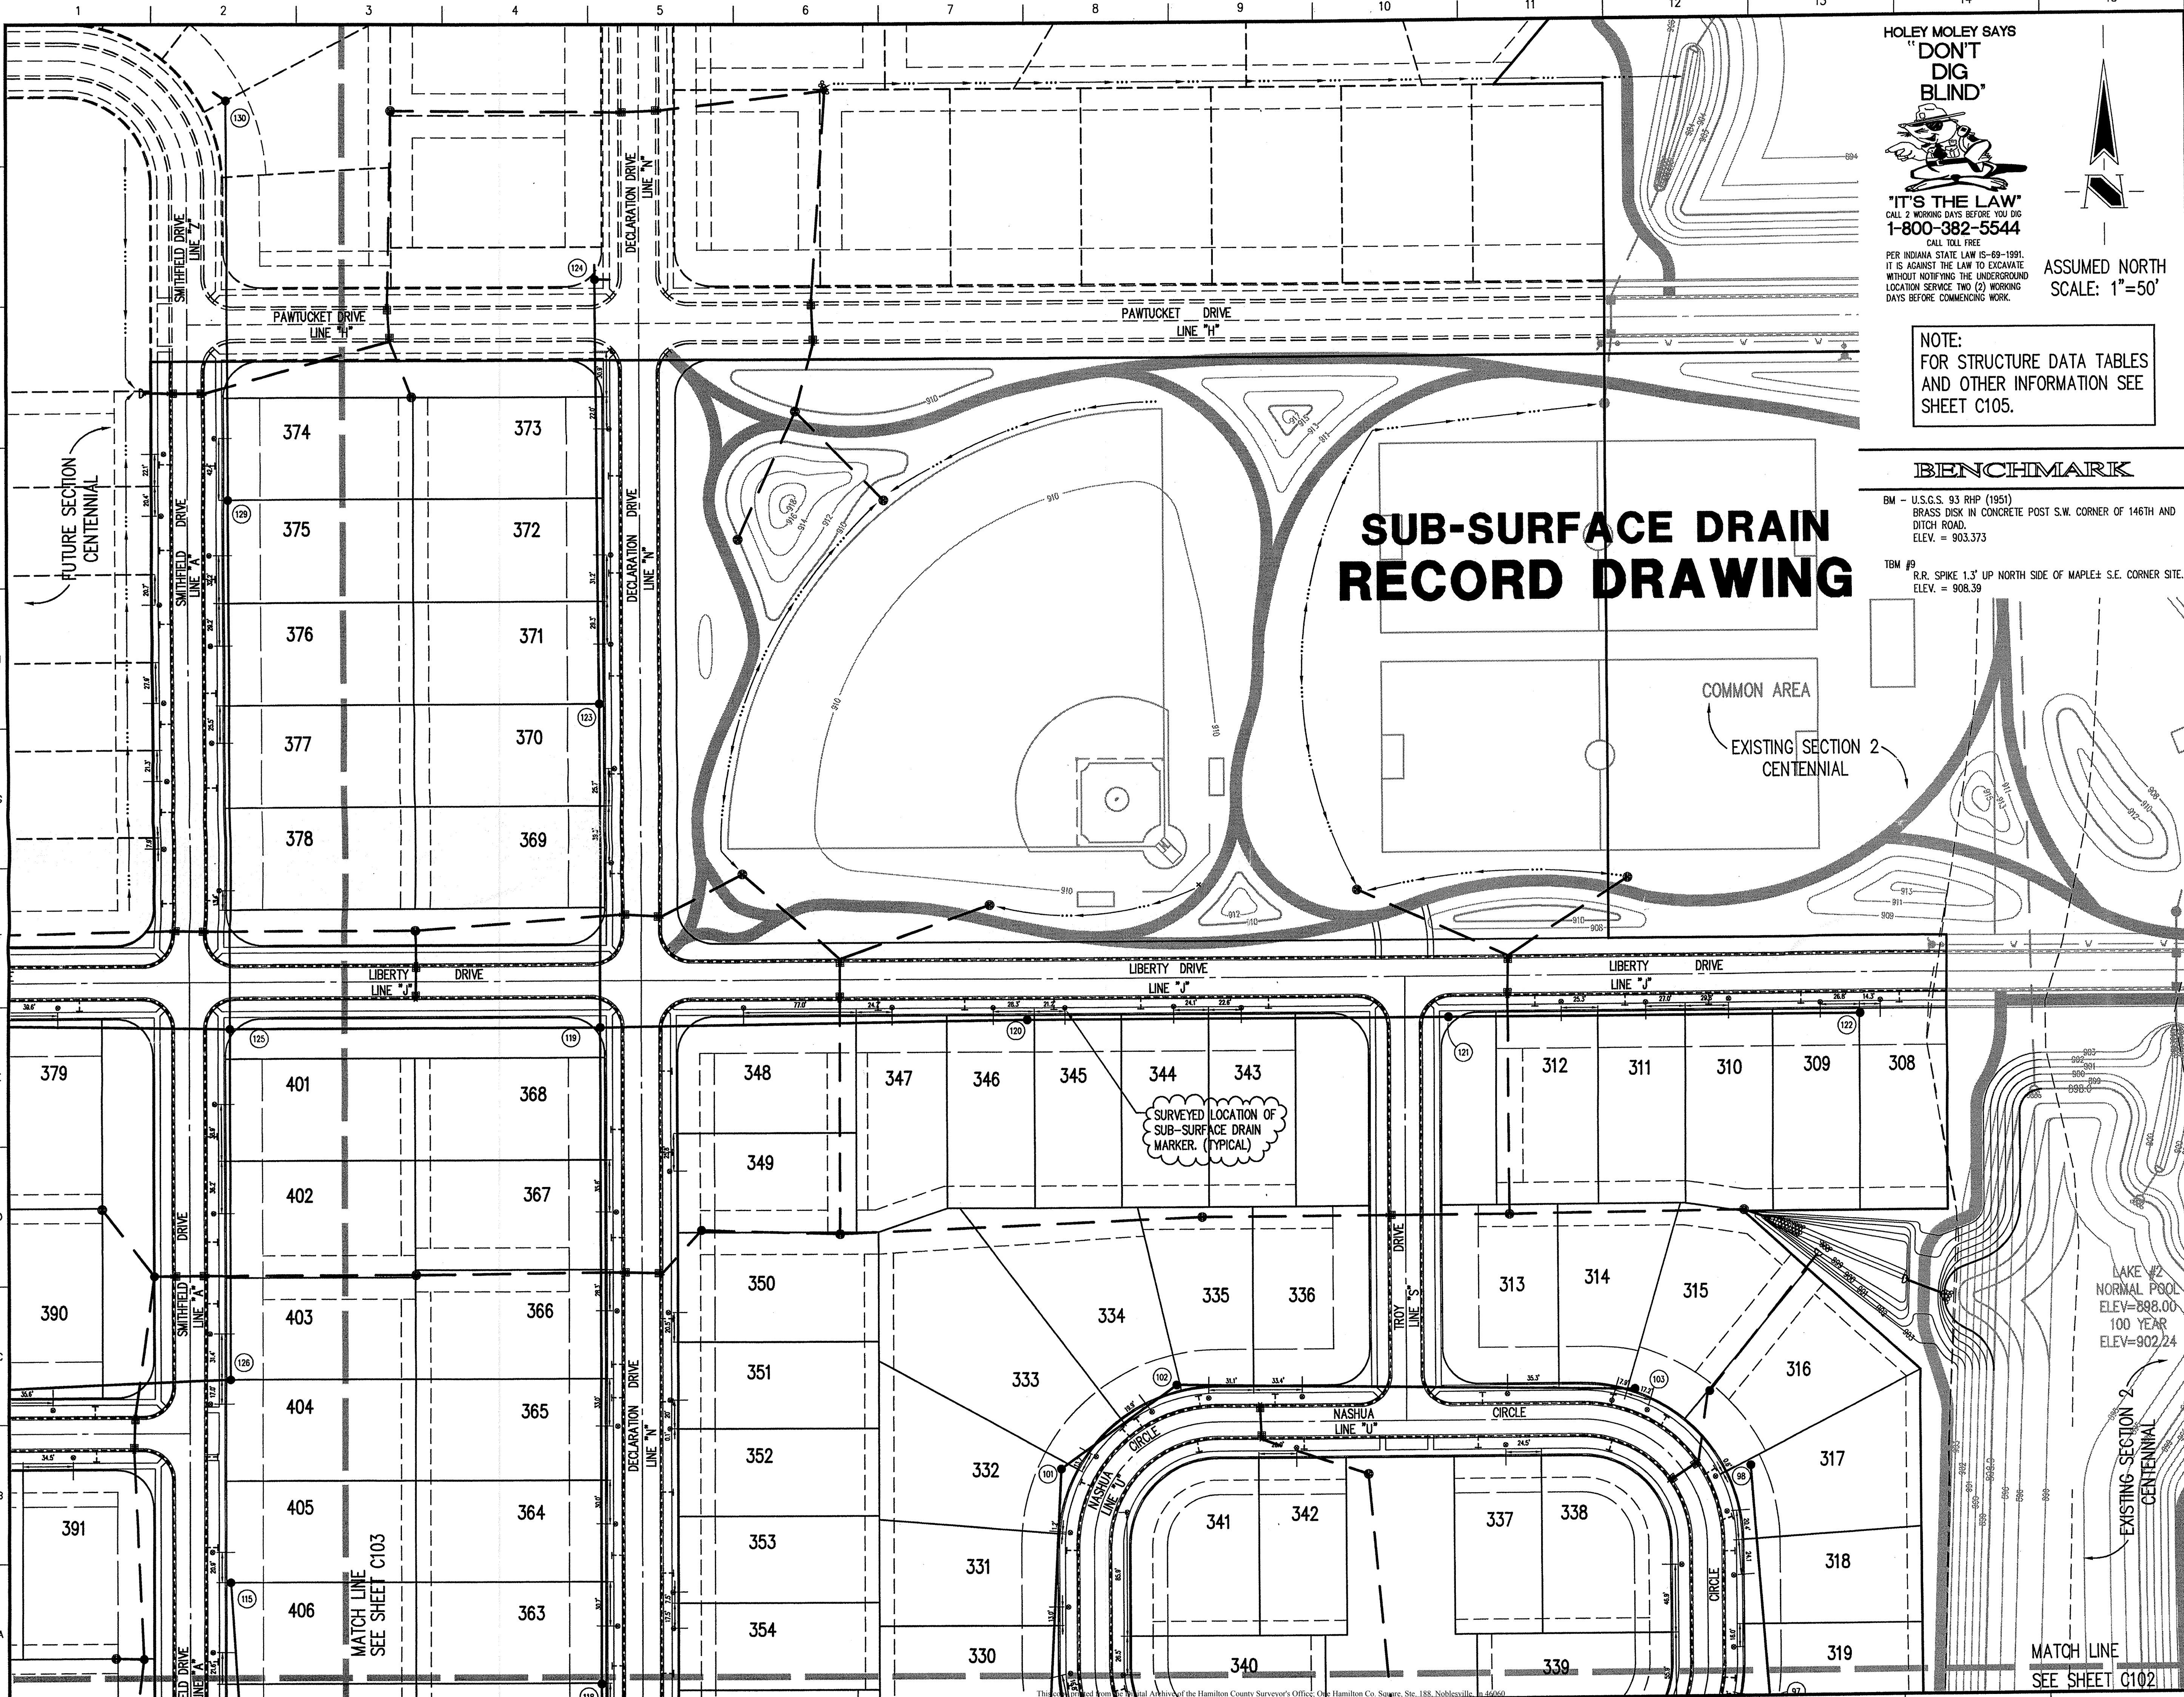

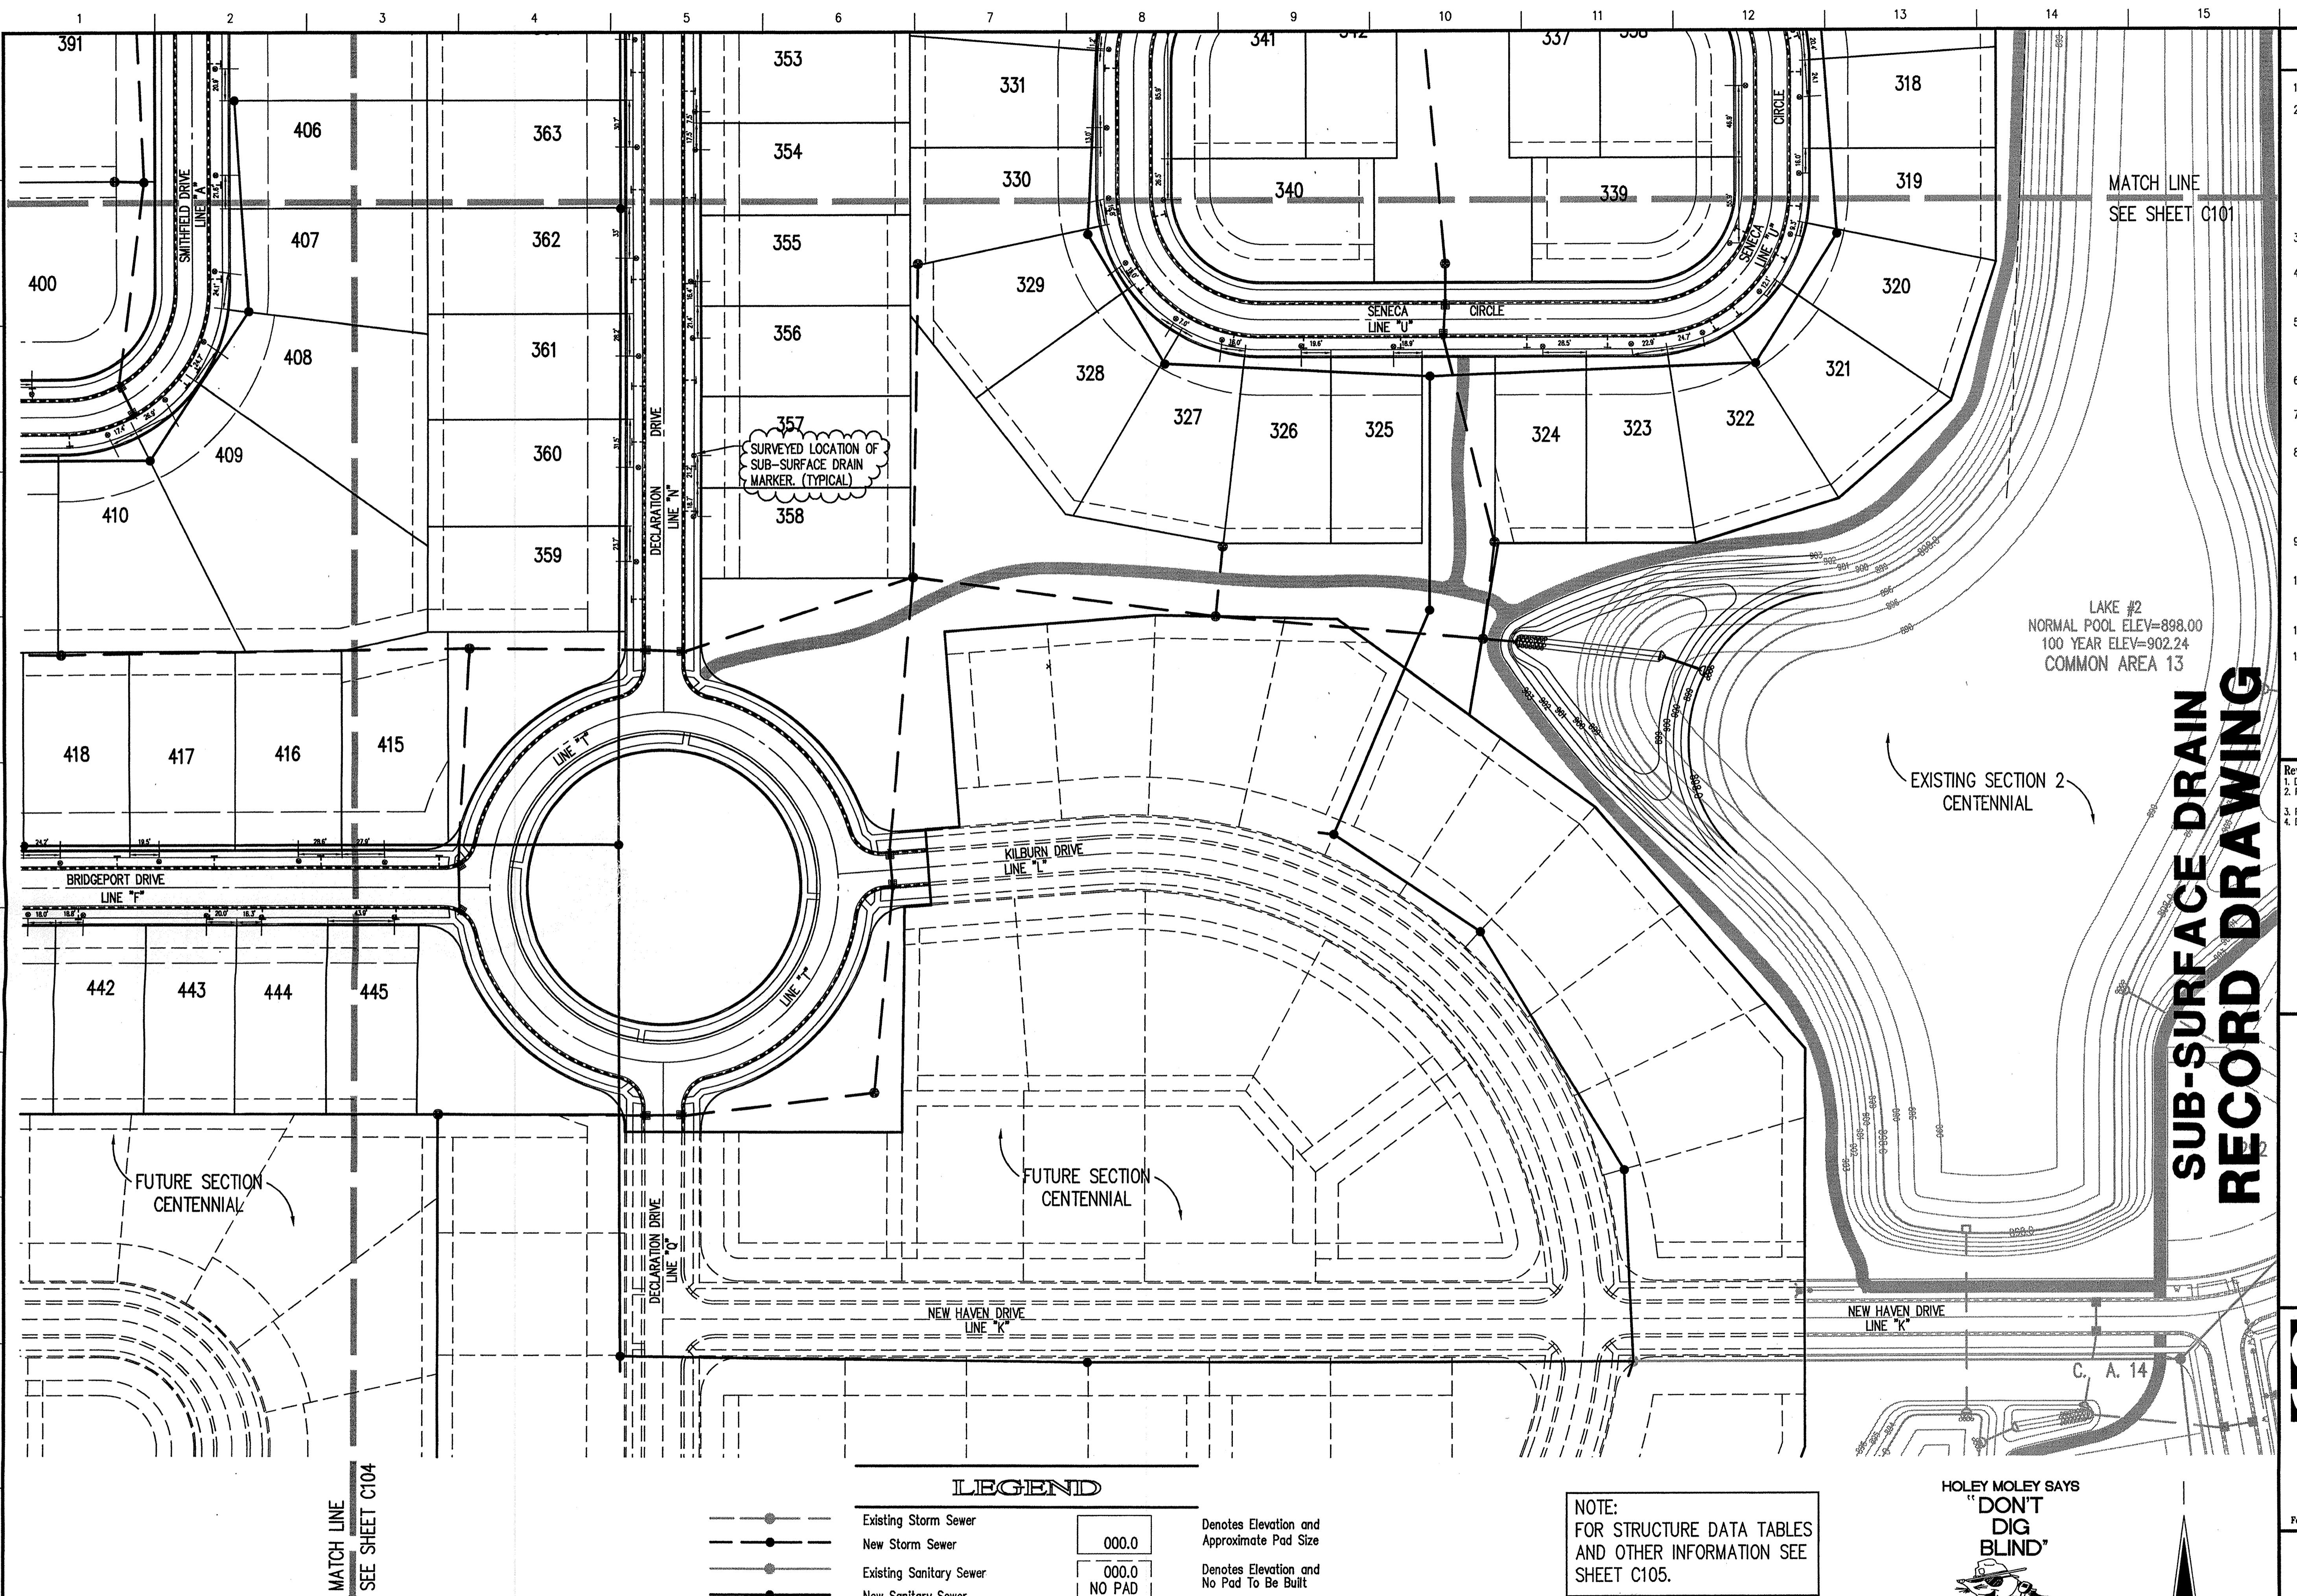

SUB-SURFACE DRAIN RECORD DRAWING

NOTE:
Record drawing certification for sub-surface drain marker location.



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ESTRIDGE DEVELOPEMENT CO., INC.
CENTENNIAL SECTION 3
WESTFIELD, INDIANA

DEVELOPMENT PLAN
SUB-SURFACE DRAIN LOCATIONS

4/12/00	Project No. 753.003	Brown PRC	Apprv.
Computer Files 753.003\DWGS\C102XSRD		Sheet No.	

F: J:\753\002\DWGS\002BS
F: J:\753\004\DWGS\004BS

GENERAL NOTES

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 2. IT SHALL BE THE RESPONSIBILITY OF EACH SUBCONTRACTOR TO VERIFY ALL EXISTING UTILITIES AND CONDITIONS PERTAINING TO HIS PHASE OF WORK. IT SHALL ALSO BE THE SUBCONTRACTOR'S RESPONSIBILITY TO CONTACT THE OWNERS OF THE VARIOUS UTILITIES FOR PROPER STAKE LOCATION OF EACH UTILITY BEFORE WORK IS STARTED. THE SUBCONTRACTOR SHALL NOTIFY IN WRITING THE OWNER AND THE ENGINEER OF ANY CHANGES, OMISSIONS, OR ERRORS FOUND ON THESE PLANS OR IN FIELD BEFORE WORK IS STARTED OR RESUMED.
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visions
DRP 07/3/00 ADDED EXISTING 4" & 7" DRAIN TILE LOCATIONS.
PRC 08/11/00 REV. LAYOUT IN LOOP AREA, LOT & STREET GRADING, ADJUSTED
STORM SEWERS, SSDS & WATER.
PRC 10/31/00 REMOVED REAR YARD SSDS & ADDED SSDS TEES AT FRONT OF LOTS.
DRP 03/23/01 SUR-SURFACE DRAIN RECORD DRAWINGS.

RECORD DRAWING

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ESTRIDGE DEVELOPEMENT CO., INC.
CENTENNIAL SECTION 3
WESTFIELD, INDIANA

DEVELOPMENT PLAN
SUB-SURFACE DRAIN LOCATIONS

4/12/00	Project No. 753.003	Brown PRC	Apprv.
Computer Files 753.003\DWGS\C102XSRD		Sheet No.	

F: J:\753\002\DWGS\002BS
F: J:\753\004\DWGS\004BS

LEGEND

MATCH LINE	SEE SHEET	
	Existing Storm Sewer	
	New Storm Sewer	
	Existing Sanitary Sewer	
	New Sanitary Sewer	
	Existing Contour	
	New Pavement Grade	
	All Other Finish Grades	MFPG=000.0
	Storm Structure Number	
	Sanitary Structure Number	
	Flow Arrow	

NOTE:
FOR STRUCTURE DATA TABLES
AND OTHER INFORMATION SEE
SHEET C105.

BENCHMARK


TBM #9
R.R. SPIKE 1.3' UP NORTH SIDE OF MAPLE± S.E. CORNER SITE.
ELEV. = 908.39



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ASSUMED NORTH
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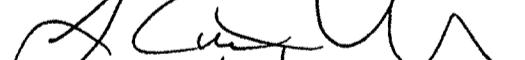
Revisions

1. DRP 07/03/00 ADDED EXISTING 4" & 7" DRAIN TILE LOCATIONS.
2. PRC 10/31/00 REMOVED REAR YARD SSDS & ADDED SSDS TEES AT FRONT OF LOTS.
3. DRP 03/23/01 SUB-SURFACE DRAIN RECORD DRAWING.

**CERTIFICATION FOR
"RECORD DRAWING"**

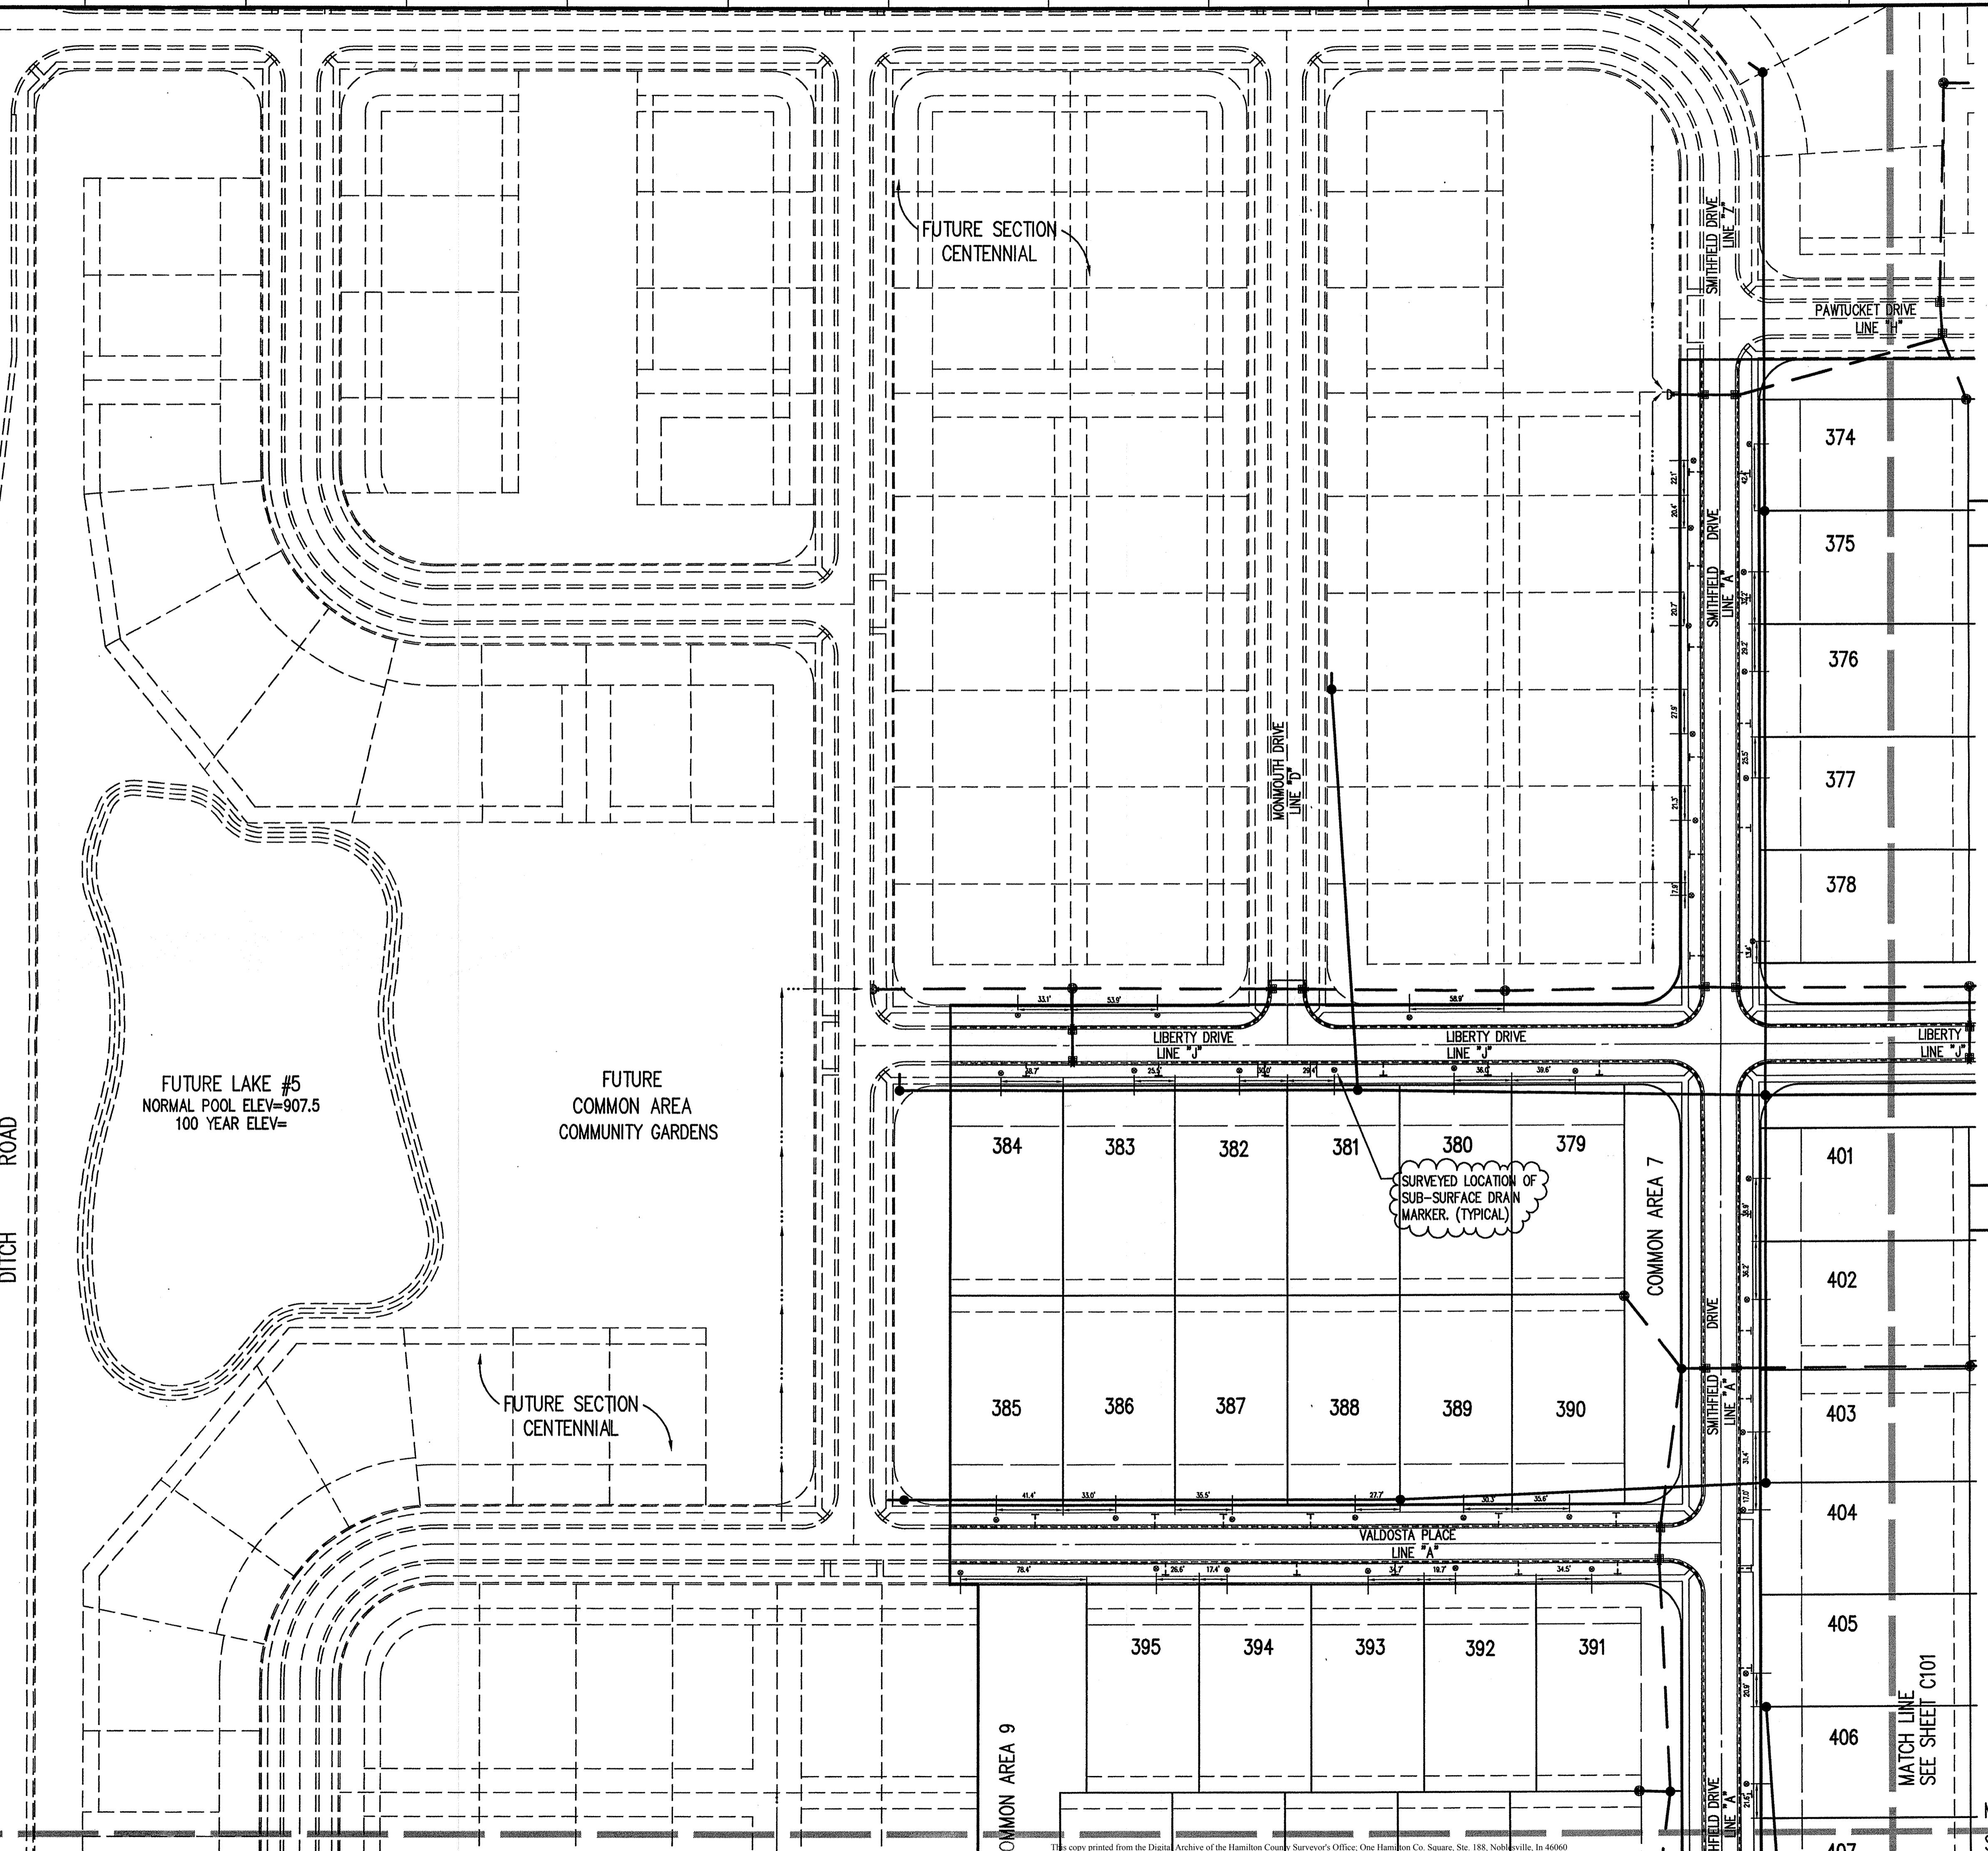NOTE:
Record drawing certification for sub-surface drain marker location and



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ESTRIDGE DEVELOPEMENT CO., INC.
CENTENNIAL SECTION 3
WESTFIELD, INDIANA

DEVELOPMENT PLAN SUB SURFACE DRAIN LOCATIONS

SUB-SURFACE DRAIN LOCATIONS			
Date	Project No.	Drawn	Approved
04/12/00	753.003	PRC	
Computer Files			Sheet No.
J:\753\003\DWGS\C103XSRD XREF: 003BS XREF: J:\753\002\DWGS\002BS XREF: J:\753\004\DWGS\004BS XREF: J:\753\005\DWGS\005BS			C103



LEGEND

Existing Storm Sewer		Denotes Elevation and Approximate Pad Size	
New Storm Sewer		Denotes Elevation and Approximate Pad Size	
Existing Sanitary Sewer		Denotes Elevation and Approximate Pad Size	
New Sanitary Sewer		Denotes Elevation and Approximate Pad Size	
Existing Contour		Denotes Elevation and Approximate Pad Size	
New Pavement Grade		Denotes Elevation and Approximate Pad Size	
All Other Finish Grades		Denotes Elevation and Approximate Pad Size	
Storm Structure Number		Denotes Minimum Flood Protection Grade	
Sanitary Structure Number		Flood Routing	
		6" S.S.D. With 2' Deep Riser And 4" Lot Lateral	

MATCH LINE
SEE SHEET C102

BENCHMARK

BM - U.S.G.S. 93 RHP (1951)
BRASS DISK IN CONCRETE POST S.W. CORNER OF 146TH AND DITCH ROAD.
ELEV. = 903.373

TBM #9
R.R. SPIKE 1.3' UP NORTH SIDE OF MAPLE± S.E. CORNER SITE.
ELEV. = 906.39

SUB-SURFACE DRAIN RECORD DRAWING


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Rewvisions

- DRP 07/03/00 ADDED EXISTING 4" & 7" DRAIN TILE LOCATIONS.
- PRC 08/11/00 EXTENDED LOTS SOUTH OF BRIDGEPORT DRIVE, STORM, SSDS, DITCH ROAD.
- PRC 10/31/00 REMOVED REAR YARD SSDS & ADDED SSDS TEES AT FRONT OF LOTS.
- PRC 11/09/00 ADDED DITCH ROAD WIDENING & SHOULDER, ADDED CORNER CUTS AT R.O.W. AT ENT. & 2' NON-ASSTM. ESMT. IN COMMON AREA AT ENT.
- DRP 03/23/01 SUB-SURFACE DRAIN RECORD DRAWING.

CERTIFICATION FOR "RECORD DRAWING"

NOTE:
Record drawing certification for sub-surface drain marker location only.

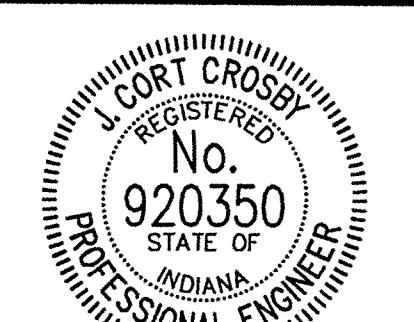

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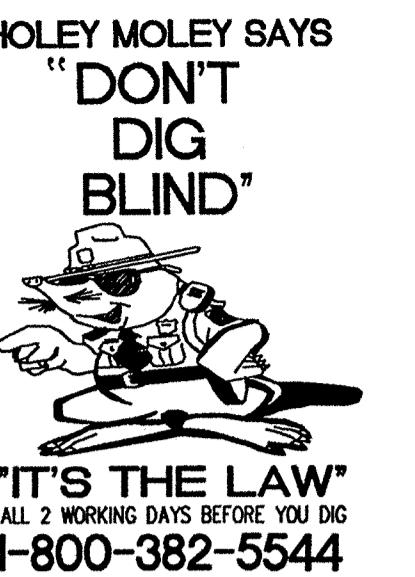
DEVELOPMENT PLAN SUBSURFACE DRAIN LOCATIONS

Date	Project No.	Drawn	Approved
04/12/00	753.003	PRC	

Computer Files	Sheet No.
L:\753\003\DWGS\104XSRD XREF: J:\753\003\DWGS\002BS XREF: J:\753\002\DWGS\002BS XREF: J:\753\004\DWGS\004BS	C104

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DAYS BEFORE COMMENCING WORK.

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BRASS DISK IN CONCRETE POST S.W. CORNER OF 146TH AND
DITCH ROAD
ELEV. = 903.373

TBM #9
R.R. SPIKE 1.3' UP NORTH SIDE OF MAPLE± S.E. CORNER SITE.
ELEV. = 908.39

Revisions:
MC 08/11/00 REVISIONS PER LOT LAYOUT REQUESTED BY CLIENT.
2. PRC 10/31/00 REMOVED REAR YARD SSDS & ADDED SSDS TEES AT FRONT OF LOTS.
3. DRP 03/23/01 STORM SEWER RECORD DRAWING.

CERTIFICATION FOR "RECORD DRAWING"

NOTE:
Record drawing certification for top of casting, invert elevations, and lengths of pipe only. Slope percentage
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CENTENNIAL SECTION 3 2001
WESTFIELD, INDIANA HAMILTON COUNTY SURVEYOR

STORM SEWER PLAN

Date	Project No.	Drawn	Approved
04/12/00	753.003	DRP	

Computer Files	Sheet No.
A:\753.003\DWGS\c601	C601
XREF: STORM	
XREF: D0135	
XREF: J:\753.002\DWGS\002BS	
XREF: J:\753.004\DWGS\004BS	

STORM SEWER PLAN

SCALE: 1"=50'

STORM SEWER PROFILE

STORM SEWER RECORD DRAWING

SCALE: HORIZ.: 1"=50'
VERT.: 1"=5'

LEGEND		
Existing Grade	New Grade	Granular Backfill

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CERTIFIED BY
J. C. Crosby
3/31/01

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ESTRIDGE DEVELOPMENT CO., INC.
CENTENNIAL SECTION 3
WESTFIELD, INDIANA
OFFICE OF HAMILTON COUNTY SURVEYOR

FILED
APR 05 2001

STORM SEWER PLAN


Date 04/12/00	Project No. 753.003	Drawn DRP	Approved
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Sheet No. C602

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STORM SEWER RECORD DRAWING


LEGEND



SCALE: HORIZ.: 1"=50'
VERT.: 1"=5'

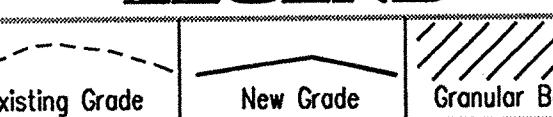
STORM SEWER PROFILE

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STORM SEWER PLAN

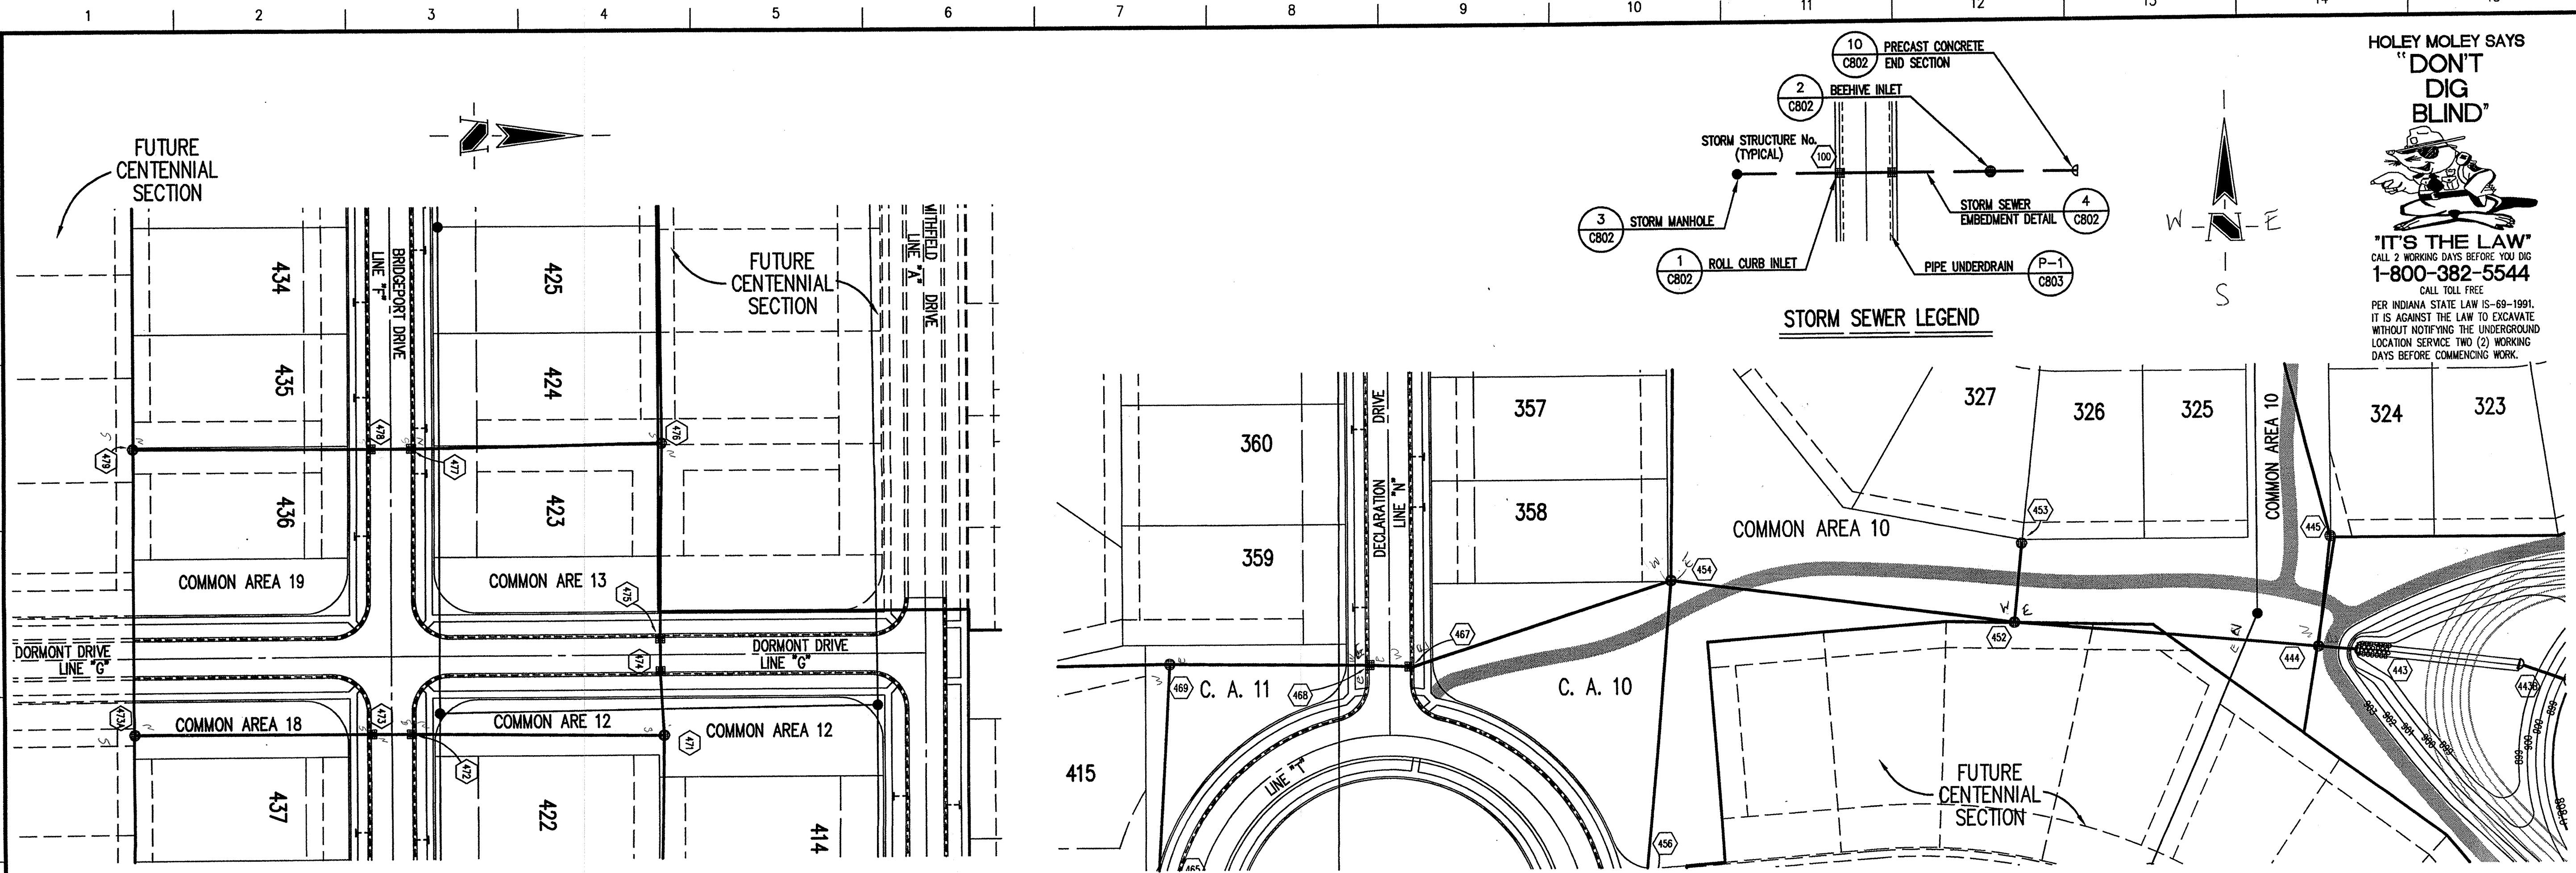SCALE: 1"=50'



GENERAL NOTES

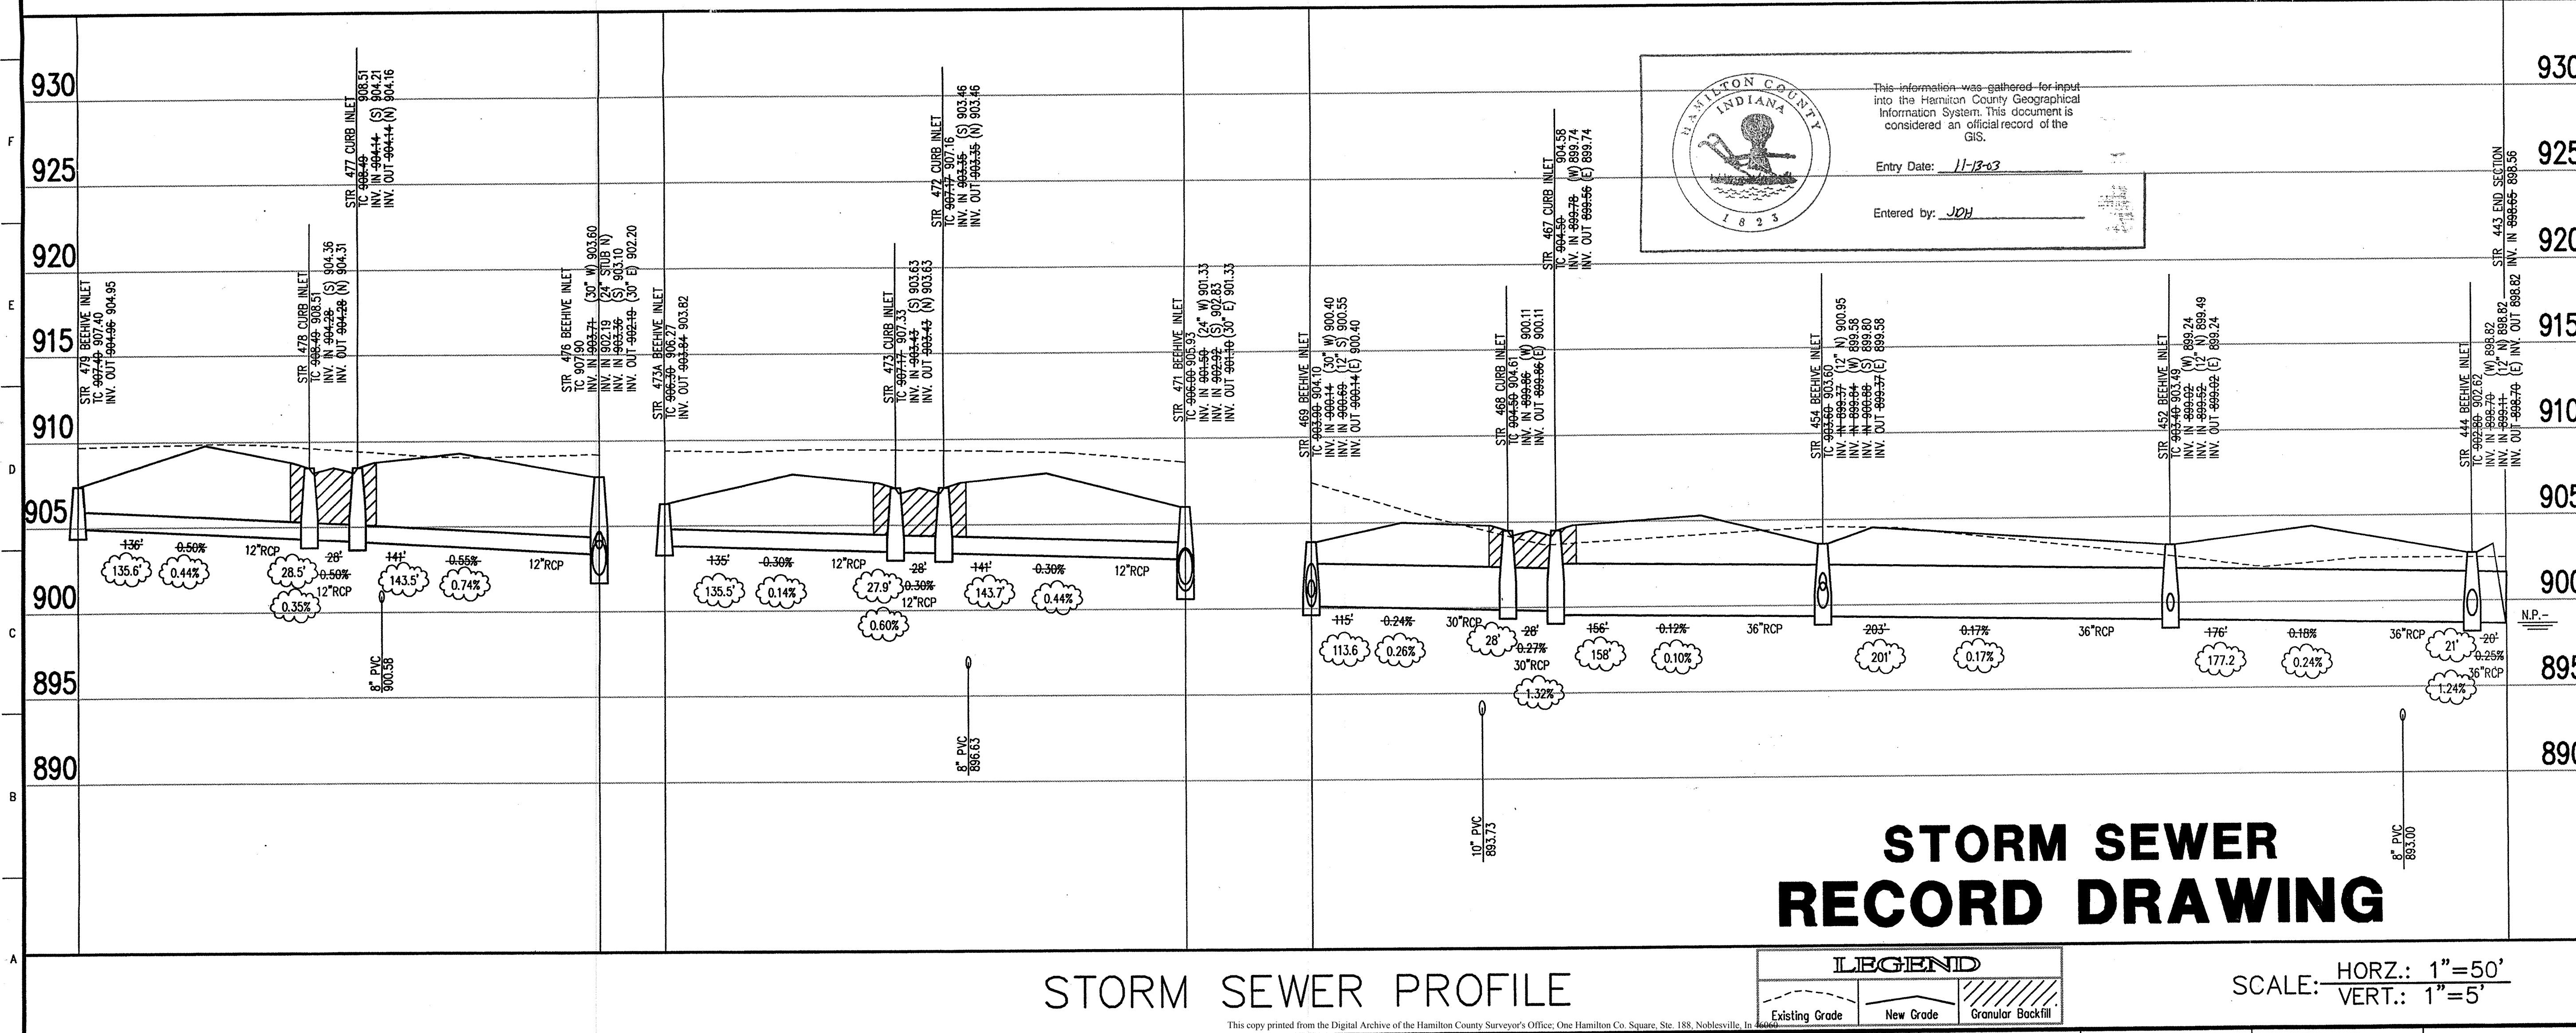- TEMPORARY TRAFFIC CONTROL DURING CONSTRUCTION TO CONFORM TO APPLICABLE LOCAL AND STATE STANDARDS.
- ALL CONSTRUCTION ACTIVITY ON THIS SITE TO BE PERFORMED IN COMPLIANCE WITH APPLICABLE O.S.H.A. STANDARDS FOR WORKER SAFETY.
- IT SHALL BE THE CONTRACTORS RESPONSIBILITY TO FIELD VERIFY ALL UTILITY LOCATIONS BEFORE CONSTRUCTION BEGINS.
- CONTRACTORS SHALL MINIMIZE DAMAGE TO EXISTING TREES.



"IT'S THE LAW"
CALL 2 WORKING DAYS BEFORE YOU DIG
1-800-382-5544

CALL TO 911
PER INDIANA STATE LAW IS-69-1991.
IT IS AGAINST THE LAW TO EXCAVATE
WITHOUT NOTIFYING THE UNDERGROUND
LOCATION SERVICE TWO (2) WORKING
DAYS BEFORE COMMENCING WORK.

BENCHMARK

BM - U.S.G.S. 93 RHP (1951)
BRASS DISK IN CONCRETE POST S.W. CORNER OF 146TH AND
DITCH ROAD, ELEV. = 903.373

TBM #9
R.R. SPIKE 1.3' UP NORTH SIDE OF MAPLE± S.E. CORNER SITE,
ELEV. = 908.39

Revisions
MG 08/11/00 REVISIONS PER LOT LAYOUT REQUESTED BY CLIENT.
2. PRC 10/31/00 REMOVED REAR YARD SSDS & ADDED SSDS TEES AT FRONT OF LOTS.
3. DRP 03/23/01 STORM SEWER RECORD DRAWING.

CERTIFICATION FOR "RECORD DRAWING"

NOTE:
Record drawing certification for top of casting, invert elevations, and lengths of pipe only. Slope percentage
represents a calculated figure and is for general
information only.



CERTIFIED BY
J. Cort Crosby
No. 920350
STATE OF
INDIANA
PROFESSIONAL ENGINEER
3/31/01
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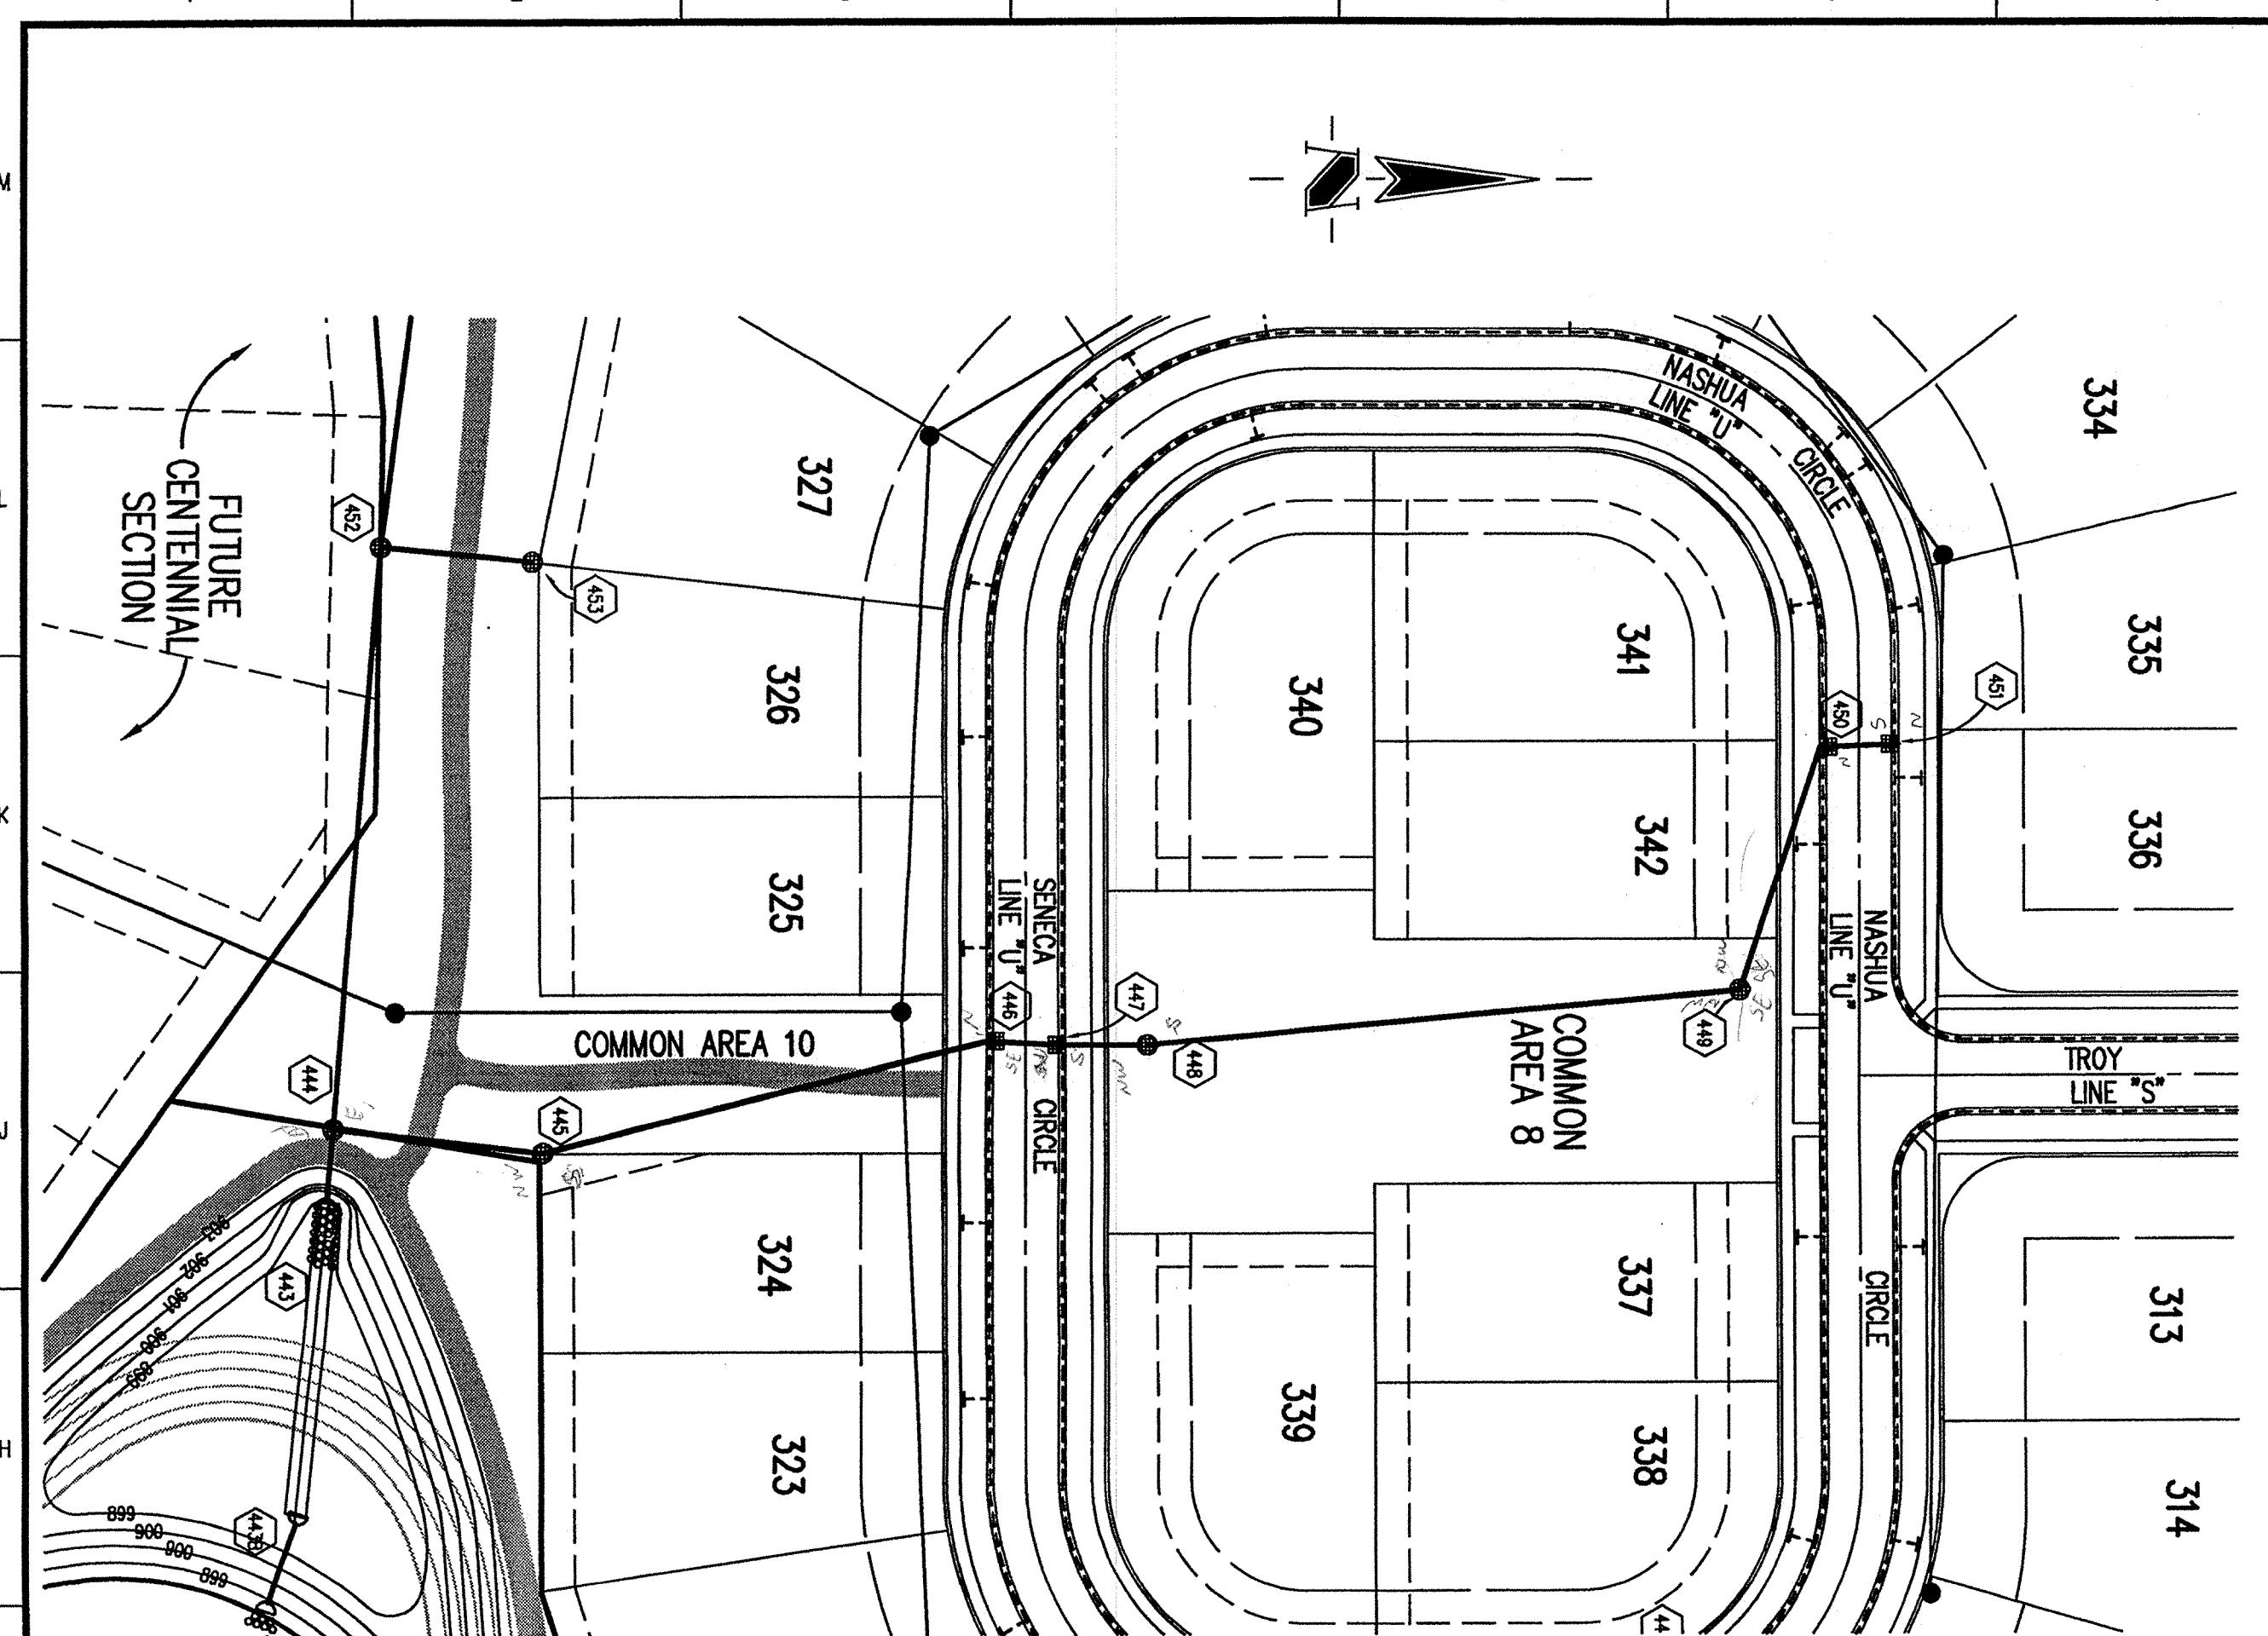
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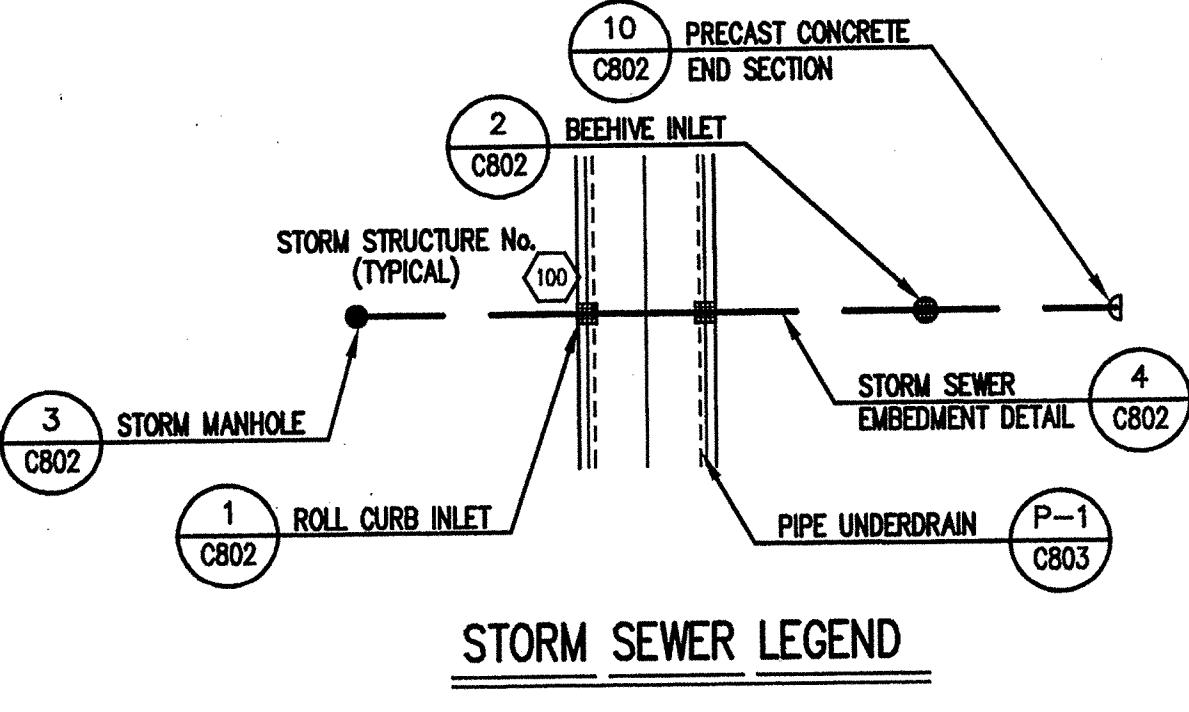
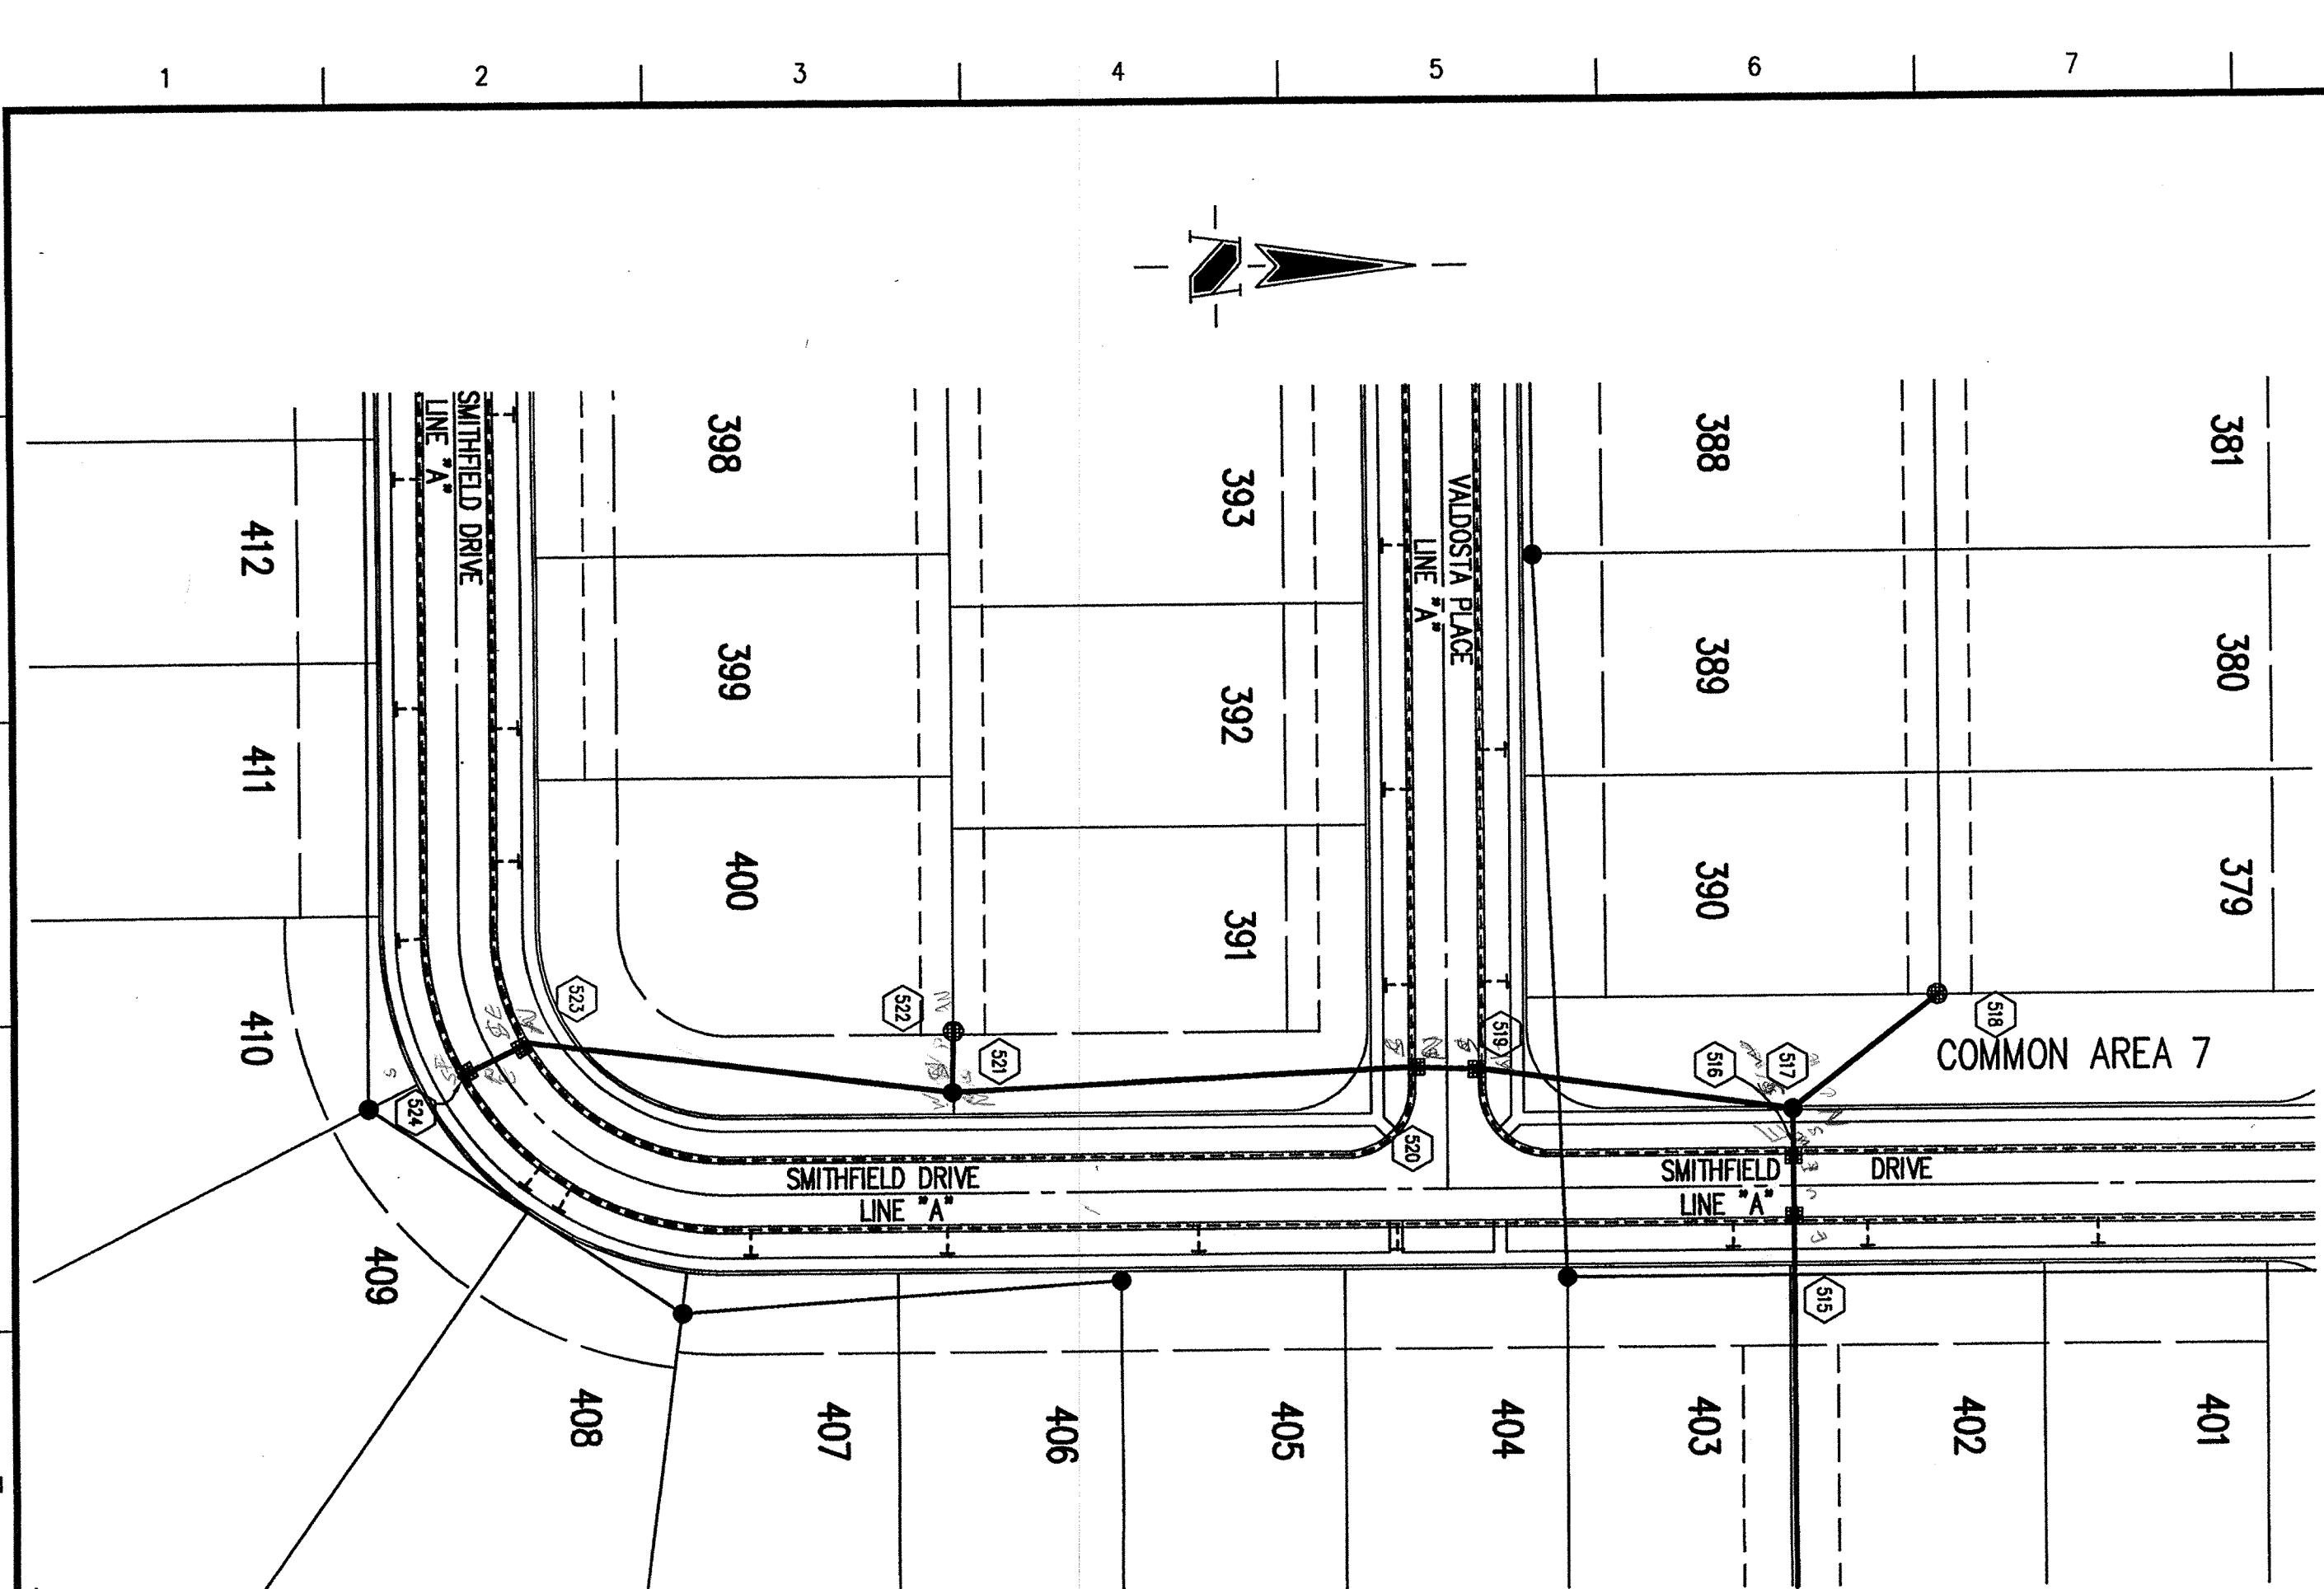
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CENTENNIAL SECTION 3
WESTFIELD, INDIANA
APR 5 2001
OFFICE OF HAMILTON COUNTY SURVEYOR

STORM SEWER PLAN


SCALE: 1"=50'





STORM SEWER PLAN

SCALE: 1"=50'

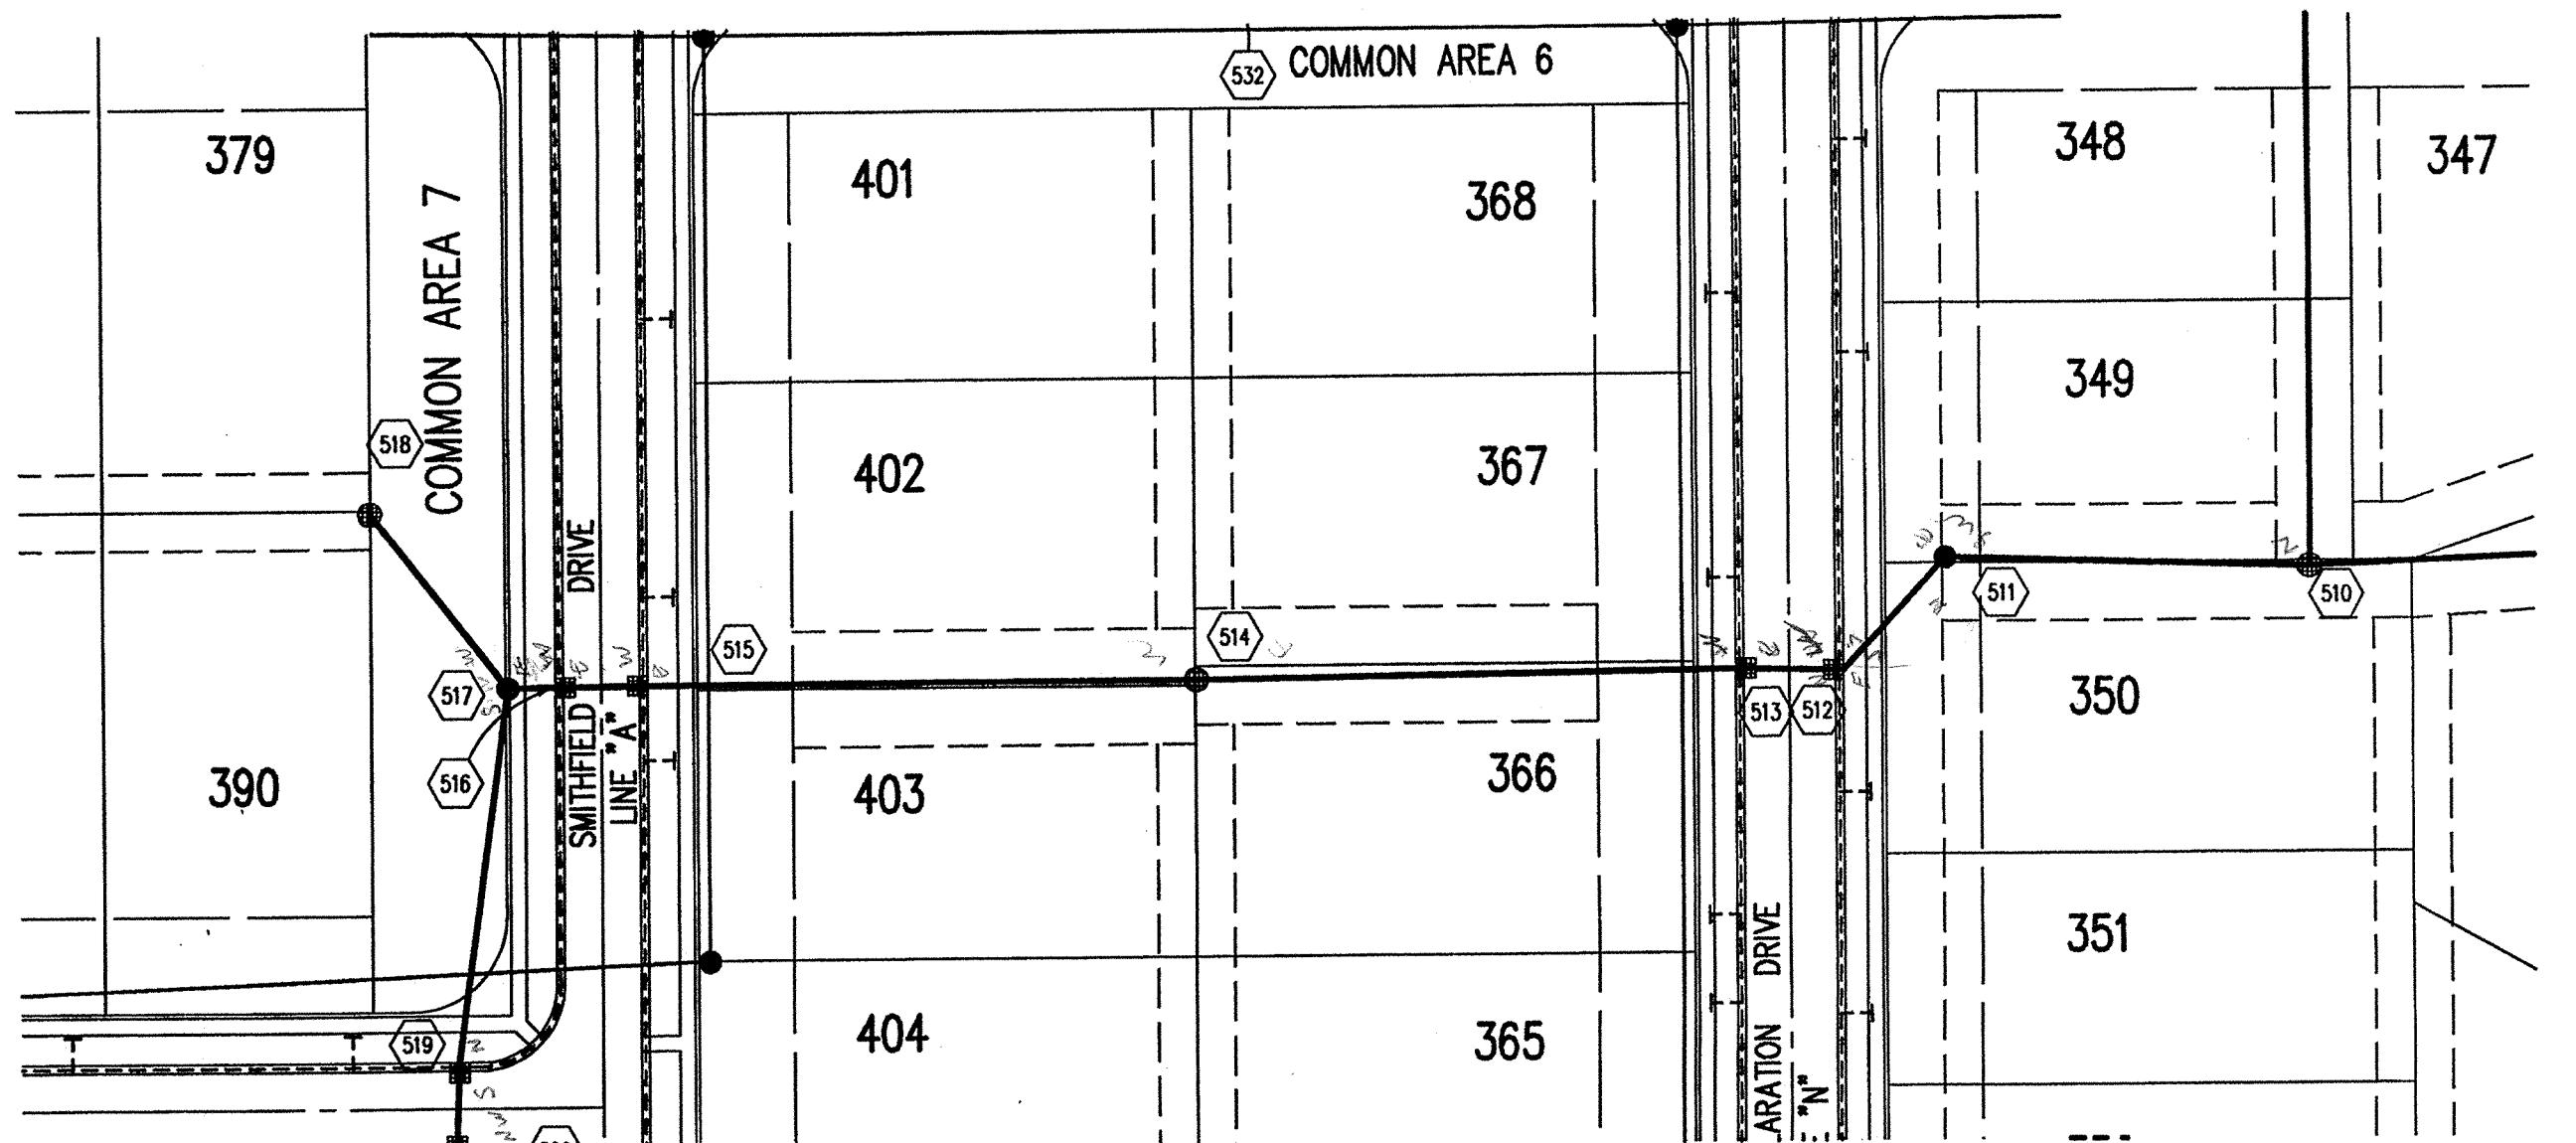

BENCHMARK



BM - U.S.G.S. 93 RHP (1951)
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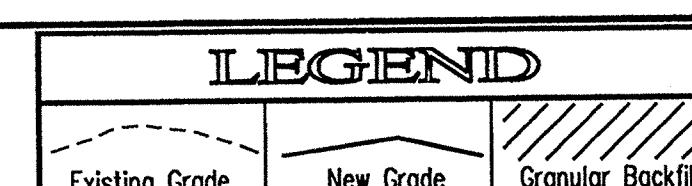
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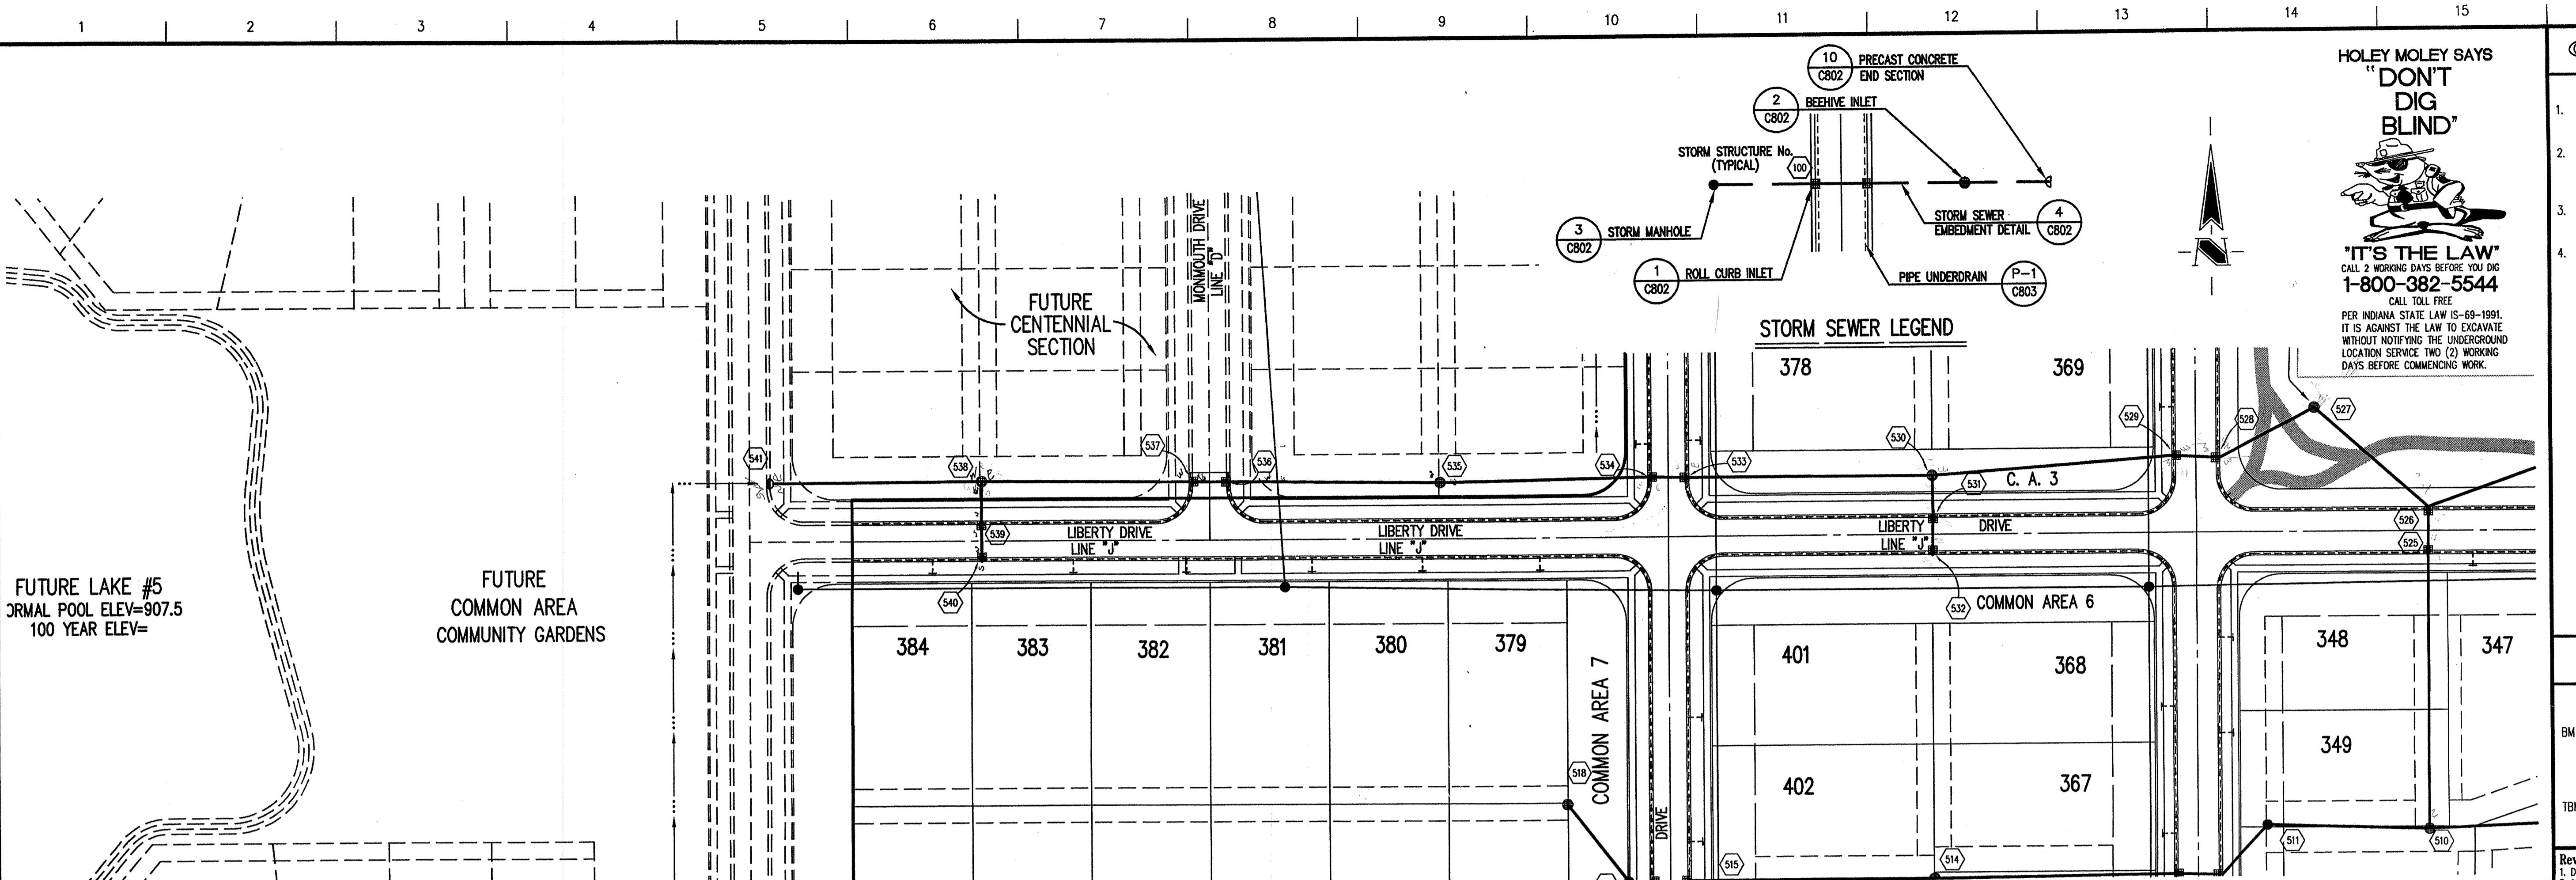
STORM SEWER RECORD DRAWING

STORM SEWER PROFILE




SCALE: HORZ.: 1"=50'
VERT.: 1"=5'

Date 04/12/00	Project No. 753.003	Drawn DRP	Approv.
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STORM SEWER PLAN

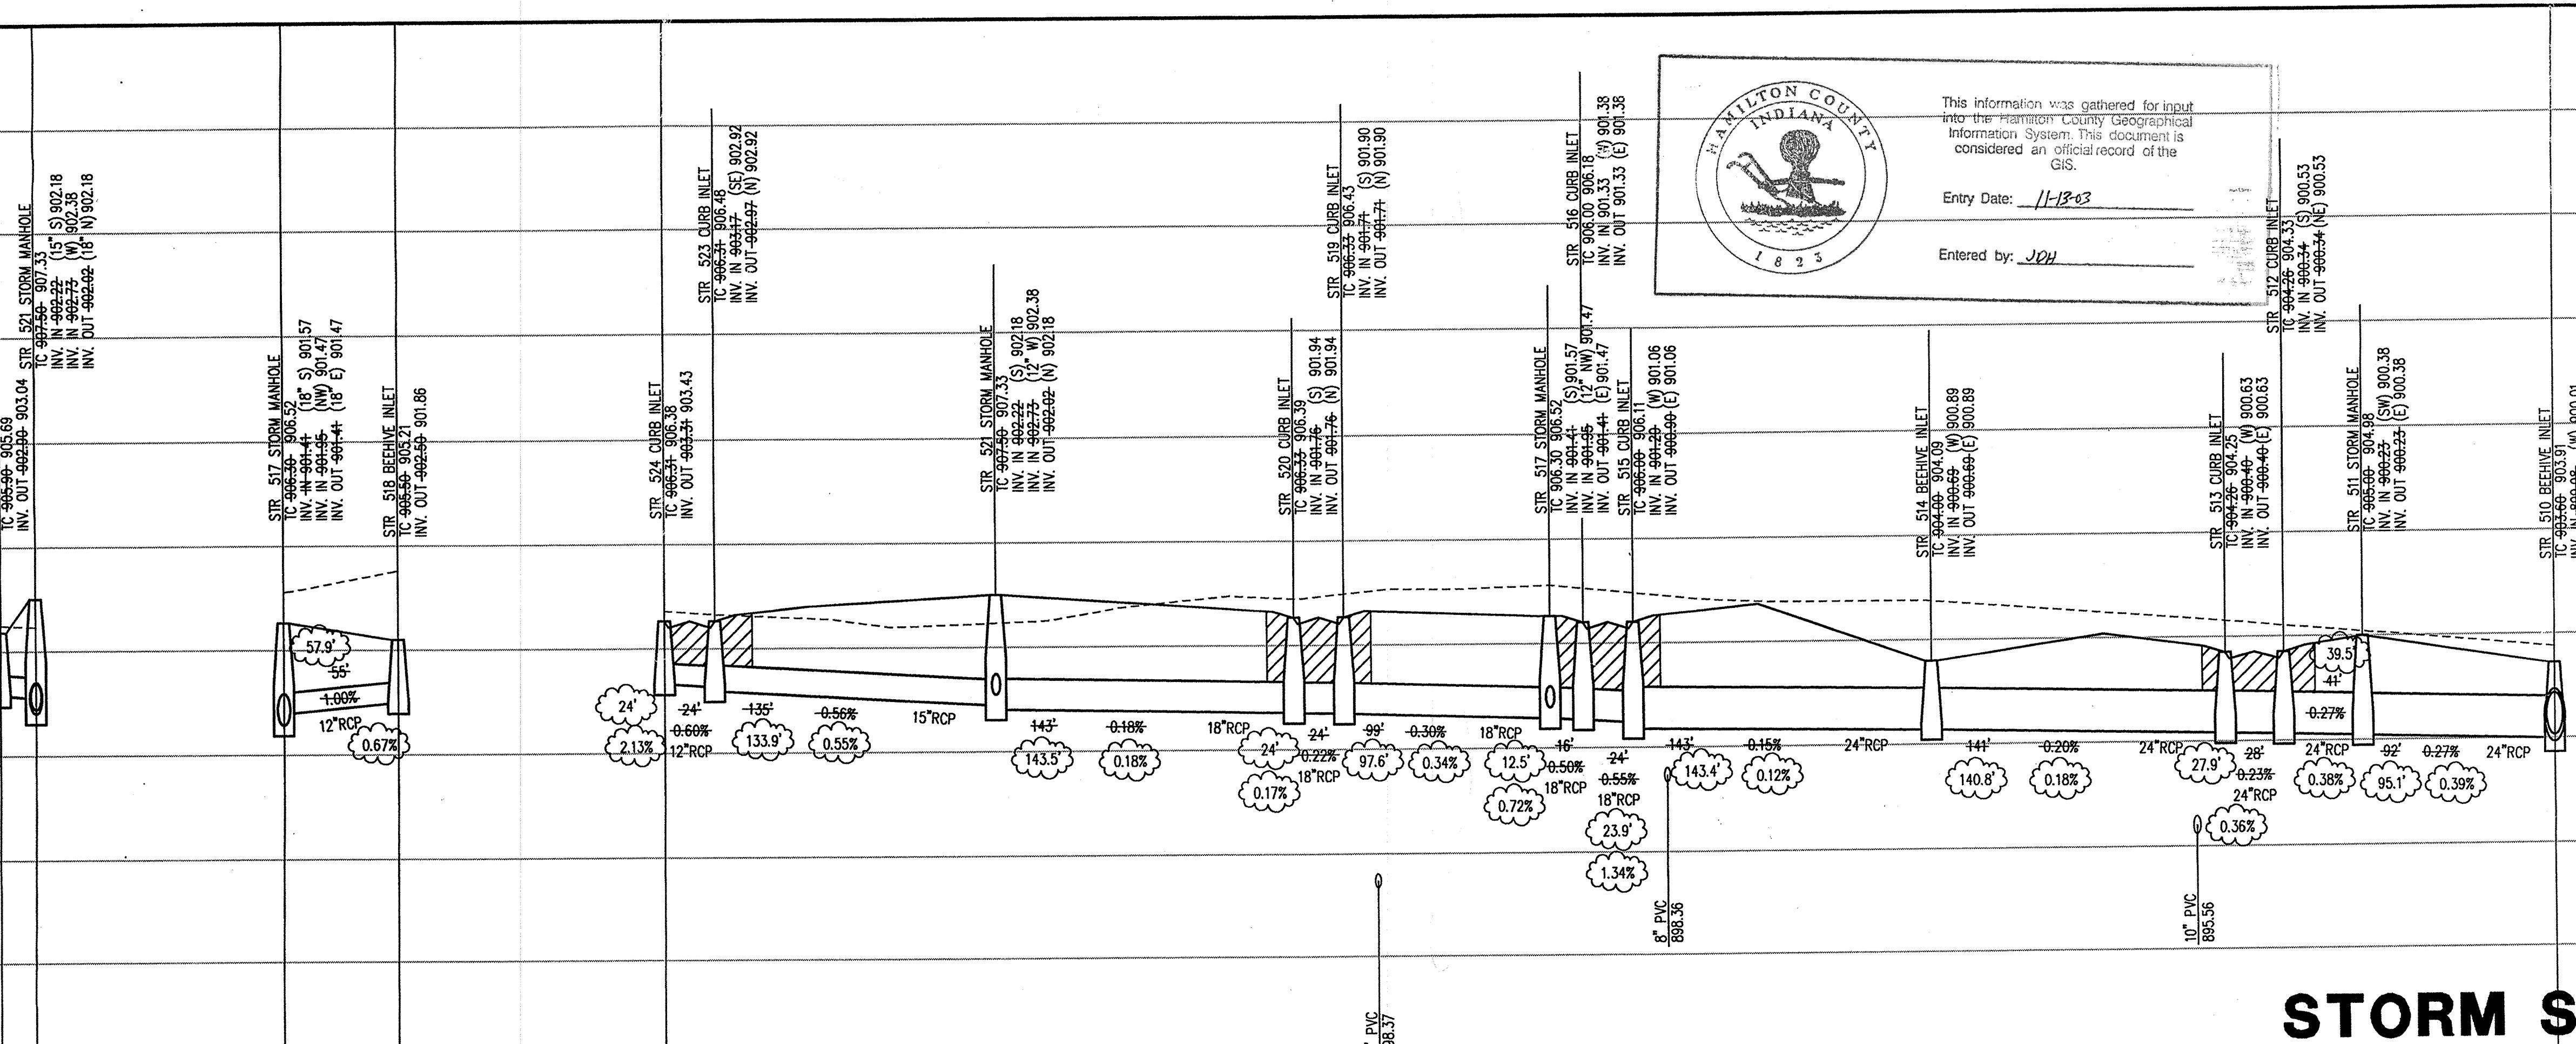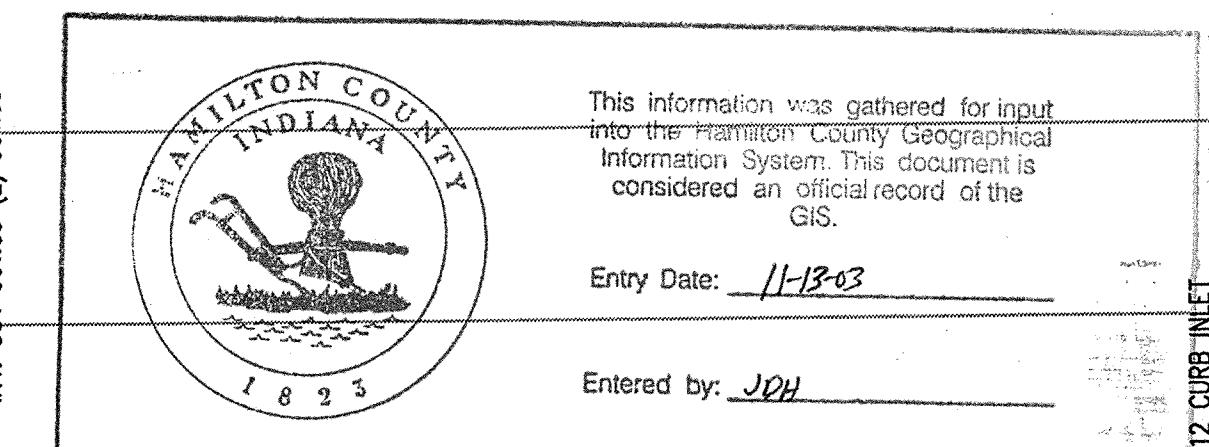SCALE: 1"=50'




STORM SEWER RECORD DRAWING

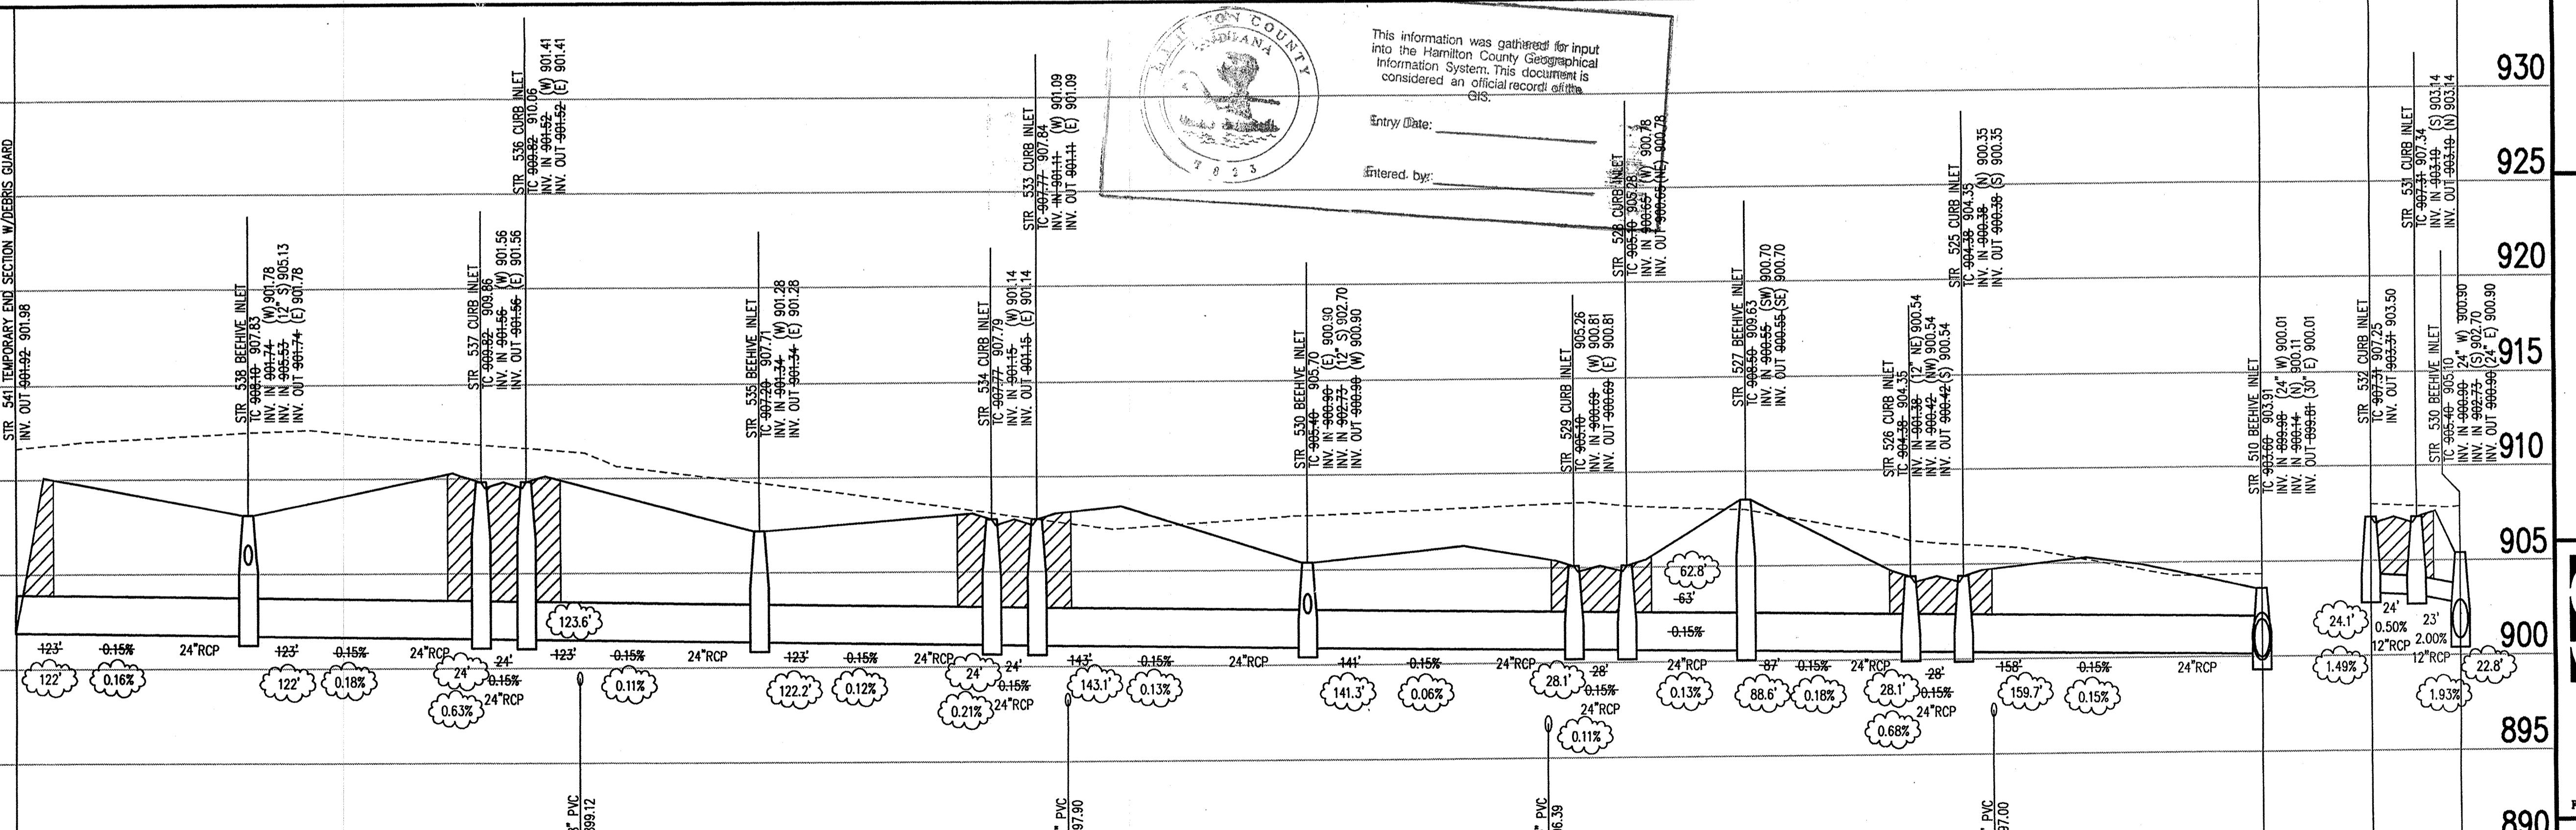STORM SEWER PROFILE

A rectangular legend box with a black border. The word "LEGEND" is printed in large, bold, black capital letters at the top. Below it are three entries: "Existing Grade" with a dashed line, "New Grade" with a solid line, and "Granular Backfill" with diagonal hatching.

SCALE: HORZ.: 1"=50'
VERT.: 1"=5'

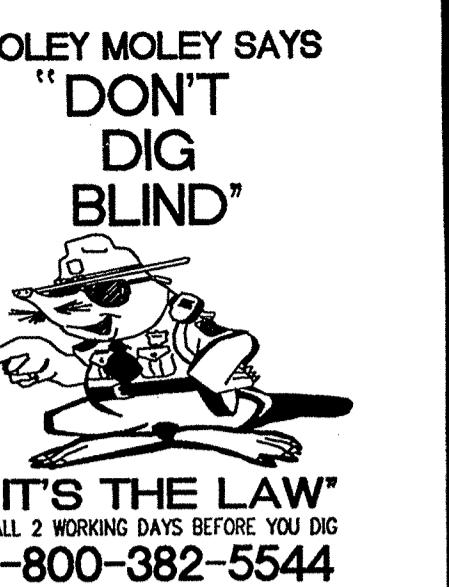

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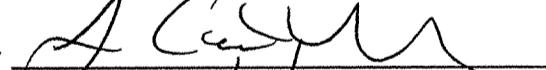
- Rewards**

 1. DRP 07/03/00 ADDED DEBRIS GUARD NOTE AT STR. 541.
 2. MG 08/11/00 REVISIONS PER LOT LAYOUT REQUESTED BY CLIENT.
 3. PRC 10/31/00 REMOVED REAR YARD SSDS & ADDED SSDS TEES AT FRONT OF LOTS.
 4. DRP 03/23/01 STORM SEWER RECORD DRAWING.

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WESTFIELD, INDIANA
VICE OF HAMILTON COUNTY


STORM SEWER PLAN

Date	Project No.	Drawn	Approv.
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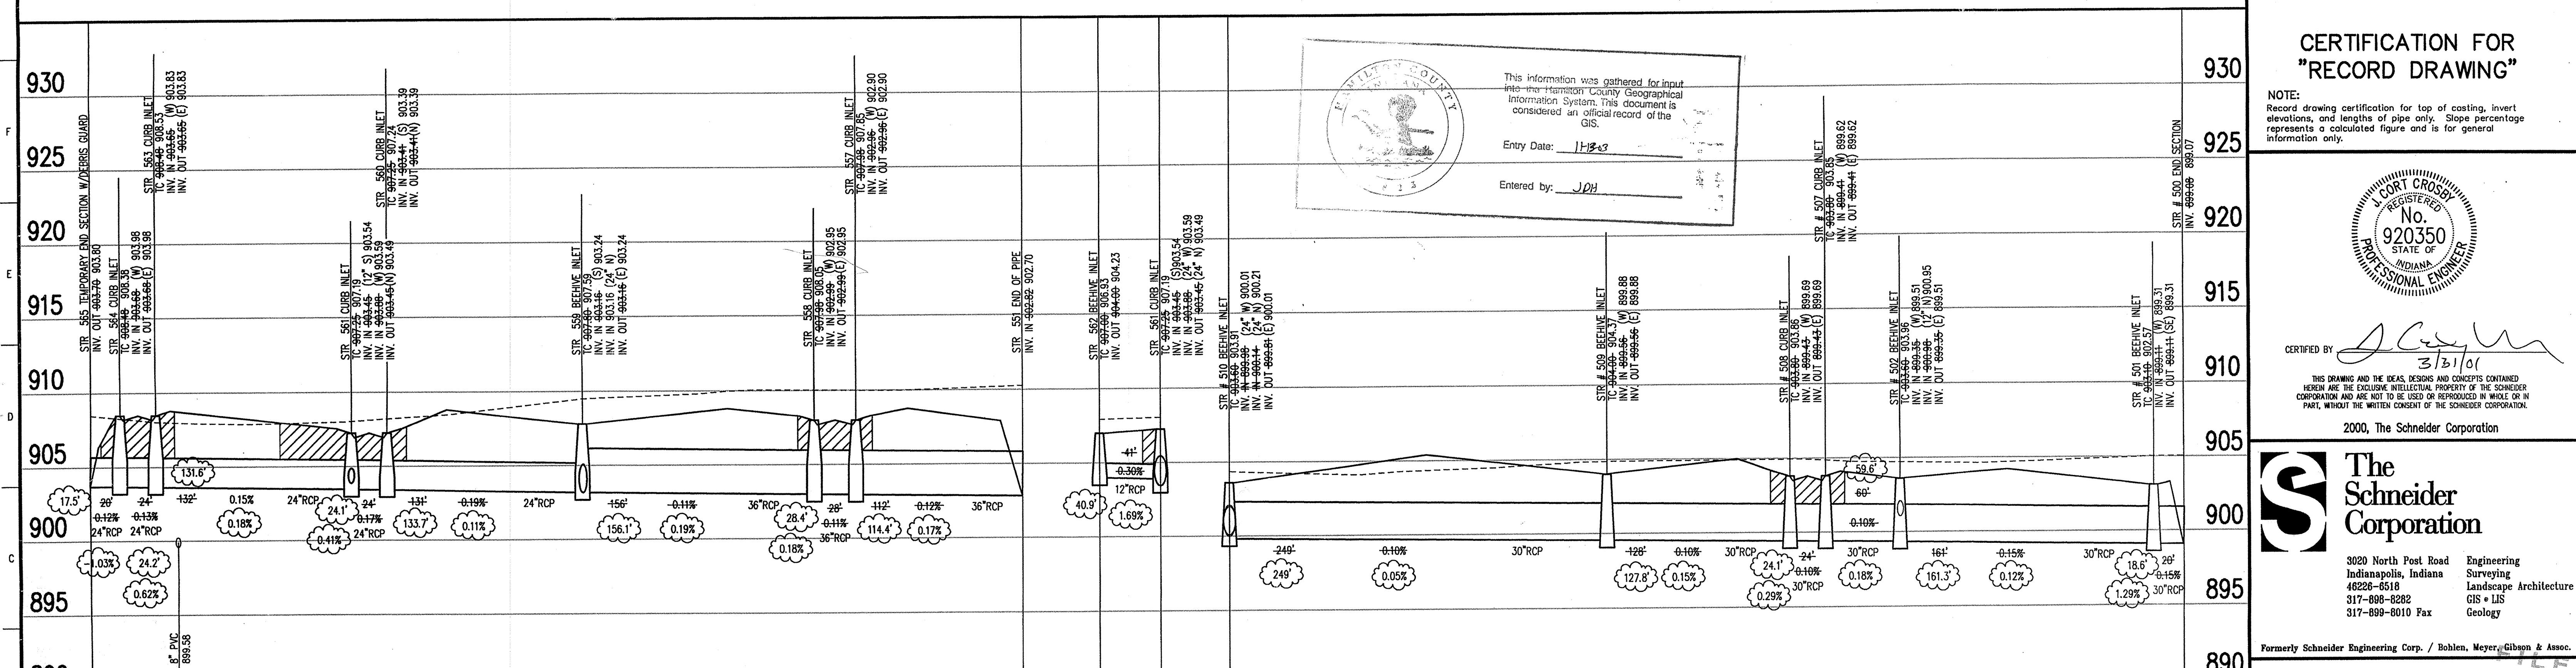
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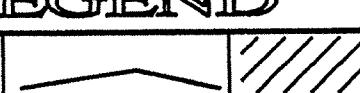
STORM SEWER PLAN

SCALE: 1"=50'



STORM SEWER RECORD DRAWING

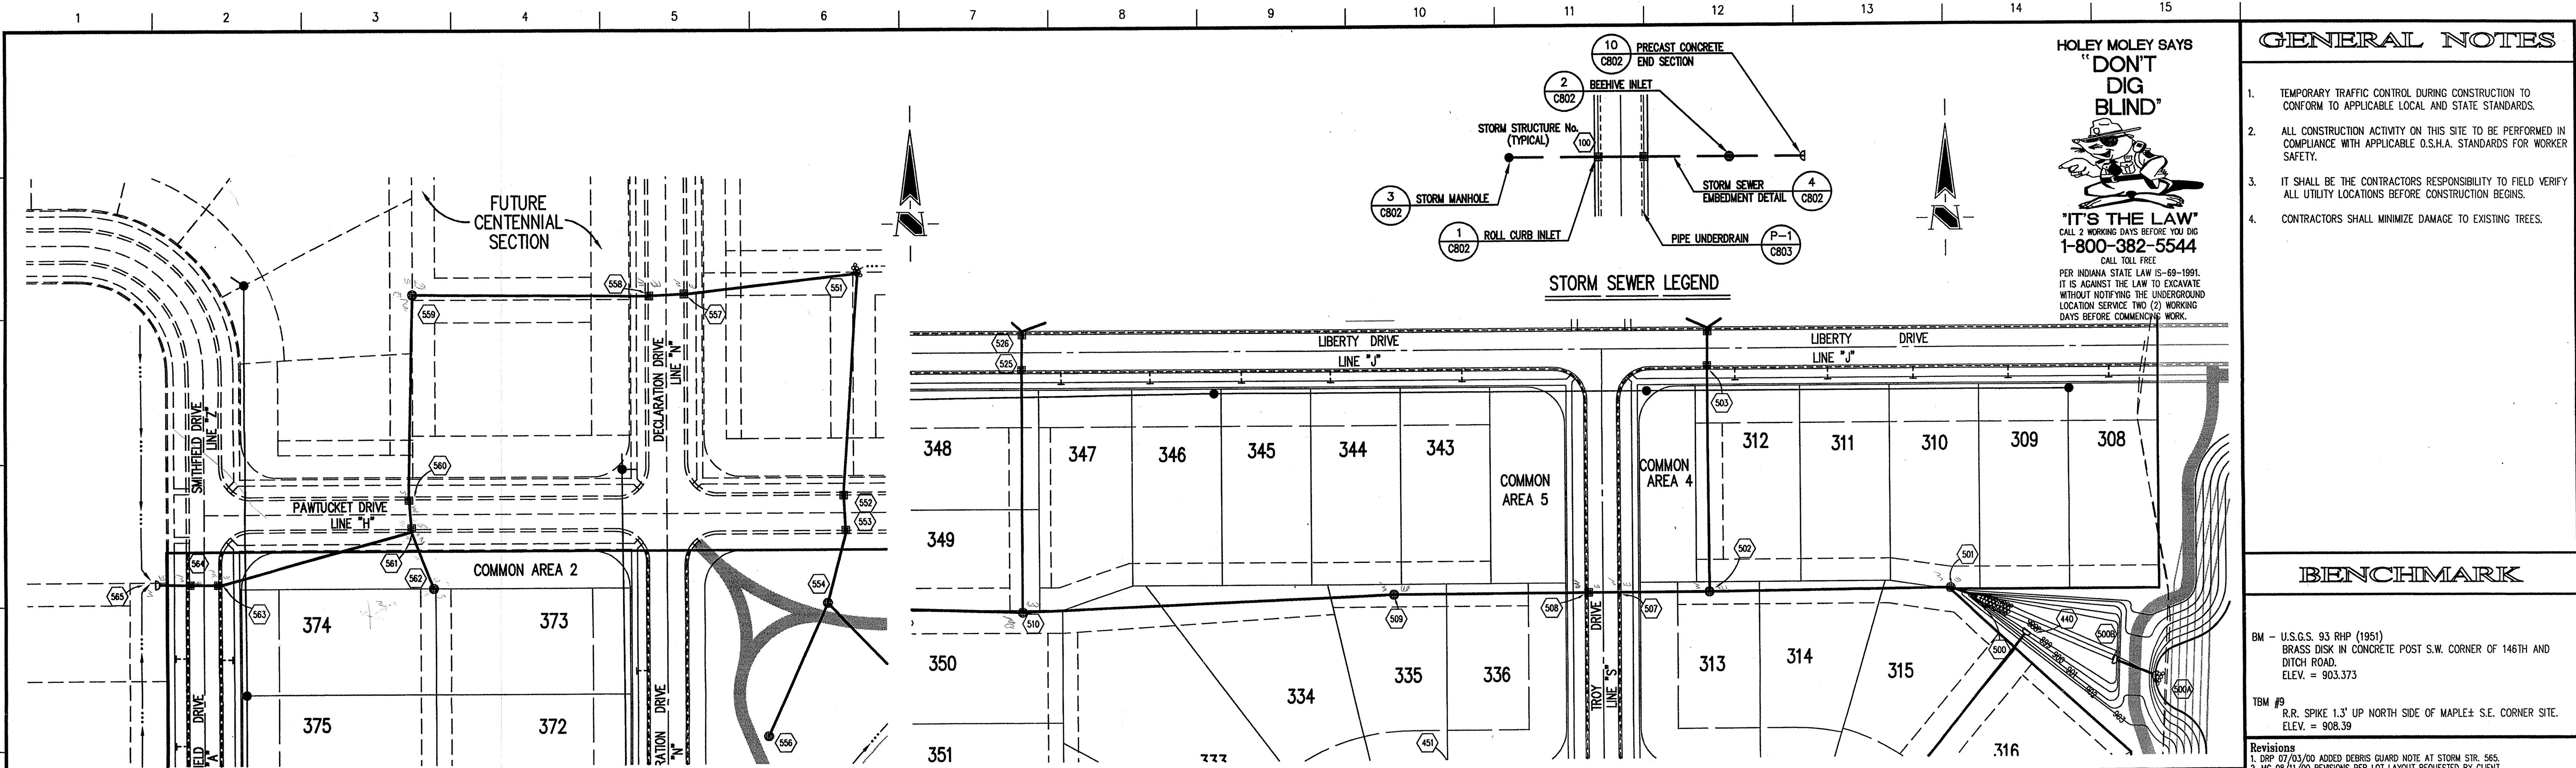LEGEND



SCALE: HORIZ.: 1"=50'
VERT.: 1"=5'

Date 04/12/00 Project No. 753.003 Drawn DRP Approved Sheet No. C607

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