


**Drain:** MERRIMAC **Drain #:** 278  
**Improvement/Arm:** SECTION 6  
**Operator:** JDT **Date:** 2-11-04  
**Drain Classification:** Urban/Rural **Year Installed:** 2001

### GIS Drain Input Checklist

- Pull Source Documents for Scanning JDT
- Digitize & Attribute Tile Drains \_\_\_\_\_
- Digitize & Attribute Storm Drains \_\_\_\_\_
- Digitize & Attribute SSD \_\_\_\_\_
- Digitize & Attribute Open Ditch \_\_\_\_\_
- Stamp Plans \_\_\_\_\_
- Sum drain lengths & Validate \_\_\_\_\_
- Enter Improvements into Posse JDT
- Enter Drain Age into Posse JDT 3-1
- Sum drain length for Watershed in Posse JDT 3-1
- Check Database entries for errors \_\_\_\_\_

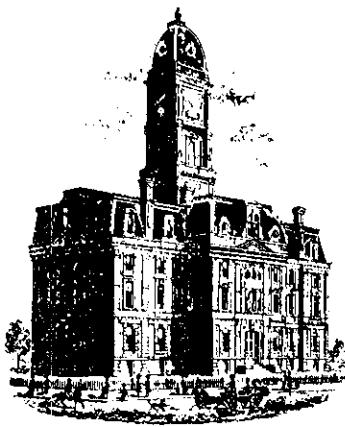

Kenton C. Ward, Surveyor

Phone (317) 776-8495

Fax (317) 776-9628

Suite 188

One Hamilton County Square

Noblesville, Indiana 46060-2230

December 19, 2001

TO: Hamilton County Drainage Board

RE: Merrimac Drain, Section 6 Arm

Attached is a petition, non-enforcement request, plans, calculations, quantity summary and assessment roll for the Section 6 Arm, Merrimac Drain. I have reviewed the submittals and petition and have found each to be in proper form.

I have made a personal inspection of the land described in the petition. Upon doing so, I believe that the drain is practicable; will improve the public health; benefit a public highway and be of public utility; and that the cost, damages and expenses of the proposed drain will probably be less than the benefits accruing to the owners of land likely to be benefited. The drain will consist of the following:

6" SSD	4,688 ft	15" RCP	416 ft
12" SSD	731 ft	18" RCP	197 ft

The total length of the drain will be 6,032 ft.

The subsurface drains (SSD) to be part of the regulated drain are those located under the curbs. Only the main SSD lines which are located with the right of way are to be maintained as regulated drain. Laterals for individual lots will not be considered part of the regulated drain.


I have reviewed the plans and believe the drain will benefit each lot equally. Therefore, I recommend each lot be assessed equally. I also believe that no damages will result to landowners by the construction of this drain. I recommend a maintenance assessment of \$30.00 per lot, \$5.00 per acre for roadways, with a \$30.00 minimum. With this assessment the total annual assessment for this drain/ this section will be \$1,362.16.

Parcels assessed for this drain may be assessed for the Osborn-Collins or Williams Creek Drain at sometime in the future.

I believe this proposed drain meets the requirements for Urban Drain Classification as set out in IC 36-9-27-67 to 69. Therefore, this drain shall be designated as an Urban Drain.

I recommend that upon approval of the above proposed drain that the Board also approve the attached non-enforcement request. This request is for the reduction of the regulated drain easement to those easement widths as shown on the secondary plat for Merrimac Section 6 as recorded in the office of the Hamilton County Recorder.

I recommend the Board set a hearing for this proposed drain for Jan 28, 2002.

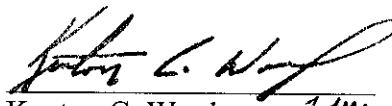

Kenton C. Ward  
Hamilton County Surveyor

KCW/mkh



# Fidelity and Deposit Company of Maryland

Home Office: P.O. Box 1227, Baltimore, MD 21203-1227

Bond No. 08595859



## SUBDIVISION/SITE IMPROVEMENT BOND

Merrimac Corporation

KNOW ALL MEN BY THESE PRESENTS, that we, \_\_\_\_\_  
 \_\_\_\_\_, as Principal, and Fidelity and Deposit Company of Maryland, of  
 Baltimore, Maryland, as Surety, are held and firmly bound unto the Hamilton County  
Commissioners,  
 as Obligee, in the sum of Sevety-four thousand & 00/100-----  
 (\$ 74,000) Dollars for the payment of which, well and truly to be made, we  
 jointly and severally bind ourselves, our executors, administrators, successors, and assigns, firmly by these  
 presents.

WHEREAS, the Principal has agreed to perform the various improvements as detailed by either the  
 plan(s)/specification(s)/agreement, prepared by Hamilton County Commissioners  
 (Storm sewers & sub-surface drains),  
 to the subdivision known as Merrimac Section 6.

NOW THEREFORE, THE CONDITION OF THIS OBLIGATION IS SUCH, that, if said Principal shall  
 perform and complete said improvements to said development in accordance with either the  
 plan (s)/specification(s)/agreement, then this obligation shall be void, otherwise to be and remain in full  
 force and effect.

THIS BOND WILL TERMINATE upon written acceptance of the improvements by the Obligee to the  
 Principal and/or Surety.

Sealed with our seals and dated this 6th day of November, 2001.

  
Merrimac Corporation

By: \_\_\_\_\_  
 Principal

FIDELITY AND DEPOSIT COMPANY OF MARYLAND

  
 By: Brenda K. Russell  
Brenda K. Russell, Attorney-in-fact

CON76100Z0501F



## Fidelity and Deposit Company of Maryland

Home Office: P.O. Box 1227, Baltimore, MD 21203-1227

Bond No. 08595857



## SUBDIVISION/SITE IMPROVEMENT BOND

Merrimac Corporation

**KNOW ALL MEN BY THESE PRESENTS,** that we,

, as Principal, and Fidelity and Deposit Company of Maryland, of

Baltimore, Maryland, as Surety, are held and firmly bound unto the Hamilton County  
Commissioners

as Obligee, in the sum of Thirty thousand and 00/100

(\$ 30,000) Dollars for the payment of which, well and truly to be made, we jointly and severally bind ourselves, our executors, administrators, successors, and assigns, firmly by these presents.

WHEREAS, the Principal has agreed to perform the various improvements as detailed by either the plan(s)/specification(s)/agreement, prepared by Hamilton County Commissioners.  
(Erosion control)

to the subdivision known as Merrimac Section 6.

NOW THEREFORE, THE CONDITION OF THIS OBLIGATION IS SUCH, that, if said Principal shall perform and complete said improvements to said development in accordance with either the plan (s)/specification(s)/agreement, then this obligation shall be void, otherwise to be and remain in full force and effect.

**THIS BOND WILL TERMINATE** upon written acceptance of the improvements by the Obligee to the Principal and/or Surety.

6th November 2001

Sealed with our seals and dated this \_\_\_\_\_ day of November, 2001.

  
Alexander H. Smith  
Merrimac Corporation

Principal

FIDELITY AND DEPOSIT COMPANY OF MARYLAND

By: Brenda K. Russell  
Brenda K. Russell

**Attorney-in-fact**

CON76100ZZ0501f

**Power of Attorney**  
**FIDELITY AND DEPOSIT COMPANY OF MARYLAND**

HOME OFFICE: P.O. BOX 1227, BALTIMORE, MD 21203-1227

Know ALL MEN BY THESE PRESENTS: That the FIDELITY AND DEPOSIT COMPANY OF MARYLAND, a corporation of the State of Maryland, by W. B. WALBRECHER, Vice-President, and T. E. SMITH, Assistant Secretary, in pursuance of authority granted by Article VI, Section 2. of the By-Laws of said Company, which are set forth on the reverse side hereof and are hereby certified to be in full force and effect on the date hereof, does hereby nominate, constitute and appoint John S. Flynn, Thomas A. Flynn, Brenda Raymer, Lesley G. Martin, Gerald F. O'Connor, Brenda K. Russell, Deborah Vanderveen and Diana L. Badre, all of Indianapolis, Indiana, EACH its true and lawful agent and Attorney-in-Fact, to make, execute, seal and deliver, for, and on its behalf as Surety, and as its act and deed: **any and all bonds and undertakings** and the execution of such bonds or undertakings in pursuance of these presents, shall be as binding upon said Company, as fully and amply, to all intents and purposes, as if they had been duly executed and acknowledged by the regularly elected officers of the Company at its office in Baltimore, Md., in their own proper persons. This power of attorney revokes that issued on behalf of Larry K. Chambers, et al, dated October 3, 1994.

The said Assistant Secretary does hereby certify that the extract set forth on the reverse side hereof is a true copy of Article VI, Section 2, of the By-Laws of said Company, and is now in force.

IN WITNESS WHEREOF, the said Vice-President and Assistant Secretary have hereunto subscribed their names and affixed the Corporate Seal of the said FIDELITY AND DEPOSIT COMPANY OF MARYLAND, this 16th day of July, A.D. 1997.

ATTEST:

**FIDELITY AND DEPOSIT COMPANY OF MARYLAND**



T. E. Smith

Assistant Secretary

State of Maryland  
County of Baltimore } ss:

By: W. B. Walbrecher  
Vice-President

On this 16th day of July, A.D. 1997, before the subscriber, a Notary Public of the State of Maryland, duly commissioned and qualified, came W. B. WALBRECHER, Vice-President and T. E. SMITH, Assistant Secretary of the FIDELITY AND DEPOSIT COMPANY OF MARYLAND, to me personally known to be the individuals and officers described in and who executed the preceding instrument, and they each acknowledged the execution of the same, and being by me duly sworn, severally and each for himself deposeth and saith, that they are the said officers of the Company aforesaid, and that the seal affixed to the preceding instrument is the Corporate Seal of said Company, and that the said Corporate Seal and their signatures as such officers were duly affixed and subscribed to the said instrument by the authority and direction of the said Corporation.

IN TESTIMONY WHEREOF, I have hereunto set my hand and affixed my Official Seal the day and year first above written.



Carol J. Fader  
Notary Public  
My Commission Expires: August 1, 2000

**CERTIFICATE**

I, the undersigned, Assistant Secretary of the FIDELITY AND DEPOSIT COMPANY OF MARYLAND, do hereby certify that the original Power of Attorney of which the foregoing is a full, true and correct copy, is in full force and effect on the date of this certificate; and I do further certify that the Vice-President who executed the said Power of Attorney was one of the additional Vice-Presidents specially authorized by the Board of Directors to appoint any Attorney-in-Fact as provided in Article VI, Section 2, of the By-Laws of the FIDELITY AND DEPOSIT COMPANY OF MARYLAND.

This Power of Attorney and Certificate may be signed by facsimile under and by authority of the following resolution of the Board of Directors of the FIDELITY AND DEPOSIT COMPANY OF MARYLAND at a meeting duly called and held on the 10th day of May, 1990.

RESOLVED: "That the facsimile or mechanically reproduced seal of the company and facsimile or mechanically reproduced signature of any Vice-President, Secretary, or Assistant Secretary of the Company, whether made heretofore or hereafter, wherever appearing upon a certified copy of any power of attorney issued by the Company, shall be valid and binding upon the Company with the same force and effect as though manually affixed."

IN TESTIMONY WHEREOF, I have hereunto subscribed my name and affixed the corporate seal of the said Company, this

6th day of November, 2001.

S. D. Matis

Assistant Secretary

L1428-044-0145

**EXTRACT FROM BY-LAWS OF FIDELITY AND DEPOSIT COMPANY OF MARYLAND**

"Article VI, Section 2. The Chairman of the Board, or the President, or any Executive Vice-President, or any of the Senior Vice-Presidents or Vice-Presidents specially authorized so to do by the Board of Directors or by the Executive Committee, shall have power, by and with the concurrence of the Secretary or any one of the Assistant Secretaries, to appoint Resident Vice-Presidents, Assistant Vice-Presidents and Attorneys-in-Fact as the business of the Company may require, or to authorize any person or persons to execute on behalf of the Company any bonds, undertakings, recognizances, stipulations, policies, contracts, agreements, deeds, and releases and assignments of judgements, decrees, mortgages and instruments in the nature of mortgages, . . . and to affix the seal of the Company thereto."



Kenton C. Ward, CFM  
Surveyor of Hamilton County  
Phone (317) 776-8495  
Fax (317) 776-9628

Suite 188  
One Hamilton County Square  
Noblesville, Indiana 46060-2230

To: Hamilton County Drainage Board

August 21, 2009

**Re: Williams Creek: Merrimac Section 6**

Attached are as-builts, certificate of completion & compliance, and other information for Merrimac Section 6. An inspection of the drainage facilities for this section has been made and the facilities were found to be complete and acceptable.

During construction, changes were made to the drain, which will alter the plans submitted with my report for this drain-dated Merrimac Section 6. The report was approved by the Board at the hearing held January 28, 2002. (See Drainage Board Minutes Book 6, Pages 248-250) The changes are as follows:

Structure:	Length:	Size	Material:	Up Invert:	Dn_Invert	Grade:
663-662	135	12	RCP	896.34	895.99	0.26
662-661	19	12	RCP	895.86	895.75	0.56
661-660	28	15	RCP	895.73	895.53	0.7
660-617	162	15	RCP	895.53	894.43	0.68
657-656	45	12	RCP	896.64	896.3	0.75
656-655	34	15	RCP	896.3	896.12	0.52
655-615	164	18	RCP	896.12	894.6	0.92
665-664	14	18	RCP	897.86	898.02	1.07
667-666	179	12	RCP	898.42	898.13	0.16
666-665	28	15	RCP	898.1	897.94	0.57
664-EX	280	18	RCP	897.99	897.26	0.26
653-652	156	12	RCP	898.08	896.47	1.03
652-651	28	12	RCP	896.41	896.13	0.99
651-650	21	12	RCP	896.15	895.98	0.79
650-610	141	12	RCP	895.95	892.96	2.11

**RCP Pipe Totals:**

12	724
15	252
18	458

**Total:** 1434

**RCP Pipe Totals:**

RICHLAND	2903
WARINER	1138
HALIFAX	731

**Total:** 4772

The length of the drain due to the changes described above is now **6,206 feet**.


The following sureties were guaranteed by Fidelity and Deposit Company and have expired.

**Bond-LC No:** CSB8102778  
**Insured For:** Storm Sewers  
**Amount:** \$115,086.00  
**Issue Date:** October 26, 1999

**Bond-LC No:** CSB8102779  
**Insured For:** Erosion Control  
**Amount:** \$28,340  
**Issue Date:** October 26, 1999

I recommend the Board approve the drain's construction as complete and acceptable.


Sincerely,

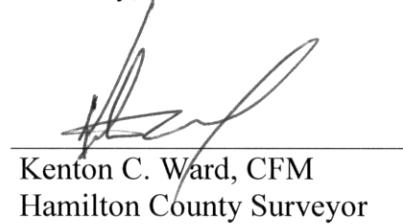

---

Kenton C. Ward, CFM  
Hamilton County Surveyor

KCW/slm

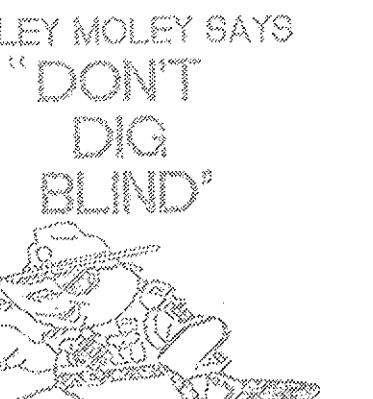


"IT'S THE LAW"  
GAL 2 WORKING DAYS BEFORE 100 FT  
1-800-382-5544

CALL TOLL FREE  
PER INDIANA STATE LAW IS 63-1891.  
IT IS AGAINST THE LAW TO EXCAVATE  
WITHOUT NOTIFYING THE UNDERGROUND  
LOCATION SERVICE TWO (2) WORKING  
DAYS BEFORE COMMENCING WORK.


This document contains input to the  
Hamilton County Surveyor's Office  
System GIS. This document is controlled by  
the Indiana State Law.

Entered by: [Signature]

Date: 8/2005

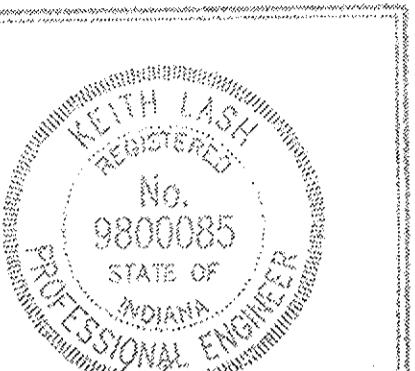

DATE: 8/15/01  
THE DRAWINGS AND THE IDEAS, DESIGNS AND  
INVENTIONS CONTAINED HEREIN ARE THE PROPERTY OF  
THE SCHNEIDER CORPORATION AND MAY NOT BE USED OR  
REPRODUCED, IN WHOLE OR IN PART, WITHOUT THE  
WRITTEN CONSENT OF THE SCHNEIDER  
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## MERRIMAC SECTION 6

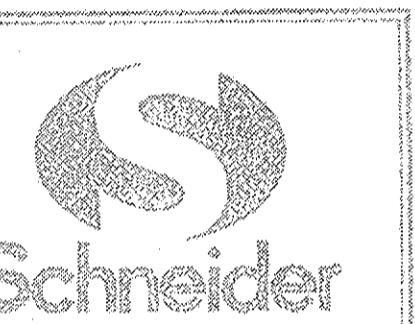WESTFIELD, INDIANA  
MERRIMAC CORP.  
CARMEL, INDIANA

ASSUMED NORTH  
SCALE: 1"=50'

## GENERAL NOTES

- ALL GRADES AT BOUNDARY SHALL MEET EXISTING GRADES.
- IT SHALL BE THE RESPONSIBILITY OF EACH CONTRACTOR TO VERIFY ALL EXISTING UTILITIES AND CONDITIONS PERTAINING TO HIS PHASE OF WORK. IT SHALL ALSO BE THE CONTRACTOR'S RESPONSIBILITY TO CONTACT THE OWNERS OF THE VARIOUS UTILITIES FOR PROPER STAKE LOCATIONS FOR EACH UTILITY BEFORE WORK IS STARTED. THE CONTRACTOR SHALL NOTIFY IN WRITING THE OWNER OR THE ENGINEER OF ANY CHANGES, OMISSIONS, OR ERRORS FOUND ON THESE PLANS OR IN THE FIELD BEFORE WORK IS STARTED OR RESUMED.
- STANDARD SPECIFICATIONS FOR HAMILTON WESTERN UTILITIES SHALL APPLY FOR ALL SANITARY SEWERS AND SPECIFICATIONS FOR HAMILTON COUNTY SURVEYOR SHALL APPLY FOR ALL STORM SEWERS.
- ANY PART OF THE SANITARY OR STORM SEWER TRENCHES RUNNING UNDER PAVED AREAS TO BE BACKFILLED WITH GRANULAR MATERIAL.
- THE SIZE AND LOCATION OF EXISTING UTILITIES SHOWN ARE PER INFORMATION PROVIDED BY THE RESPECTIVE UTILITY COMPANIES. ALL UTILITY COMPANIES SHOULD BE NOTIFIED PRIOR TO ANY EXCAVATION FOR FIELD LOCATION OF SERVICES.
- SERVICE WALKS SHALL BE NON-REINFORCED CONCRETE 4" THICK AND 4" IN WIDTH.
- 4" CONCRETE SERVICE WALK ACROSS FRONTAGE OF EACH LOT TO BE CONSTRUCTED BY OTHERS.
- EXPANSION JOINTS AREA TO BE PLACED AT ALL WALK INTERSECTIONS AND BETWEEN WALKS AND PLATFORMS. SIDEWALK SPACES ARE TO BE EQUALLY SPACED BETWEEN EXPANSION JOINTS, CONTRACTION JOINTS AND PERPENDICULAR TO SIDEWALKS AT 5' INTERVALS OR LESS WITH A CONTRACTION JOINT EVERY 20' OR LESS.
- TEMPORARY TRAFFIC CONTROL DURING CONSTRUCTION TO CONFORM TO APPLICABLE LOCAL AND STATE STANDARDS.
- ALL CONSTRUCTION ACTIVITY ON THIS SITE TO BE PERFORMED IN COMPLIANCE WITH APPLICABLE C.S.I.H.A. STANDARDS FOR WORKER SAFETY.
- CONTRACTORS SHALL MINIMIZE DAMAGE TO EXISTING TREES. REMOVE AND BACKFILL ALL AREAS WHERE ANY FIELD TILE CROSSES PROPOSED HOUSE PADS. ALL FIELD TILES INTERCEPTED TO BE PERPETUATED INTO STORM SEWER SYSTEM OR LAKE. THE SUBCONTRACTOR SHALL NOTIFY IN WRITING THE OWNER AND THE ENGINEER IN ANY CIRCUMSTANCES WHERE THIS CANNOT BE ACCOMPLISHED.
- ALL FILL AREAS SHALL BE COMPACTION TO AT LEAST 95 PERCENT OF THE MAXIMUM DRY DENSITY (ASTM D-1557). FILL UNDER THE FOOTING SHALL BE COMPACTED TO AT LEAST 95 PERCENT OF THE MAXIMUM DRY DENSITY (ASTM D-1557).
- DECORATIVE SIGNS, SPRINKLER SYSTEMS, TREES, LANDSCAPING MOUNDS, LIGHT POLES OR OTHER SUCH AMENITIES ARE NOT PERMITTED IN THE RIGHT OF WAY.
- WATER MAIN VALVES SHALL NOT BE LOCATED UNDER STREET PAVEMENT.

## LEGEND

	Existing Storm Sewer
	New Storm Sewer
	Existing Sanitary Sewer
	New Sanitary Sewer
	Existing Contour
	Existing Elevation
	New Pavement Grade
	All Other Finish Grades
	Match Existing Grades
	Corrected Grades
	Storm Structure Number
	Sanitary Structure Number

	Denotes Elevation and Approximate Pad Size
	Flow Arrow
	4" Subsurface Drain
	Swale (○)
	Water Main
	Denotes Pad with 2' or More of Fill After Stripping
	Existing Trees
	Existing Gas Main
	Existing Telephone
	Existing Water Main
	Existing Flowline
	Existing Overhead Utilities

DATE: 8/15/01 Parameter No.: 1045.004  
DRAWN BY: MG Checked By:

SHEET TITLE: DEVELOPMENT PLAN


DRAWING FILES:  
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M:\1045\1045\1045.Dwg  
M:\1045\1045\1045.Dwg  
M:\1045\1045\1045.Dwg


DRINKER NO.: 1045.004  
SHEET NO.: 1045.004

DATE: SEP 12 2001


PAGE OF HAMILTON COUNTY SURVEYOR

C101

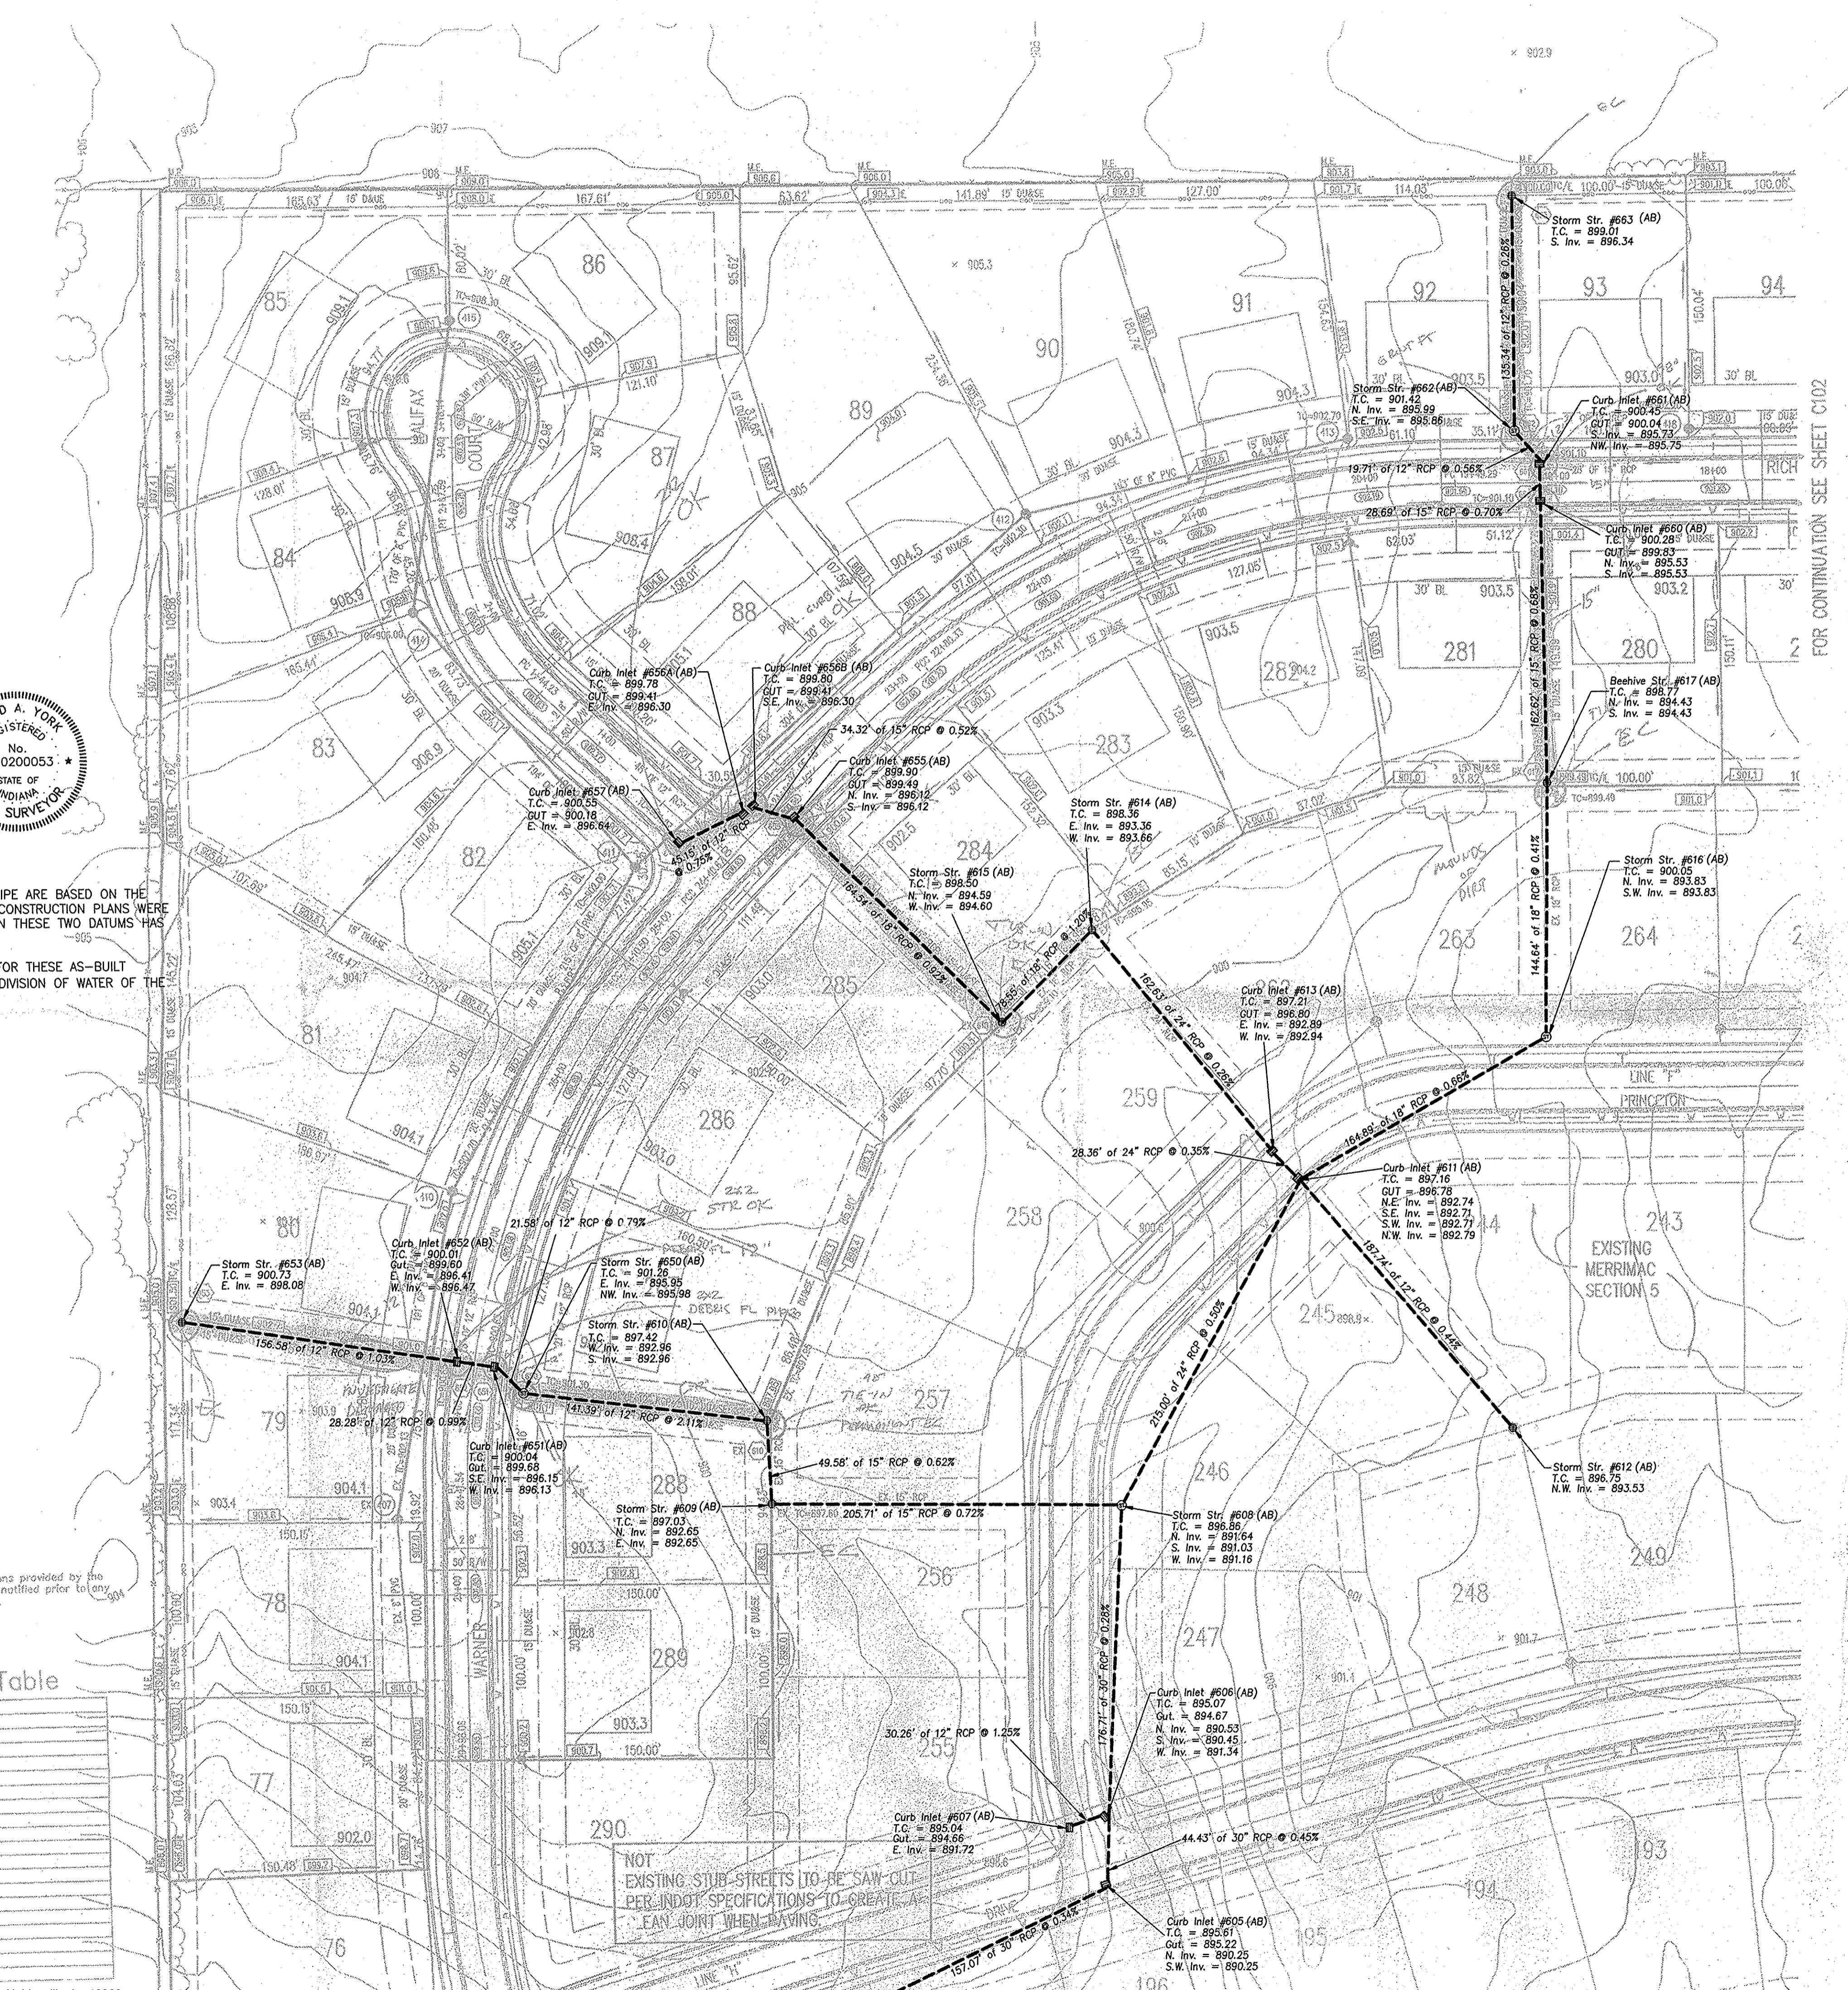


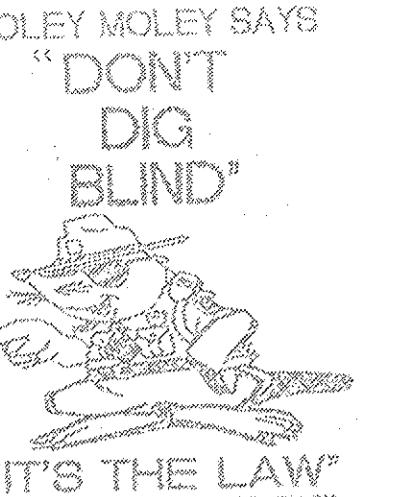


This information was gathered from input to the Hamilton County Geographic Information System (GIS). This document is considered an official record of the county. Date Entered: 8-2-2009  
Entered By: [Signature]

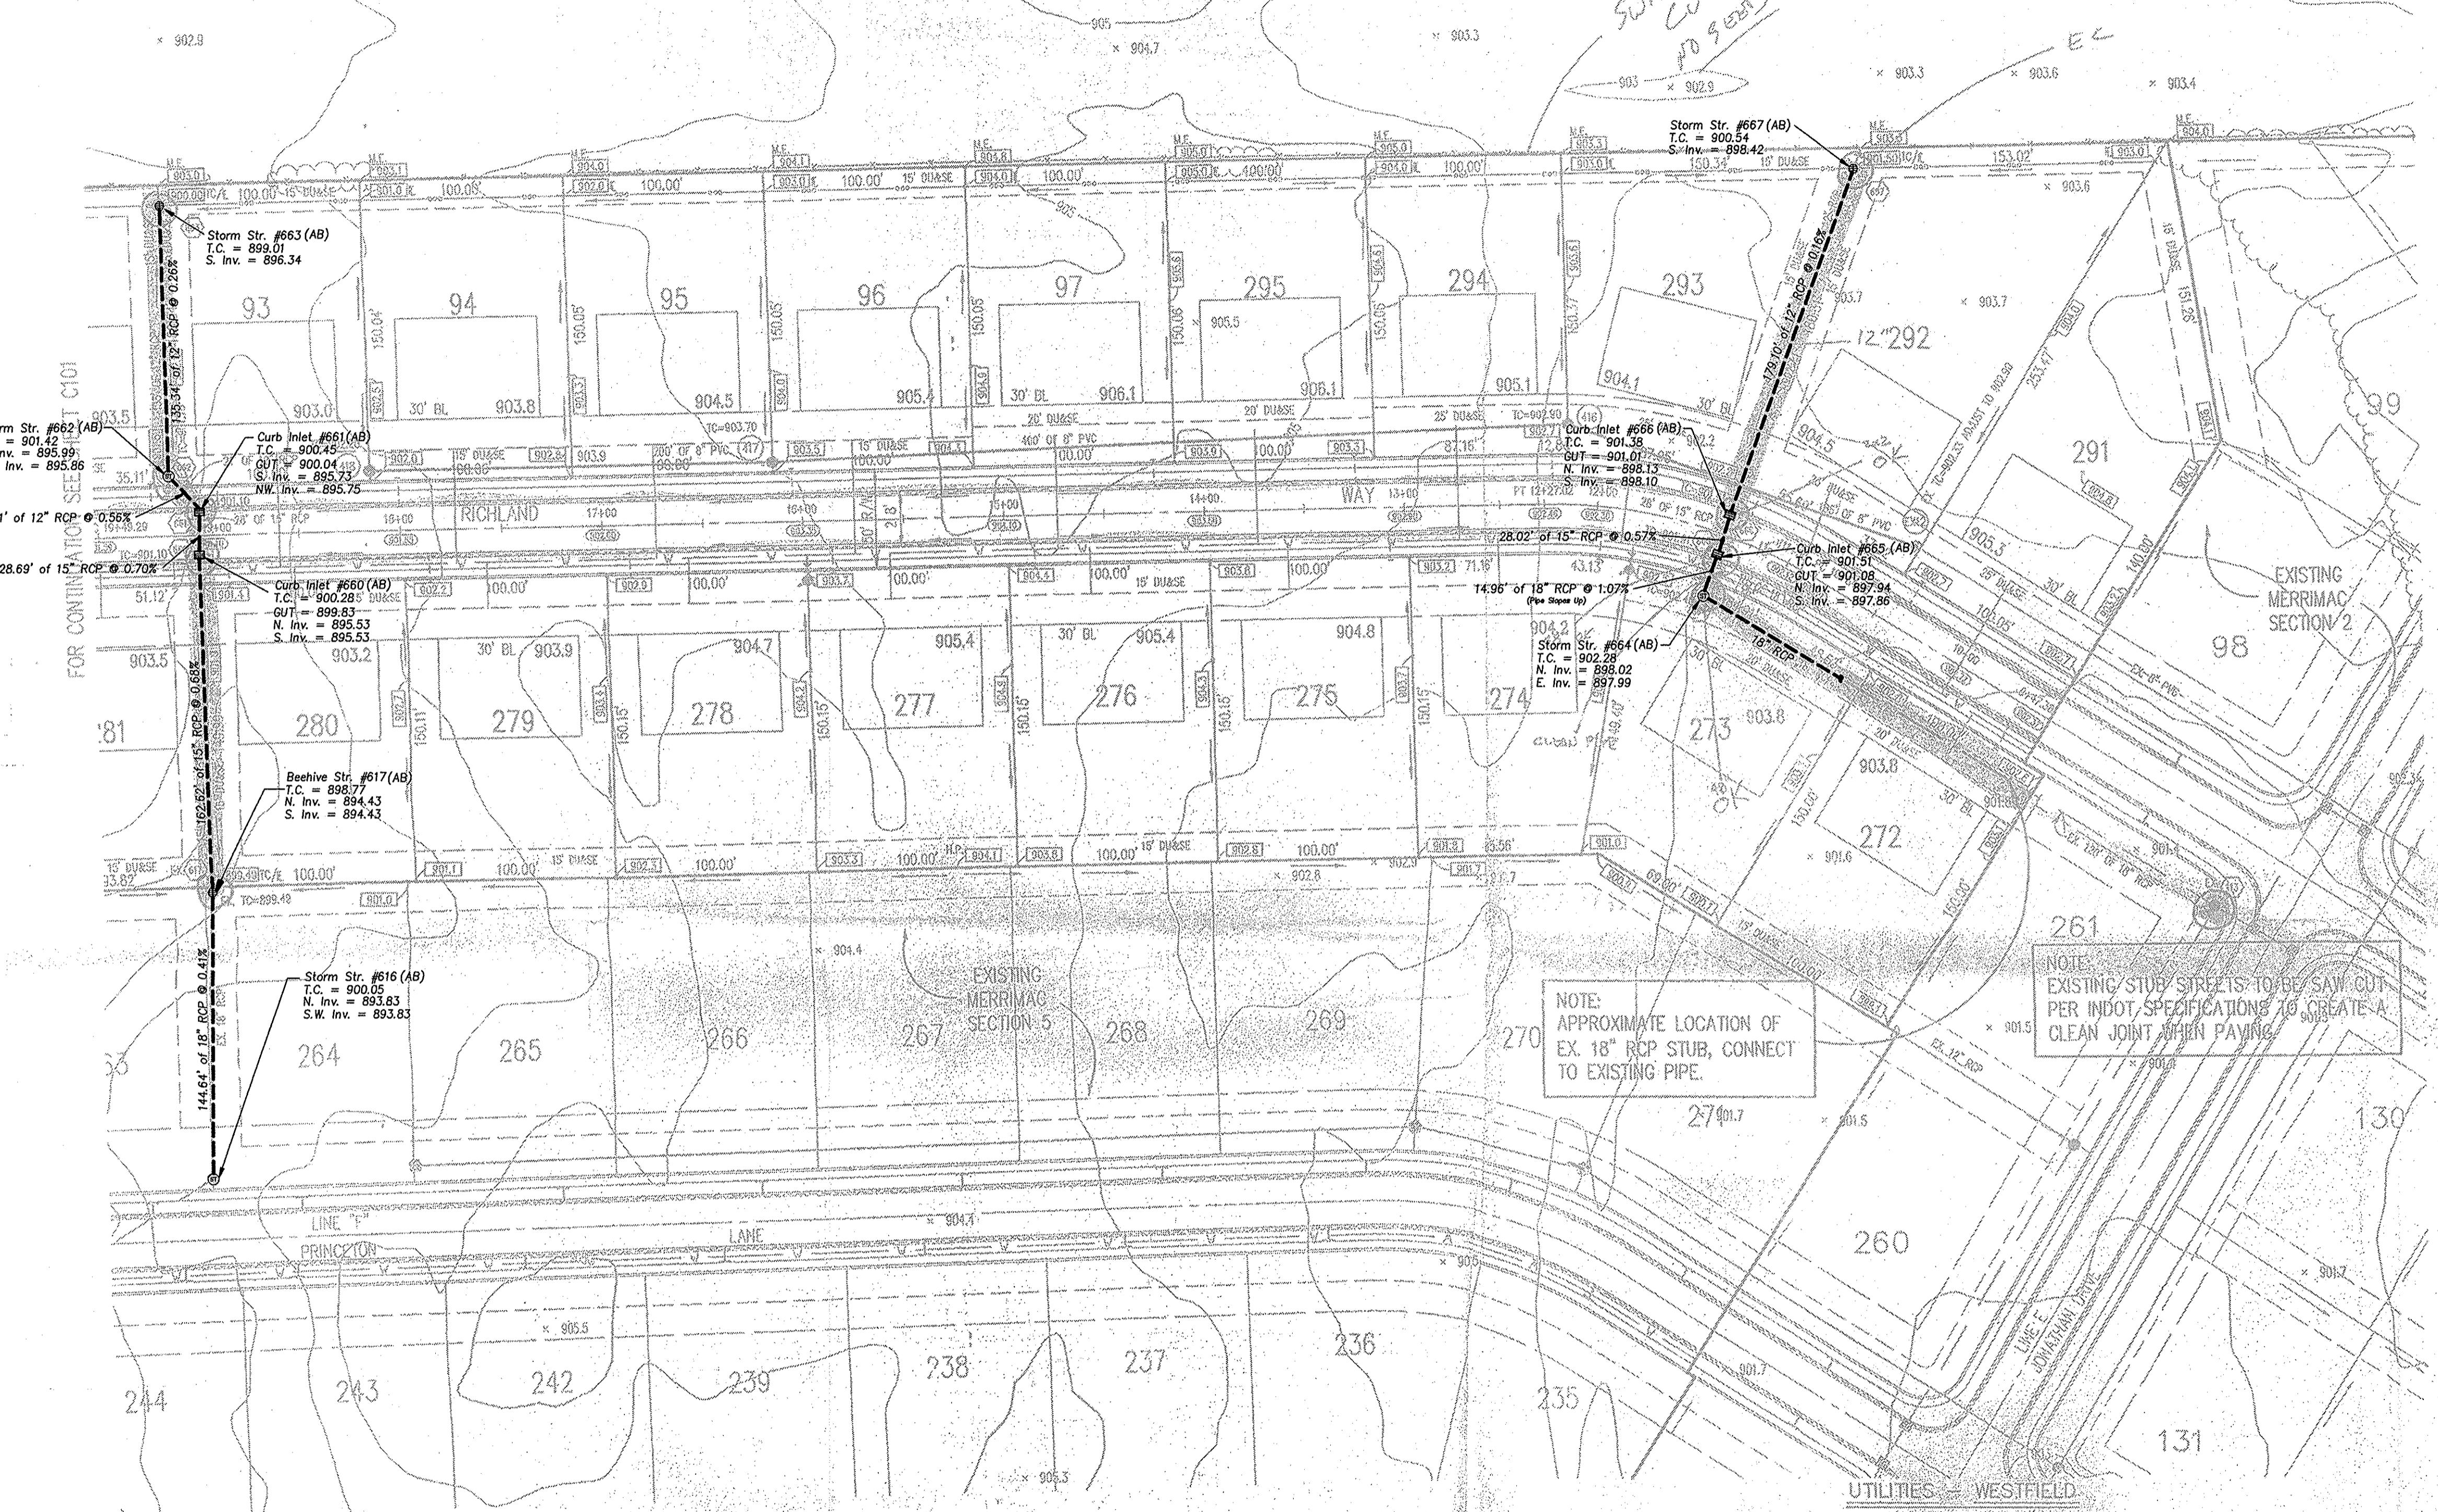


### GENERAL NOTES

- TEMPORARY TRAFFIC CONTROL DURING CONSTRUCTION TO COMPLY WITH APPLICABLE LOCAL AND STATE STANDARDS.
- ALL CONSTRUCTION ACTIVITY ON THIS SITE TO BE PERFORMED IN COMPLIANCE WITH APPLICABLE OSHA STANDARDS FOR WORKER SAFETY.
- IT SHALL BE THE CONTRACTOR'S RESPONSIBILITY TO FIELD VERIFY ALL UTILITY LOCATIONS BEFORE CONSTRUCTION BEGINS.
- CONTRACTORS SHALL MINIMIZE DAMAGE TO EXISTING TREES.

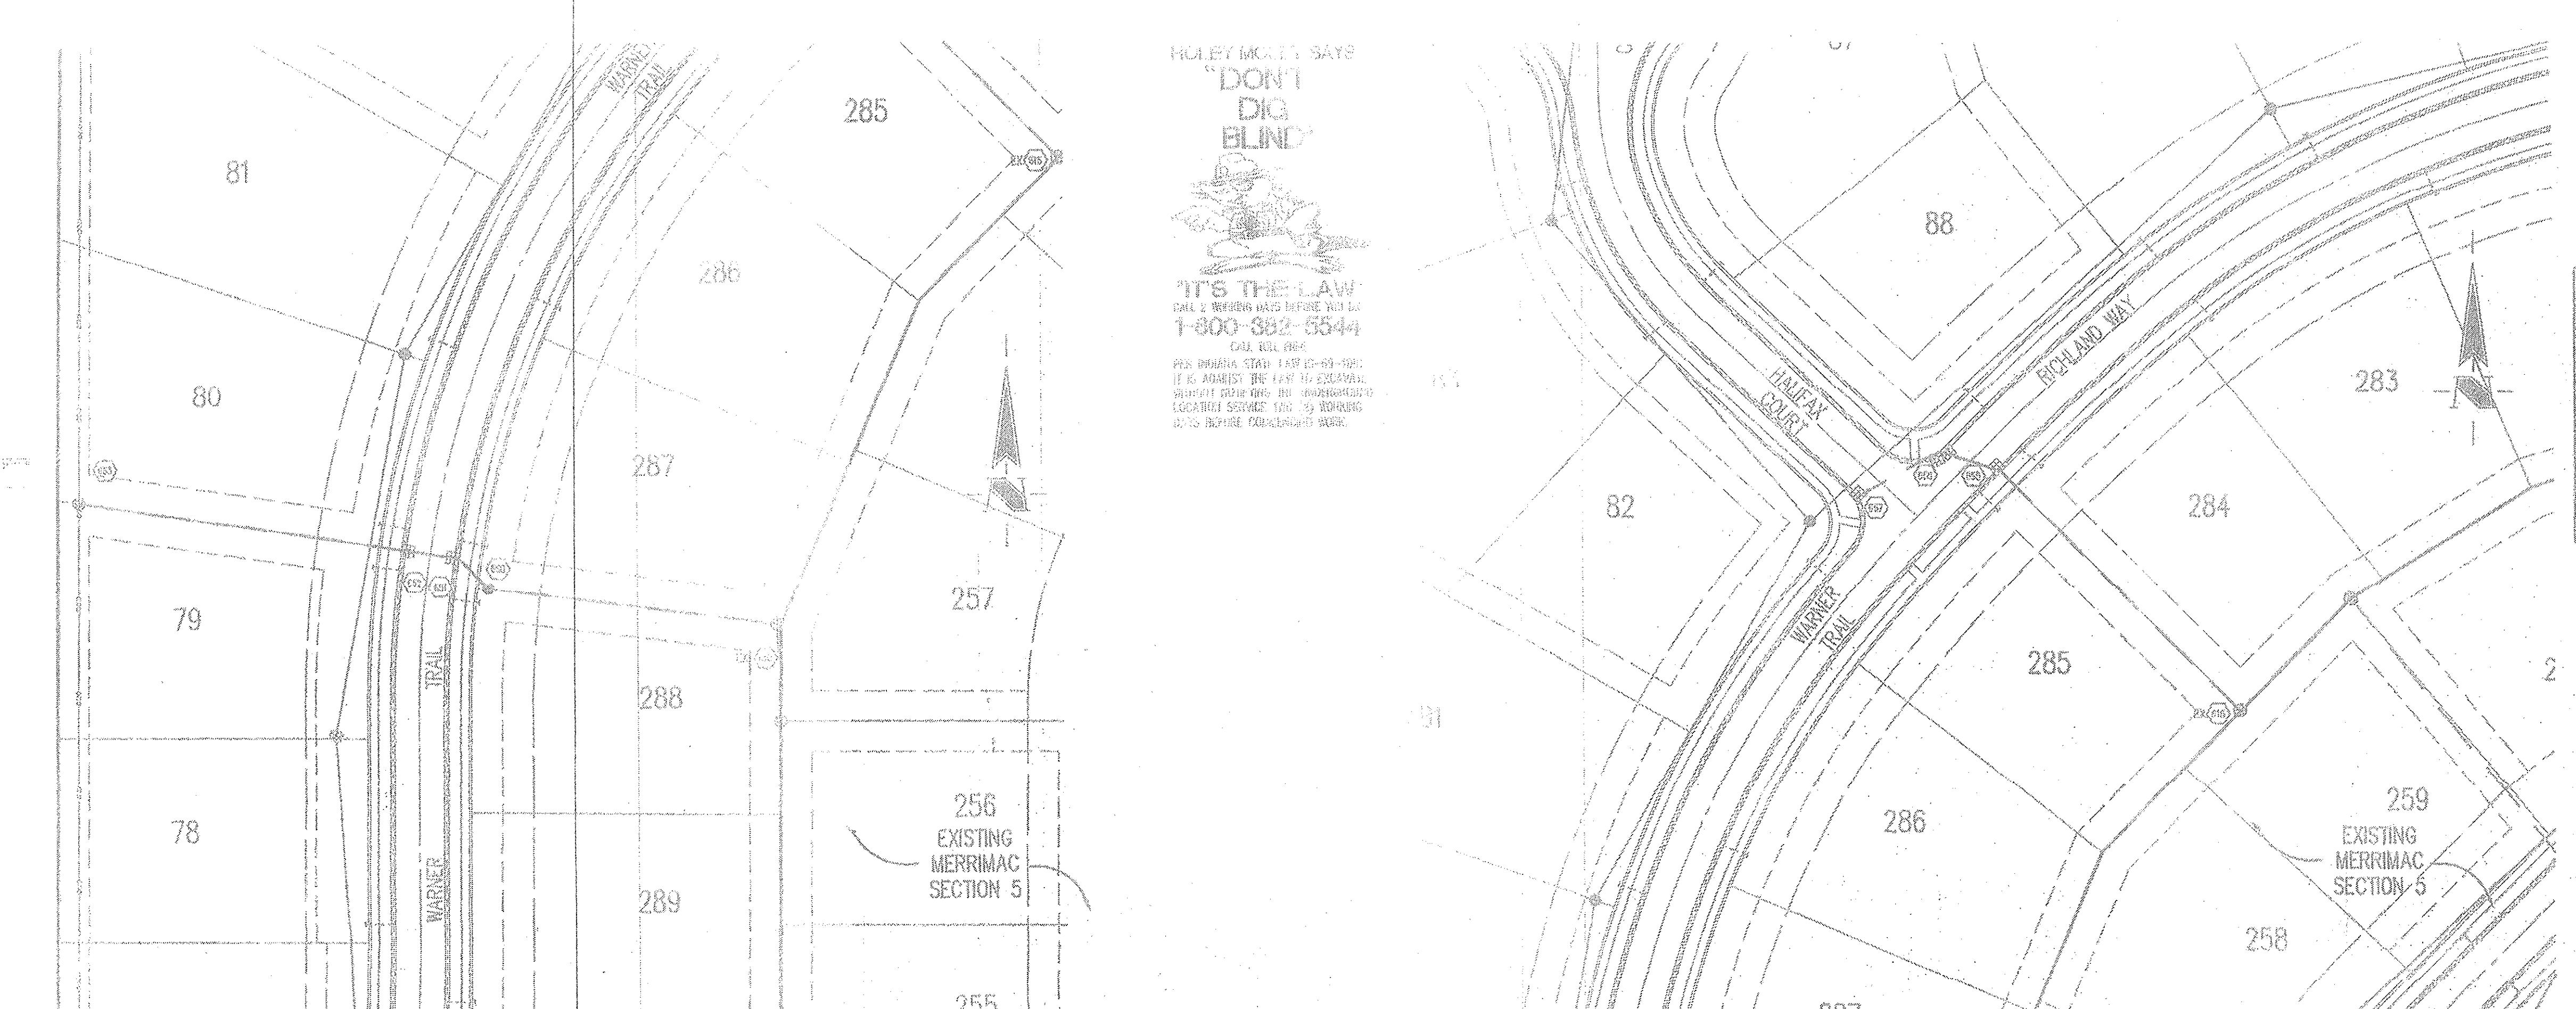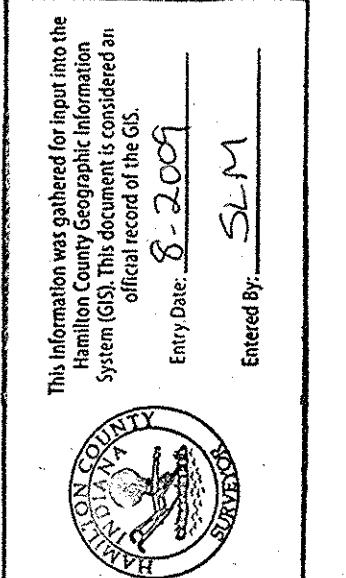

### BENCHMARK

U.S.G.S. #3 RRP (1851)  
BRONZE TABLET SET IN CONCRETE POST, LOCATED ON THE  
SOUTH SIDE OF 14TH STREET, APPROX. 25' WEST OF THE  
CENTERLINE OF DITCH ROAD.  
(ELEVATION = 903.373)

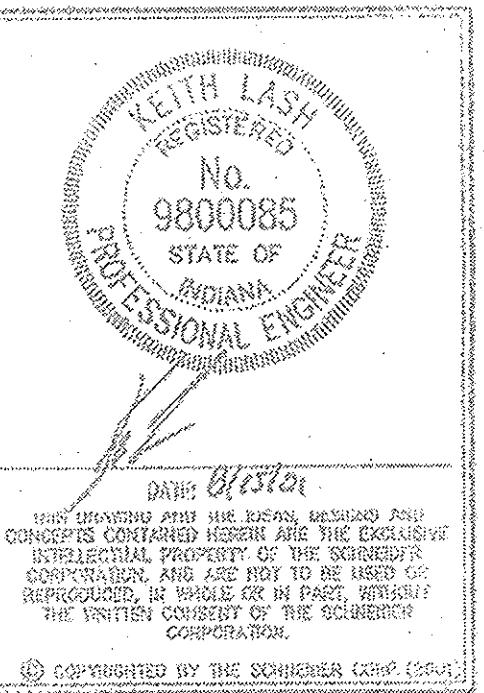

THE SCHNEIDER CORPORATION  
12821 E. New Market Street  
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Interior Design  
Land Surveying  
Landscape Architecture  
Transportation Engineering



### STORM SEWER PLAN

SCALE: 1"=50'



### GENERAL NOTES

1. TEMPORARY TRAFFIC CONTROL DURING CONSTRUCTION TO CONFORM TO APPLICABLE LOCAL AND STATE STANDARDS.
2. ALL CONSTRUCTION ACTIVITY ON THIS SITE TO BE PERFORMED IN COMPLIANCE WITH APPLICABLE OSHA STANDARDS FOR WORKERS SAFETY.
3. IT SHALL BE THE CONTRACTORS RESPONSIBILITY TO FIELD VERIFY ALL VERTICAL LOCATIONS BEFORE CONCRETE PLACEMENT.
4. CONTRACTORS SHALL MINIMIZE DAMAGE TO EXISTING TREES.

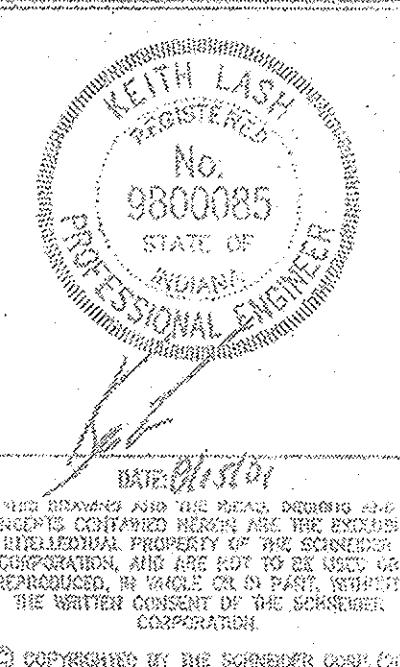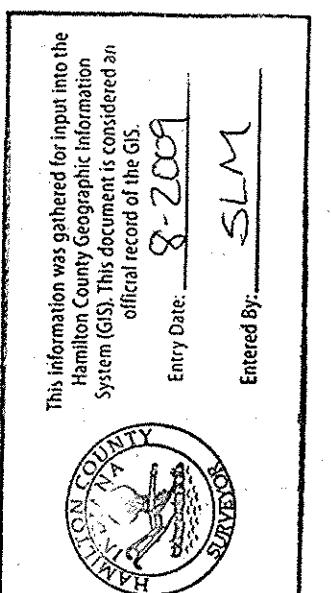

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Civil Engineering  
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Land Surveying  
Landscape Architecture  
Transportation Engineering

MERRIMAC  
SECTION 6  
WESTFIELD, INDIANA  
MERRIMAC CORP.  
CARMEL, INDIANA

F- F T C  
SEP 12 2001  
SHEET NUMBER: 0006  
DRAWN BY: MG  
CHECKED BY:

DATES: 8/15/01 PROJ. NO.: 1045.004  
DRAWN BY: MG CHECKED BY:  
SHEET NAME: STORM SEWER PLAN & PROFILE  
GRADE PLATE: 1045.004-0006-0006  
PAPER: 1045.004-0006-0006  
PRINT: 1045.004-0006-0006  
FILE: 1045.004-0006-0006  
DATE: 8/15/01  
TIME: 10:45 AM  
CITY: NOLBESVILLE, IN  
STATE: IN  
ZIP: 46060  
COUNTRY: USA

HICKLEY MOLLEY & CO.

"DON'T  
DIG  
BLIND"

"IT'S THE LAW"  
CALL 800-DIG-DIG-800  
1-800-382-5544  
CALL 101 101

PER DIGA STATE LAW 10-42-10-A  
IT IS ILLEGAL TO DIG OR DRILL  
WITHOUT NOTIFYING THE 800-DIG-DIG  
LOCATED SEVEN DAYS BEFORE COMMENCING  
DAYS BEFORE COMMENCING A JOB.

CALL 101 101

PER DIGA STATE LAW 10-42-10-A  
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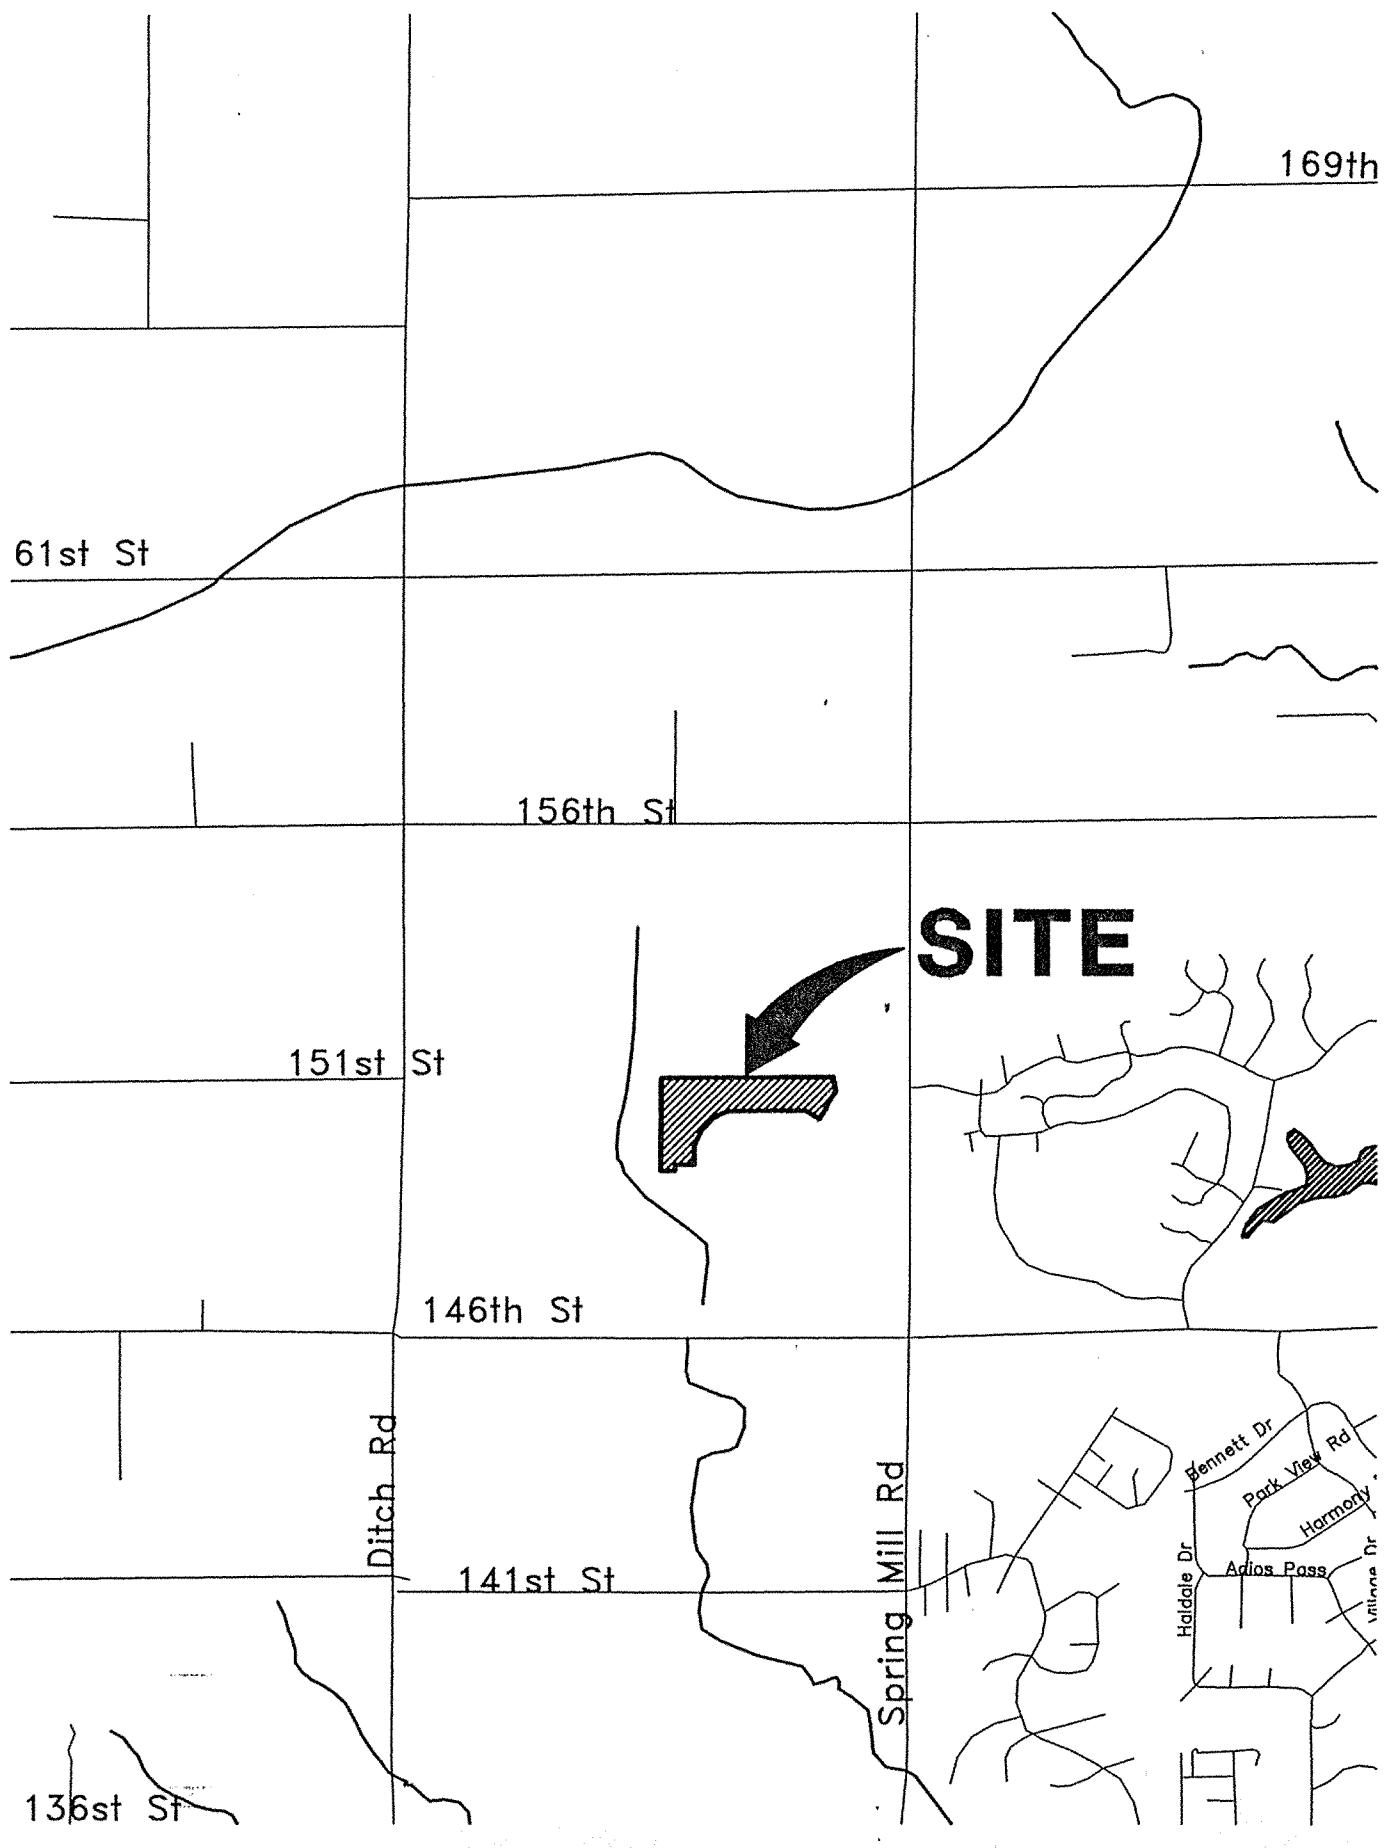
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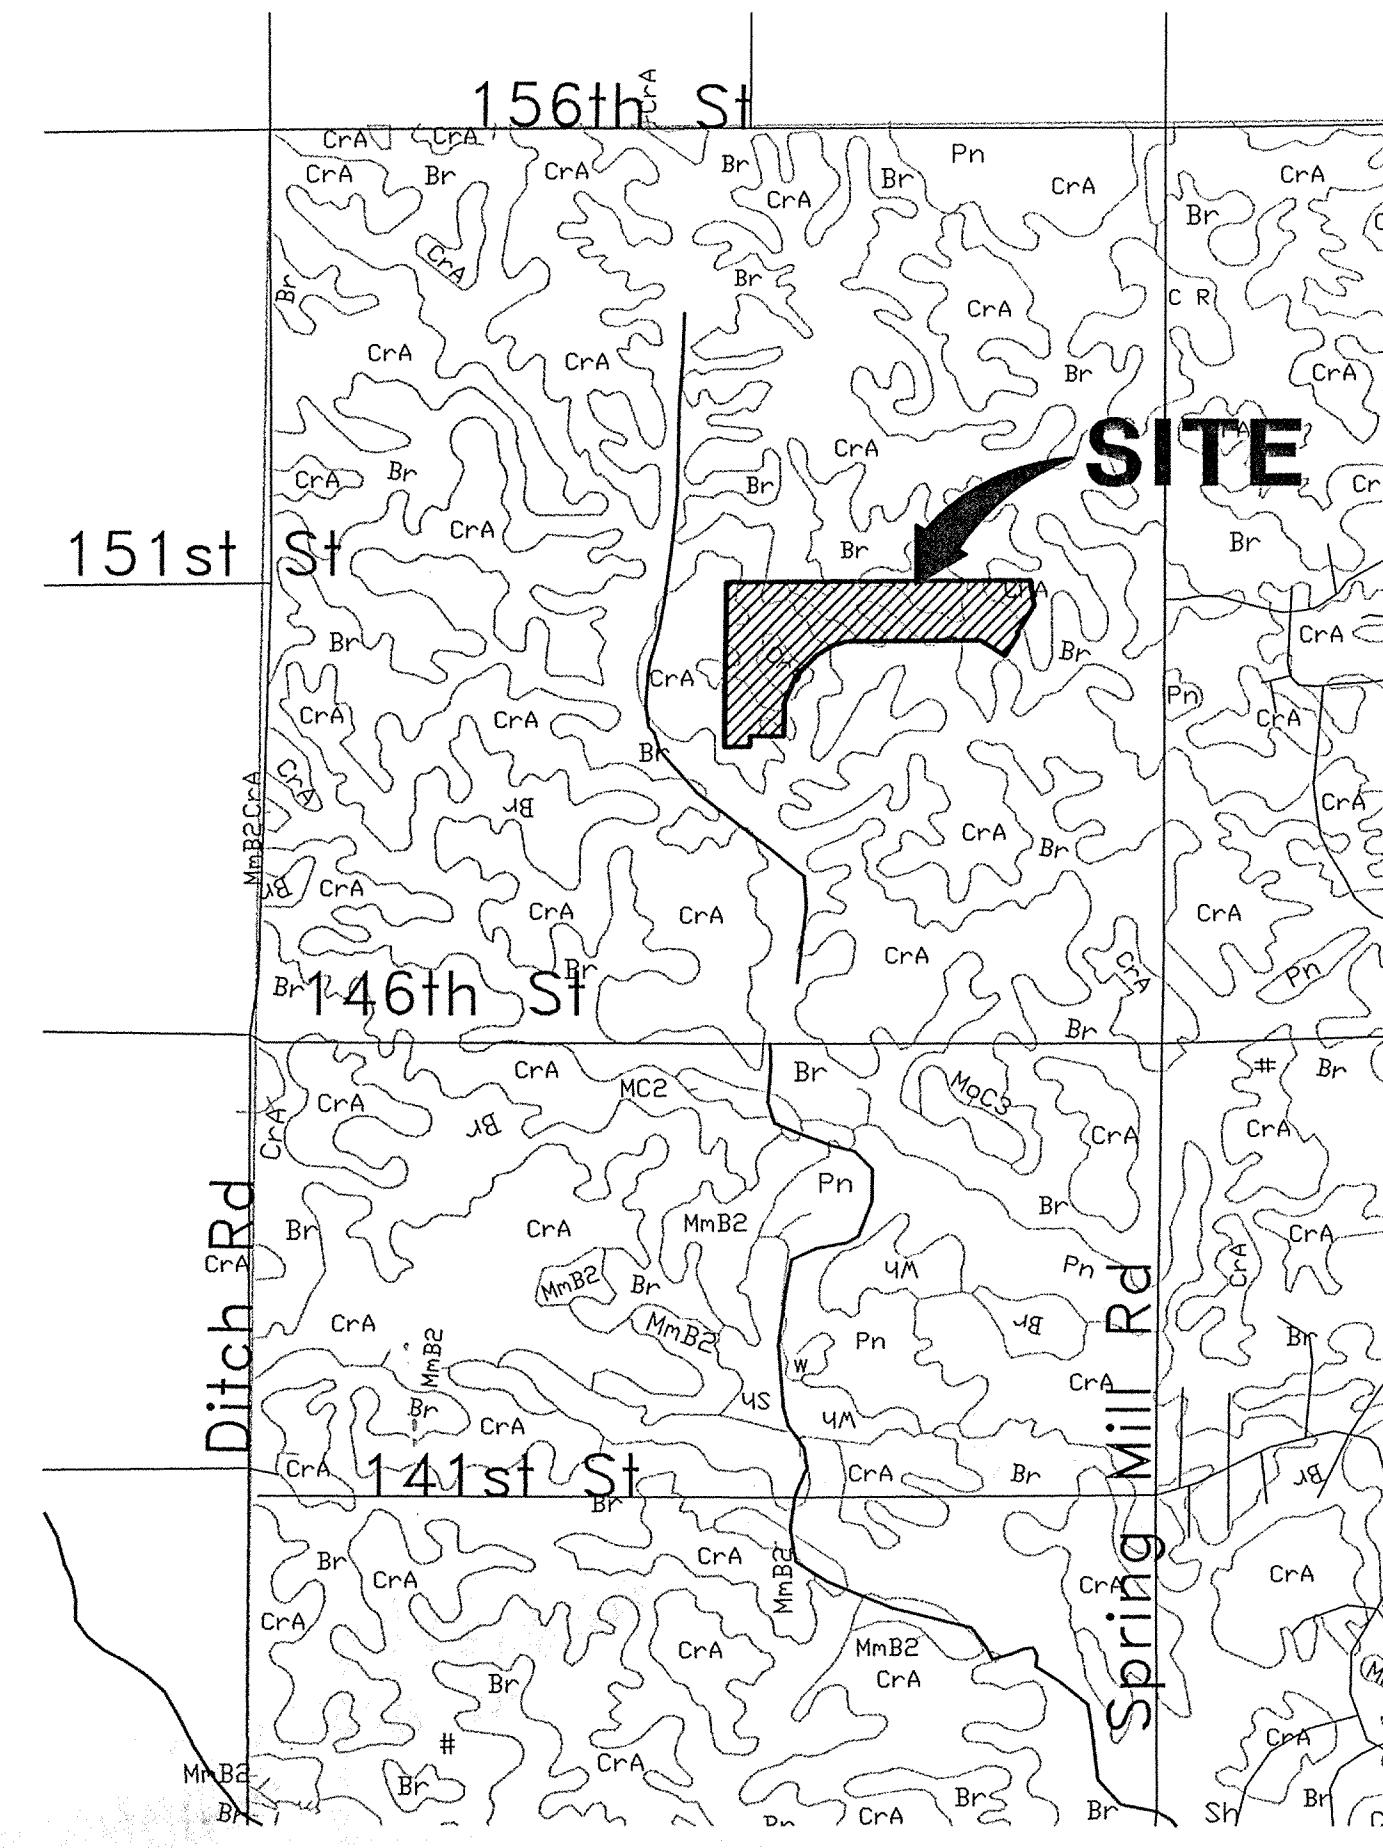
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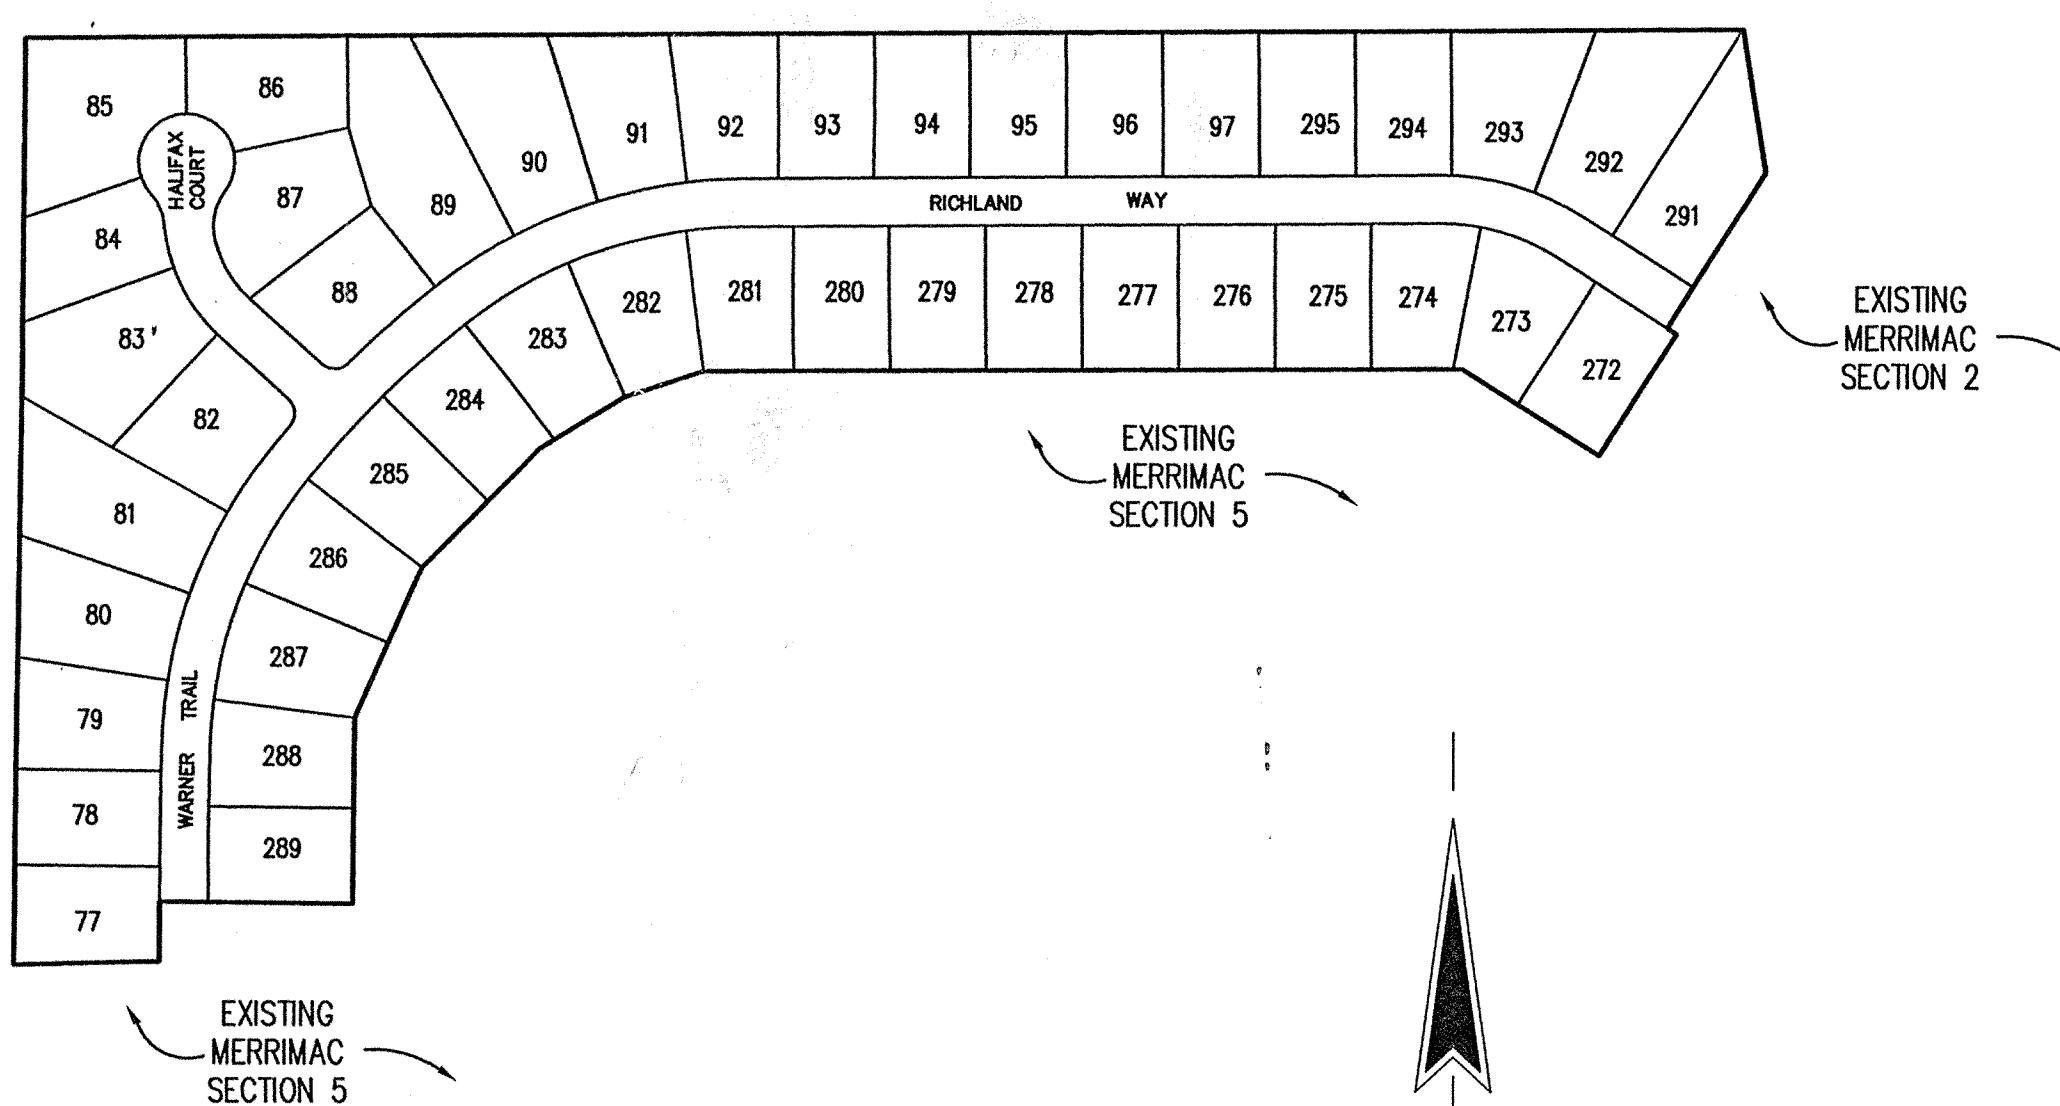
# AREA MAP

**NOT TO SCALE**



# **SOILS MAP**

**NOT TO SCALE**



# SITE MAP

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**SCALE: 1"=200'**

- SEC. 15-T18N-R3E -

# MERRIMAC

# SECTION 6

# (CONSTRUCTION PLANS)

# HAMILTON COUNTY WESTFIELD, INDIANA

# DEVELOPER

# MERRIMAC CORP.

## **582 SOUTH RANGELINE ROAD**

## **CARMEL, INDIANA 46032**

[317] 844-5111

INDEX	
SHEET No.	DESCRIPTION
C100	COVER SHEET
C101-C102	DEVELOPMENT PLAN
C103	EROSION CONTROL PLAN
C201-C202	STREET PLAN
C301	INTERSECTION DETAILS
C302	TRAFFIC CONTROL PLAN
C401-C402	SANITARY SEWER PLAN & PROFILE
C601-C602	STORM SEWER PLAN & PROFILE
C701	WATER DISTRIBUTION PLAN
C801	GENERAL DETAILS
C802-C803	HAMILTON COUNTY DETAILS
C804	EROSION CONTROL DETAILS
C805	WATER DETAILS & SPECIFICATIONS
C901	SPECIFICATIONS


**DESIGN SPEED  
25 MPH**



**SCHNEIDER CORPORATION**

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Carmel, IN 46032      Environmental Engineering  
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DATE: 3/15/01

SHEET  
**C100**  
OF  
19

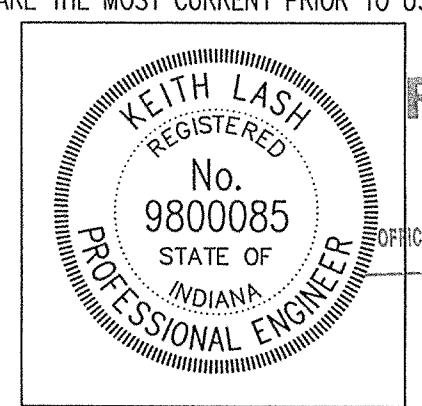CERTIFIED BY: KEITH LASH  
E-MAIL ADDRESS: [klash@s Schneidercorp.com](mailto:klash@s Schneidercorp.com)


#### **PROJECT ENGINEER:**

CHECKED BY: \_\_\_\_\_ DATE CHECKED: \_\_\_\_\_

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JOB No. (1045.004)



ASSUMED NORTH  
SCALE: 1"=50'

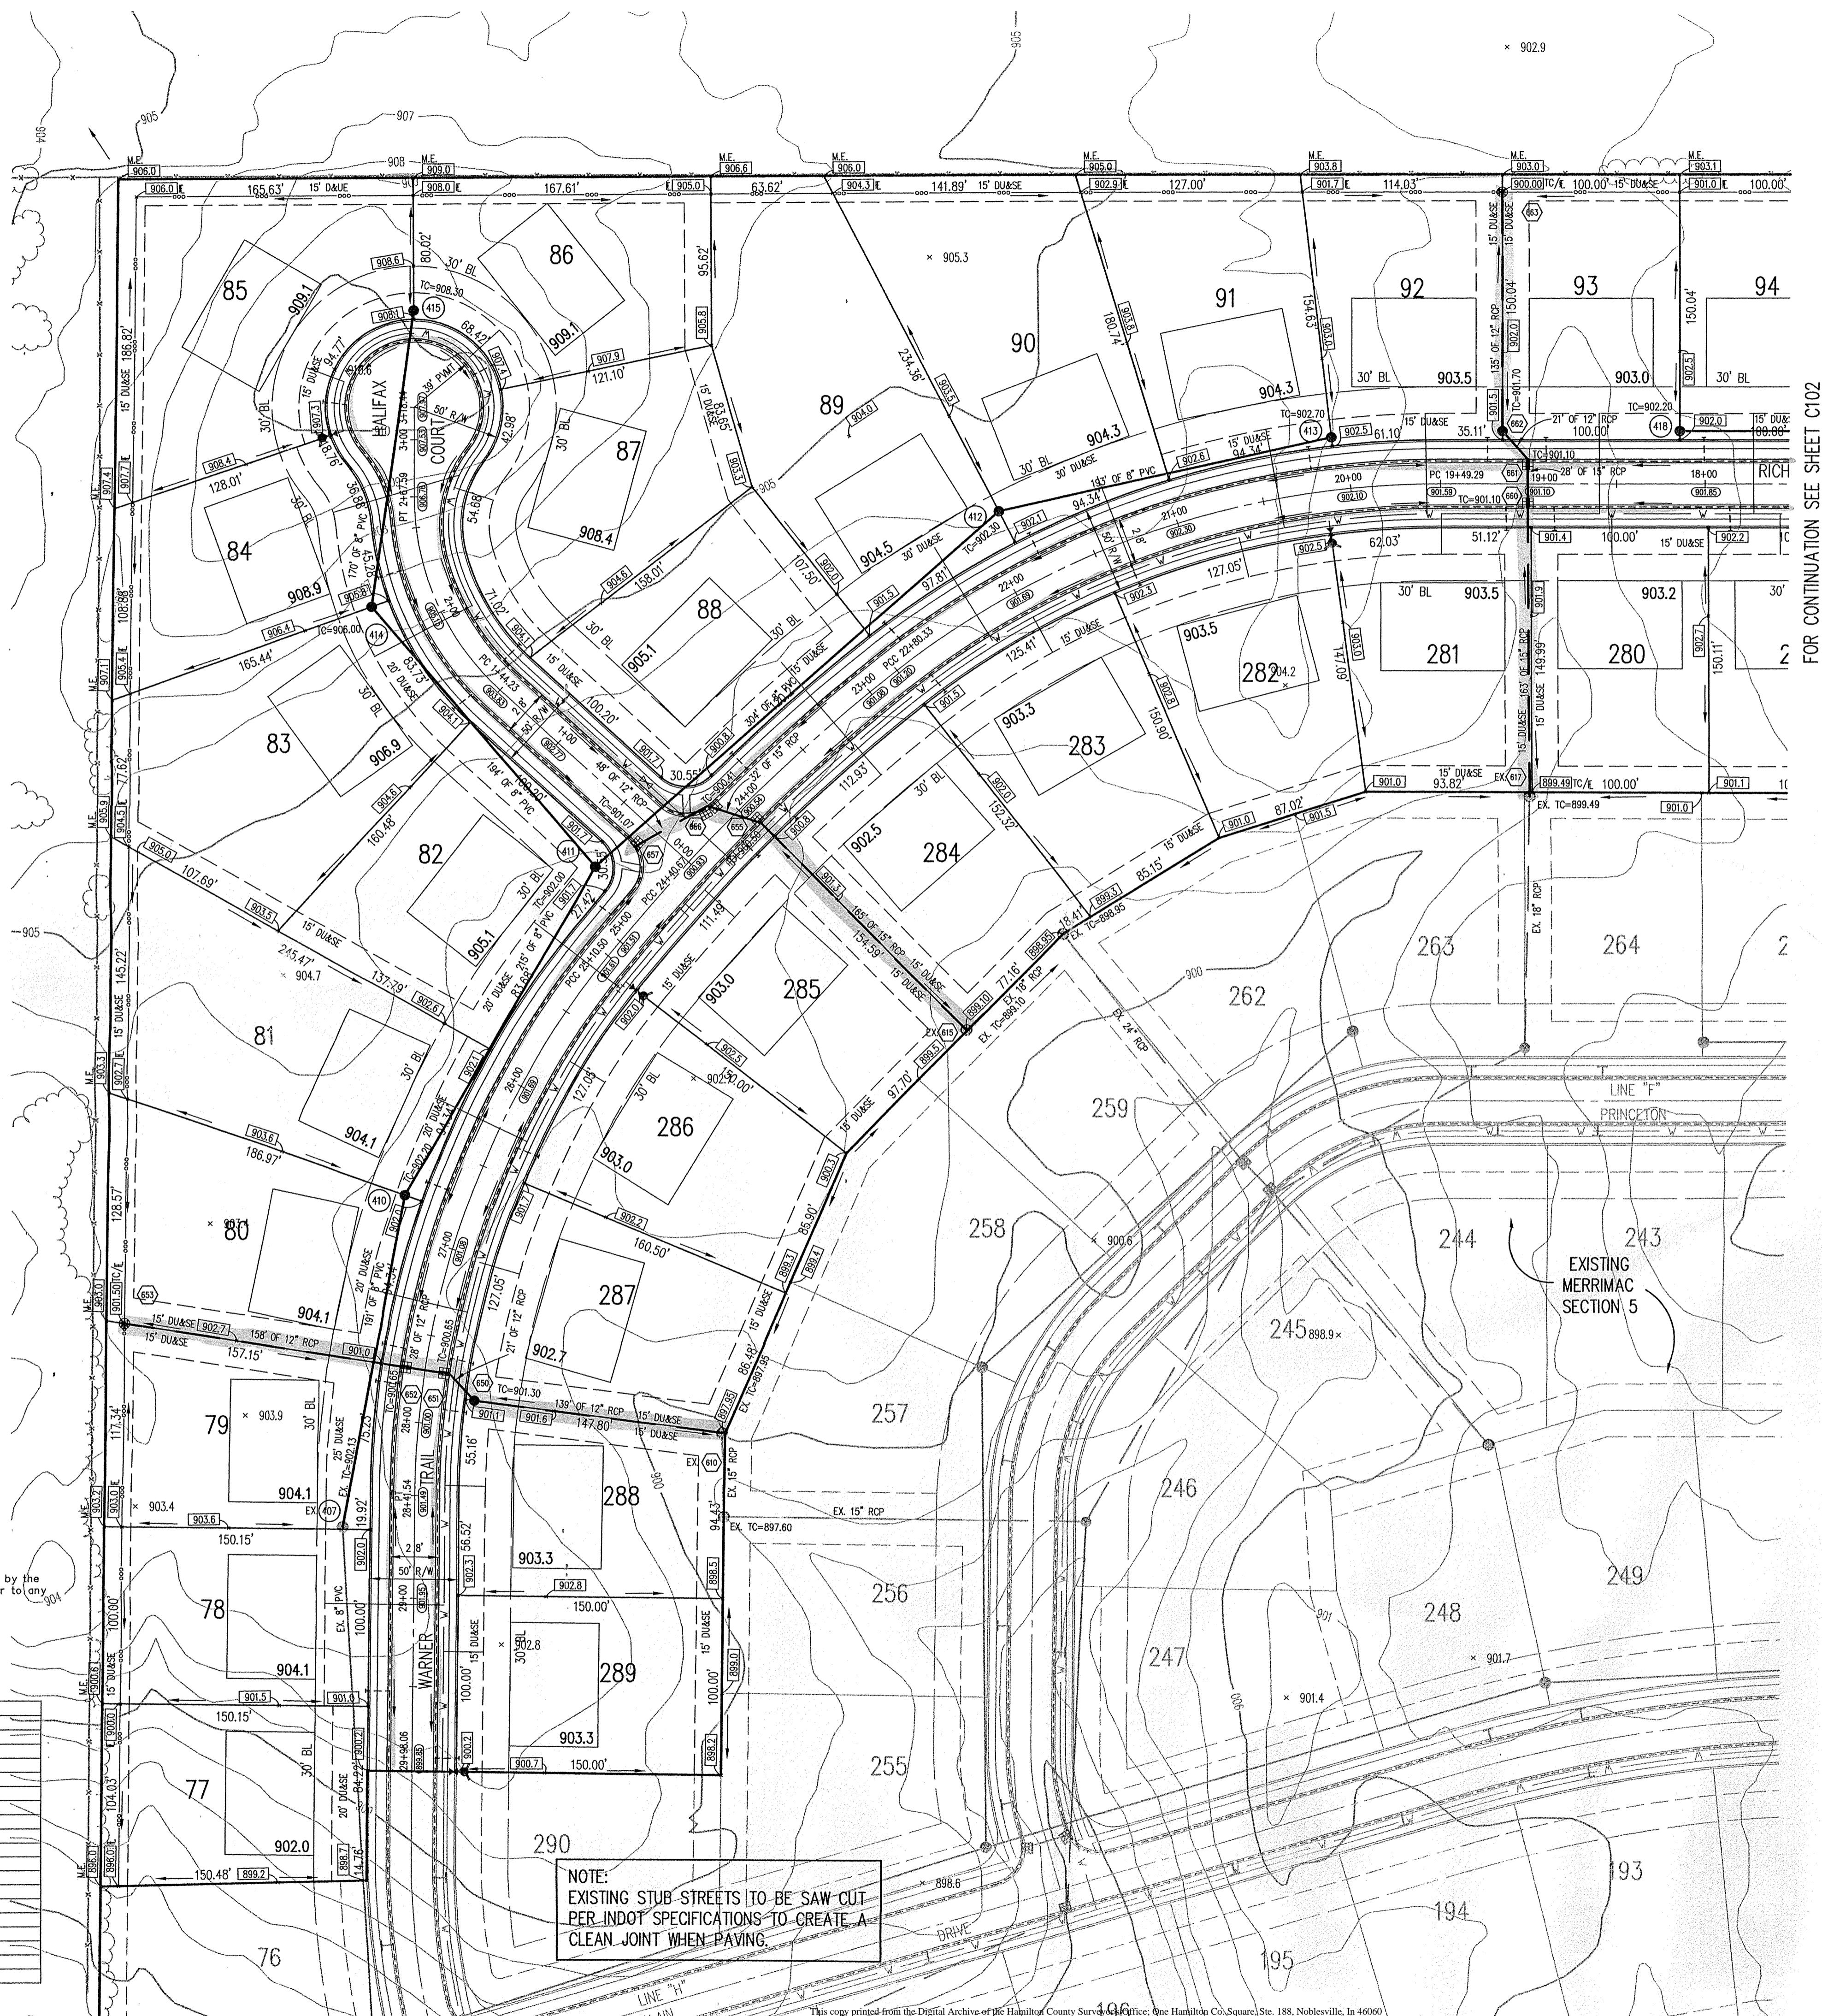
FOR CONTINUATION SEE SHEET C102



CALL 2 WORKING DAYS BEFORE YOU DIG  
1-800-382-5544

CALL TOLL FREE  
PER INDIANA STATE LAW IS-69-1991,  
IT IS AGAINST THE LAW TO EXCAVATE  
WITHOUT NOTIFYING THE UNDERGROUND  
LOCATION SERVICE TWO (2) WORKING  
DAYS BEFORE COMMENCING WORK.

REVISIONS:  
1. DCC 6/1/01, REVISED PER TAC COMMENTS

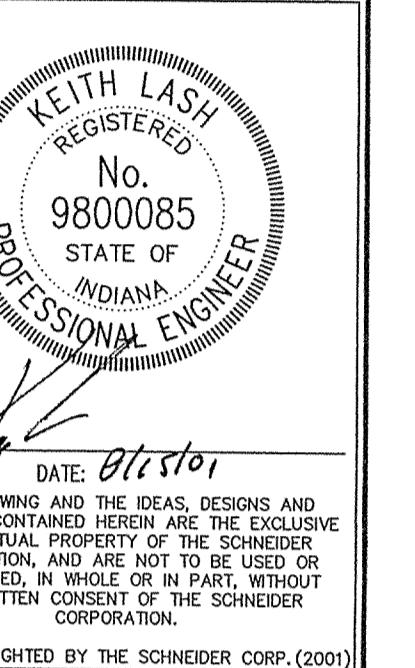

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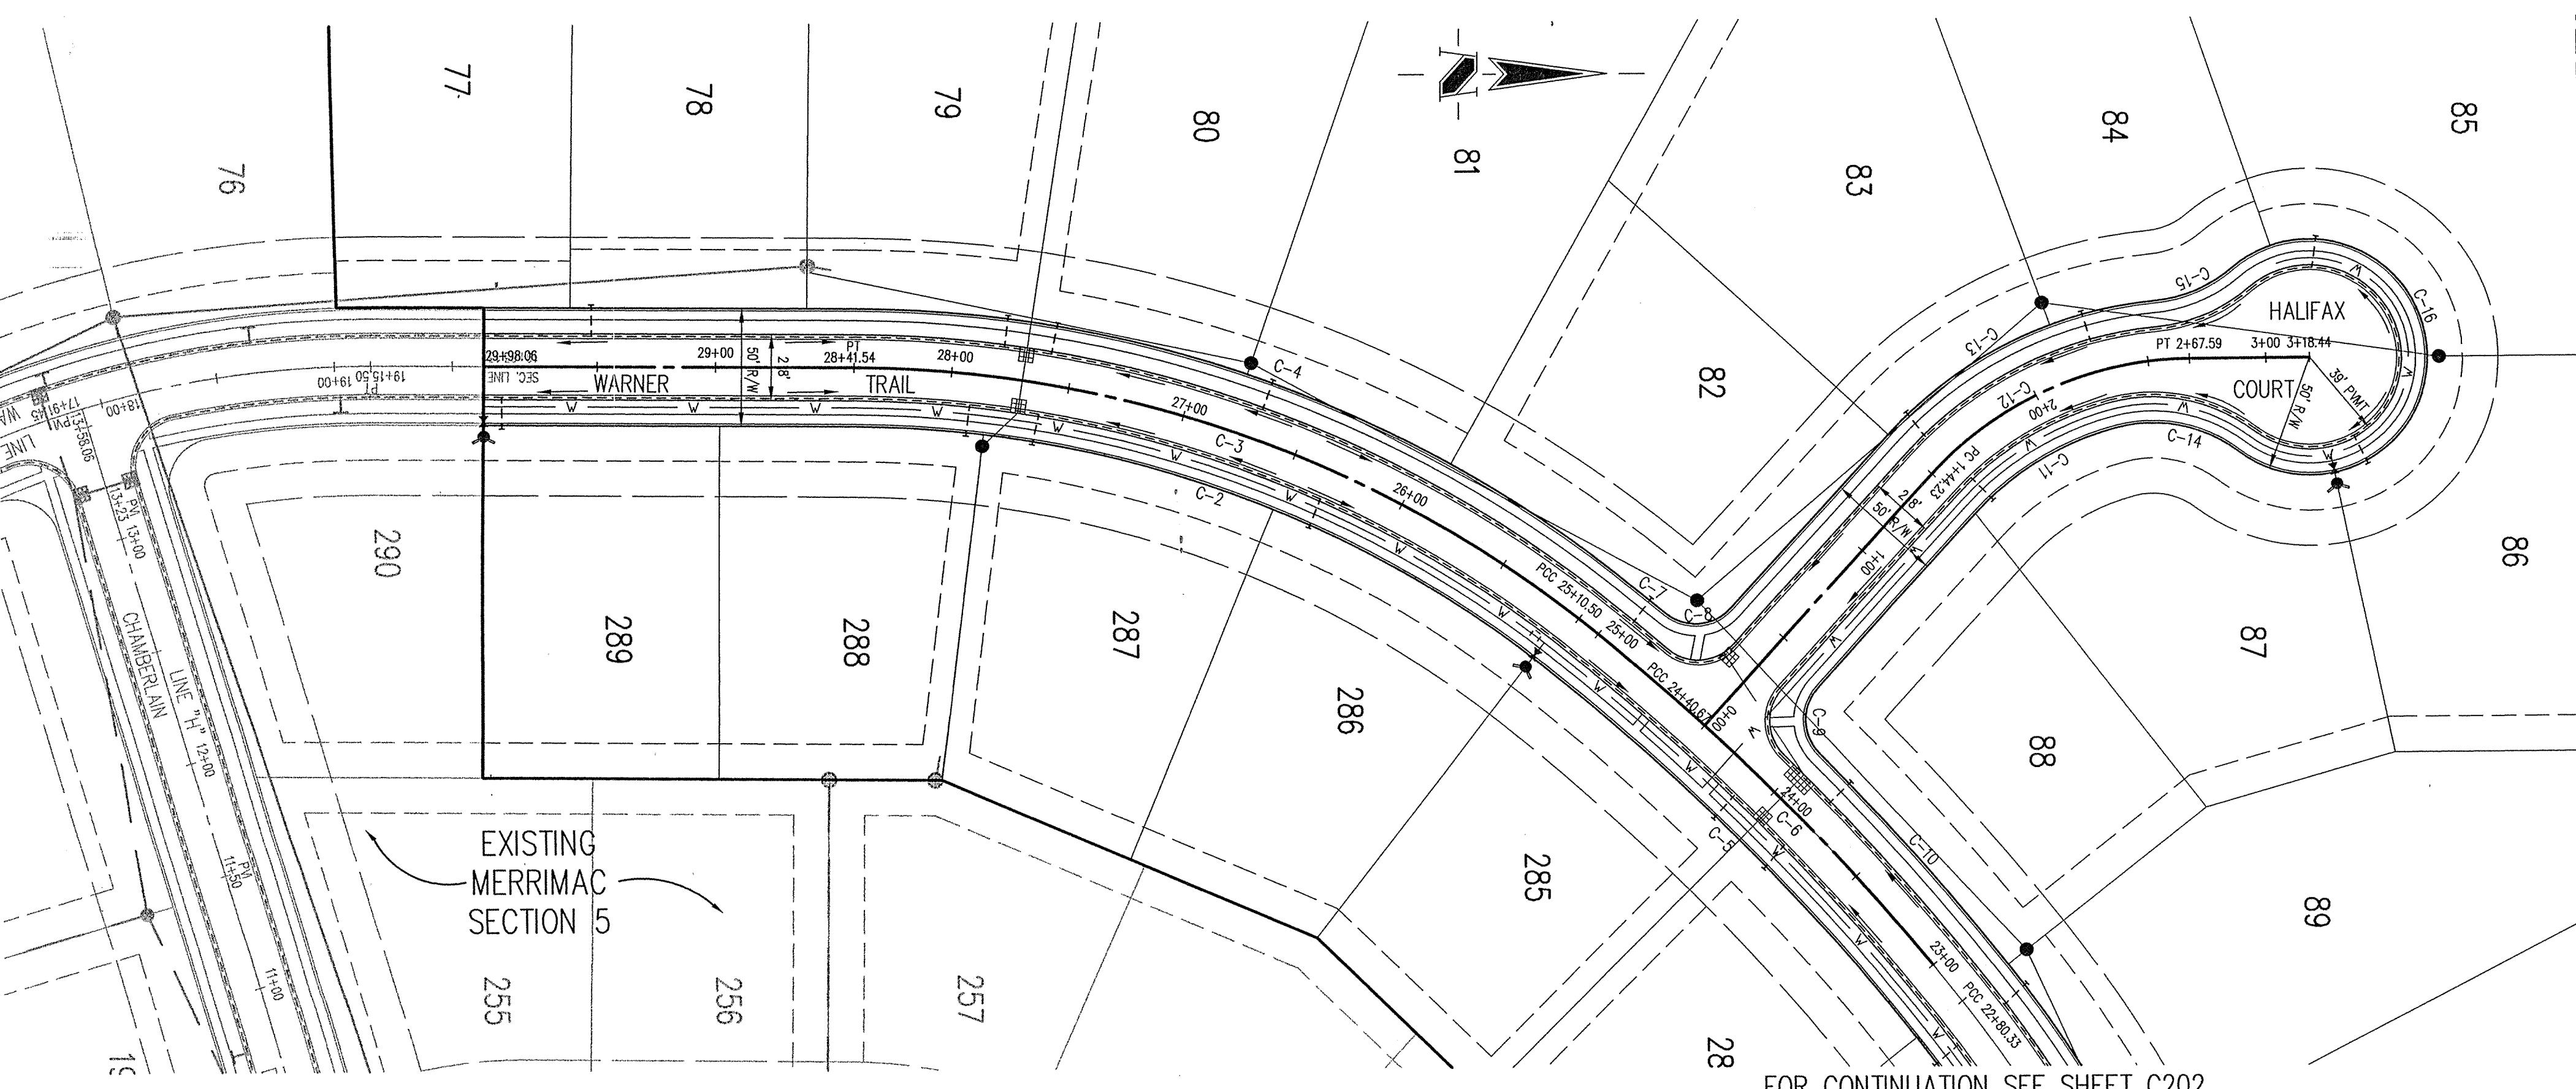
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Landscape Architecture  
Transportation Engineering

## MERRIMAC SECTION 6

WESTFIELD, INDIANA  
MERRIMAC CORP.,  
CARMEL, INDIANA

FILED  
SEP 12 2001  
OFFICE OF HAMILTON COUNTY SURVEYOR

DATE: 8/15/01	PROJECT NO.: 1045.004
DRAWN BY: MG	CHECKED BY:
SHEET TITLE: DEVELOPMENT PLAN	
DRAWING FILES: N:\\1045\\004\\DWGS\\C101.DWG KREF: 008.DWG 009.DWG 010.DWG 125.DWG 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A cartoon illustration of a mole wearing a cowboy hat and holding a shovel, standing next to a hole it has dug.

Sheet	Detail Number	Description
C801	1,2	Street Cross Section Details
C801	8	Concrete Sidewalk Detail
C801	10	Sidewalk Ramp For Handicapped Detail
C801	4,7	Curb Detail
C801	6	Pipe Underdrain Detail
C301		Intersection and Cul-de-sac Details
<b>NOTE</b>	All Streets to be 28' in width unless otherwise noted.	
	All Rights-of-way to be 50' in width unless otherwise noted.	

# LEGEND

1. TEMPORARY TRAFFIC CONTROL DURING CONSTRUCTION TO CONFORM TO APPLICABLE LOCAL AND STATE STANDARDS.
  2. ALL CONSTRUCTION ACTIVITY ON THIS SITE TO BE PERFORMED IN COMPLIANCE WITH APPLICABLE O.S.H.A. STANDARDS FOR WORKER SAFETY.
  3. IT SHALL BE THE CONTRACTORS RESPONSIBILITY TO FIELD VERIFY ALL UTILITY LOCATIONS BEFORE CONSTRUCTION BEGINS.
  4. CONTRACTORS SHALL MINIMIZE DAMAGE TO EXISTING TREES.

## BENCHMARK

U.S.G.S. 93 RHP (1951)  
BRONZE TABLET SET IN CONCRETE POST, LOCATED ON THE  
SOUTH SIDE OF 146th STREET, APPROX. 25' WEST OF THE  
CENTERLINE OF DITCH ROAD.  
(ELEVATION = 903.373)

A circular registration stamp with a decorative outer border. The text inside reads: "KEITH LASH" at the top, "REGISTERED" in the upper middle, "No." in the center, "9800085" below it, "STATE OF" in the lower middle, "INDIANA" at the bottom, and "PROFESSIONAL ENGINEER" along the bottom edge. A signature "Keith" is written across the bottom left of the stamp.

DATE: 01/15/01

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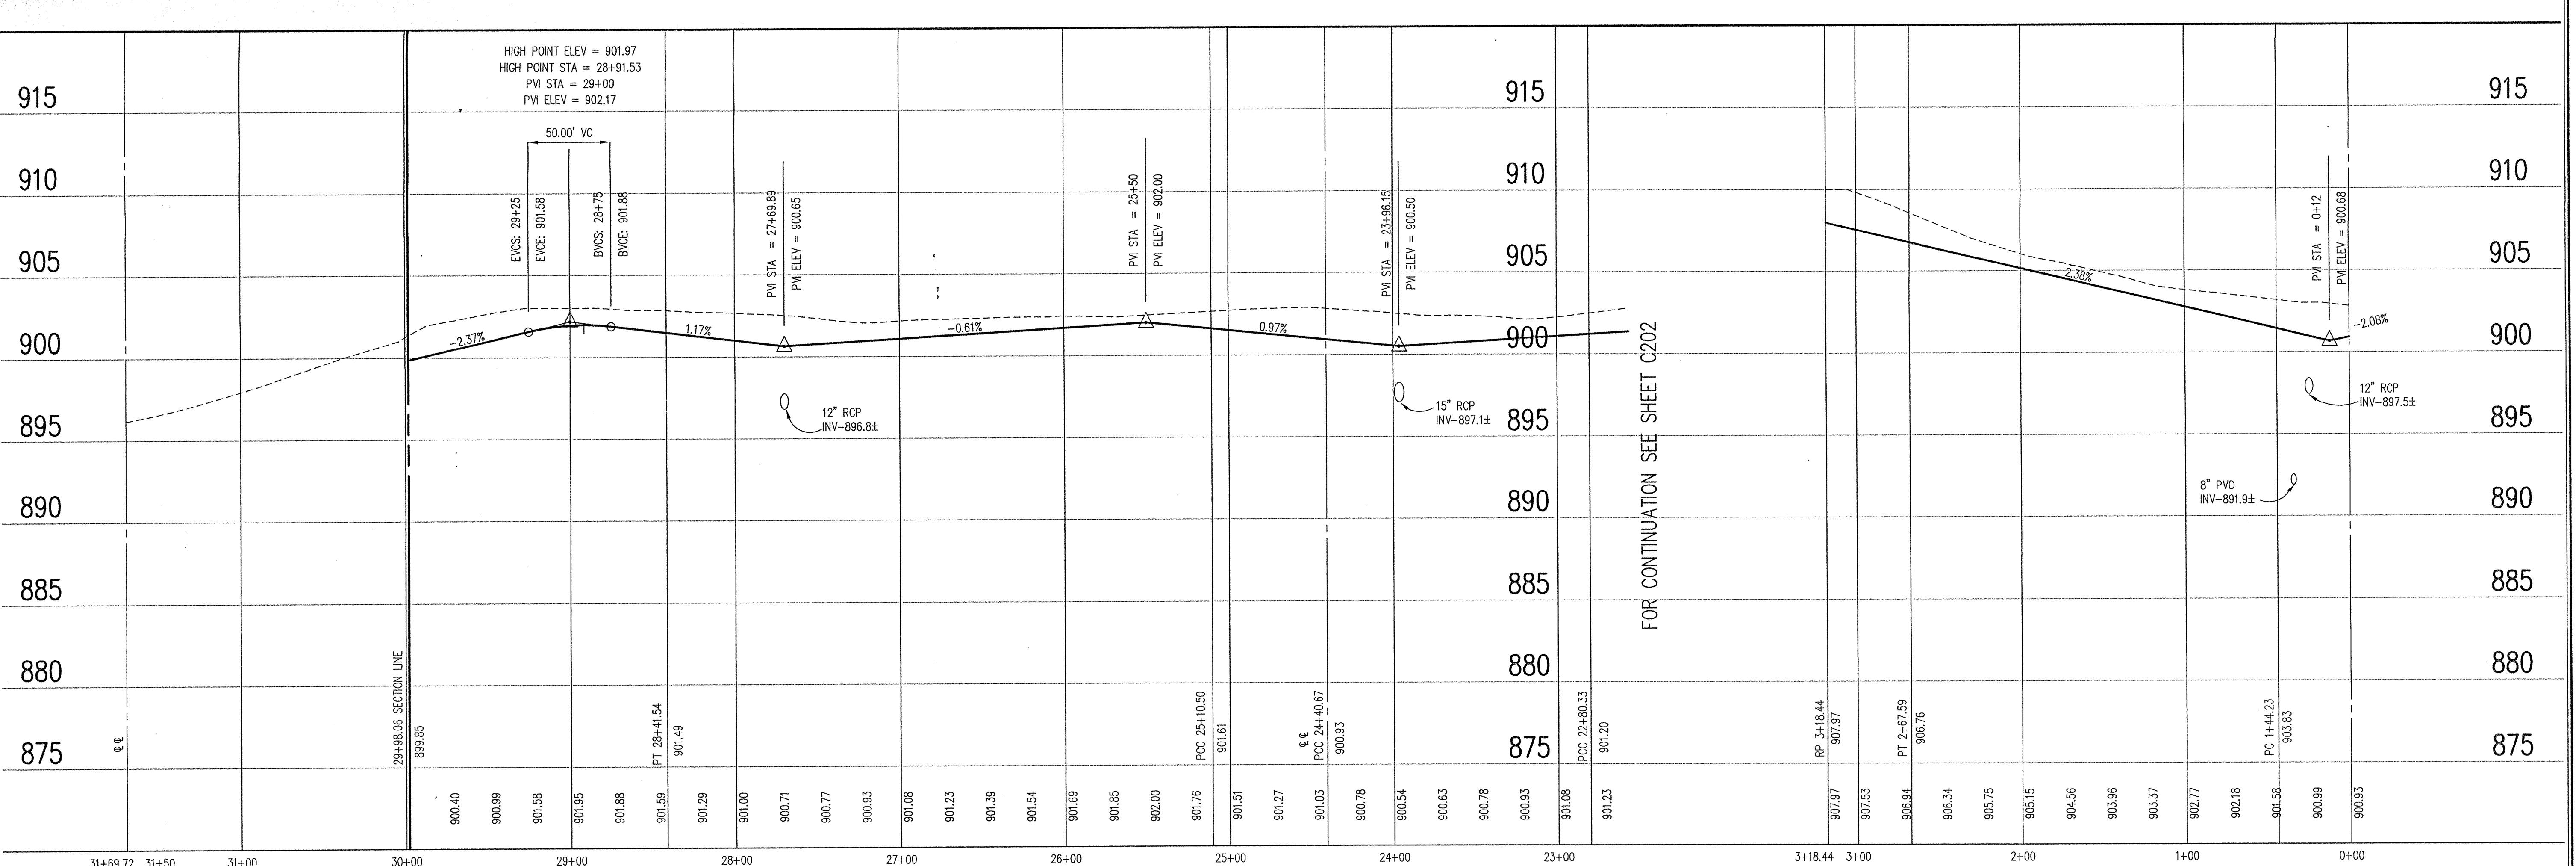
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# STREET PLAN

SCALE: 1"=50'




# STREET PROFILE

The legend is enclosed in a black-bordered box. It contains two entries: 'Existing Grade' with a dashed line icon, and 'New Grade' with a solid line icon.

SCALE: HORZ.: 1"=50'  
VERT.: 1"=5'

STREET NO.: C201

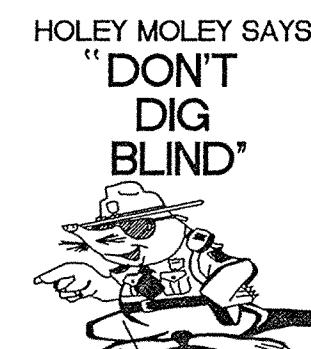

"IT'S THE LAW"  
CALL 2 WORKING DAYS BEFORE YOU DIG  
1-800-382-5544

CALL TOLL FREE  
PER INDIANA STATE LAW IS-69-1991  
IT IS AGAINST THE LAW TO DIG  
WITHOUT NOTIFYING THE UNDERGROUND  
LOCATION SERVICE TWO (2) WORKING  
DAYS BEFORE COMMENCING WORK.

FOR CONTINUATION SEE SHEET C201

HOLEY MOLEY SAYS

DON'T  
DIG  
BLIND™

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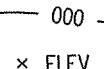
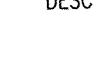
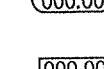
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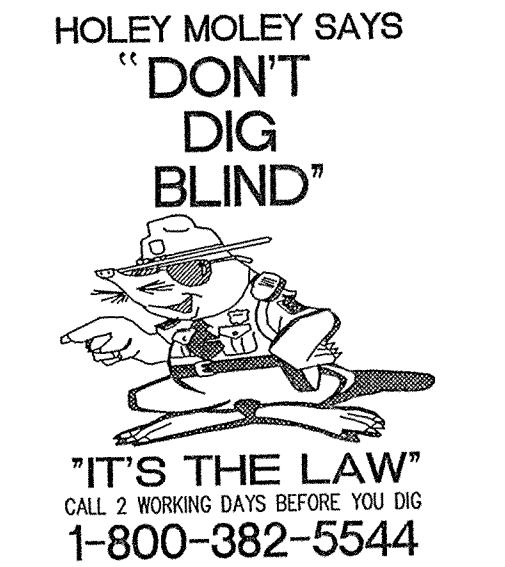
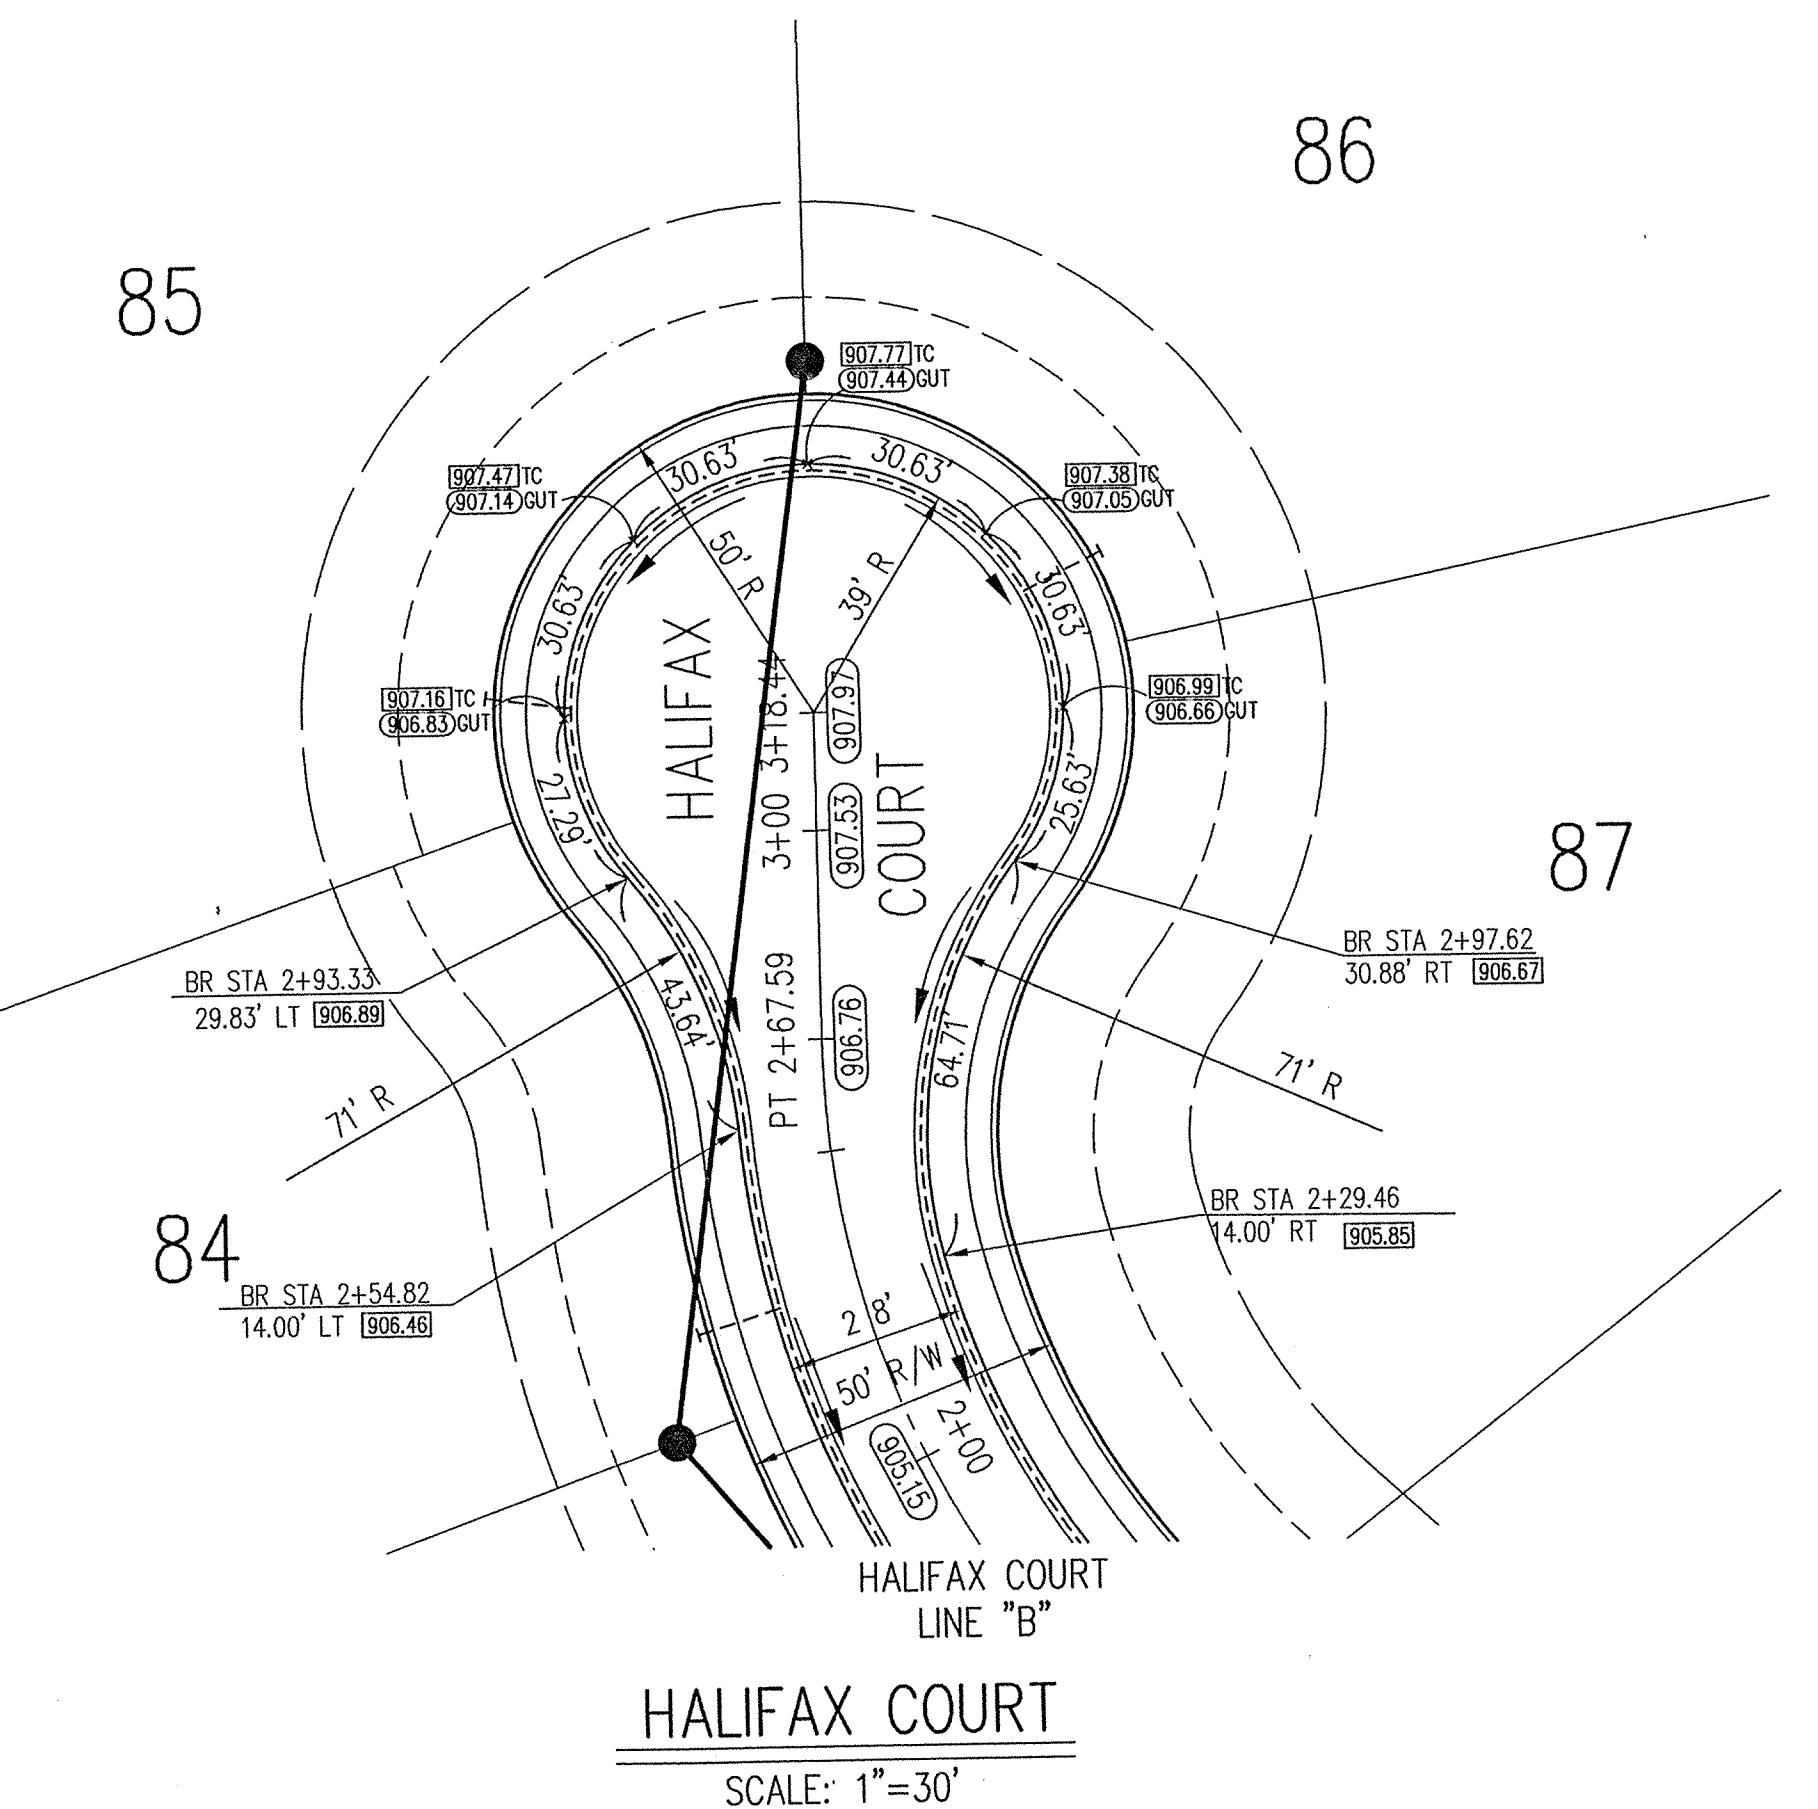
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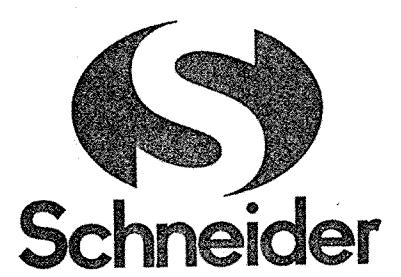
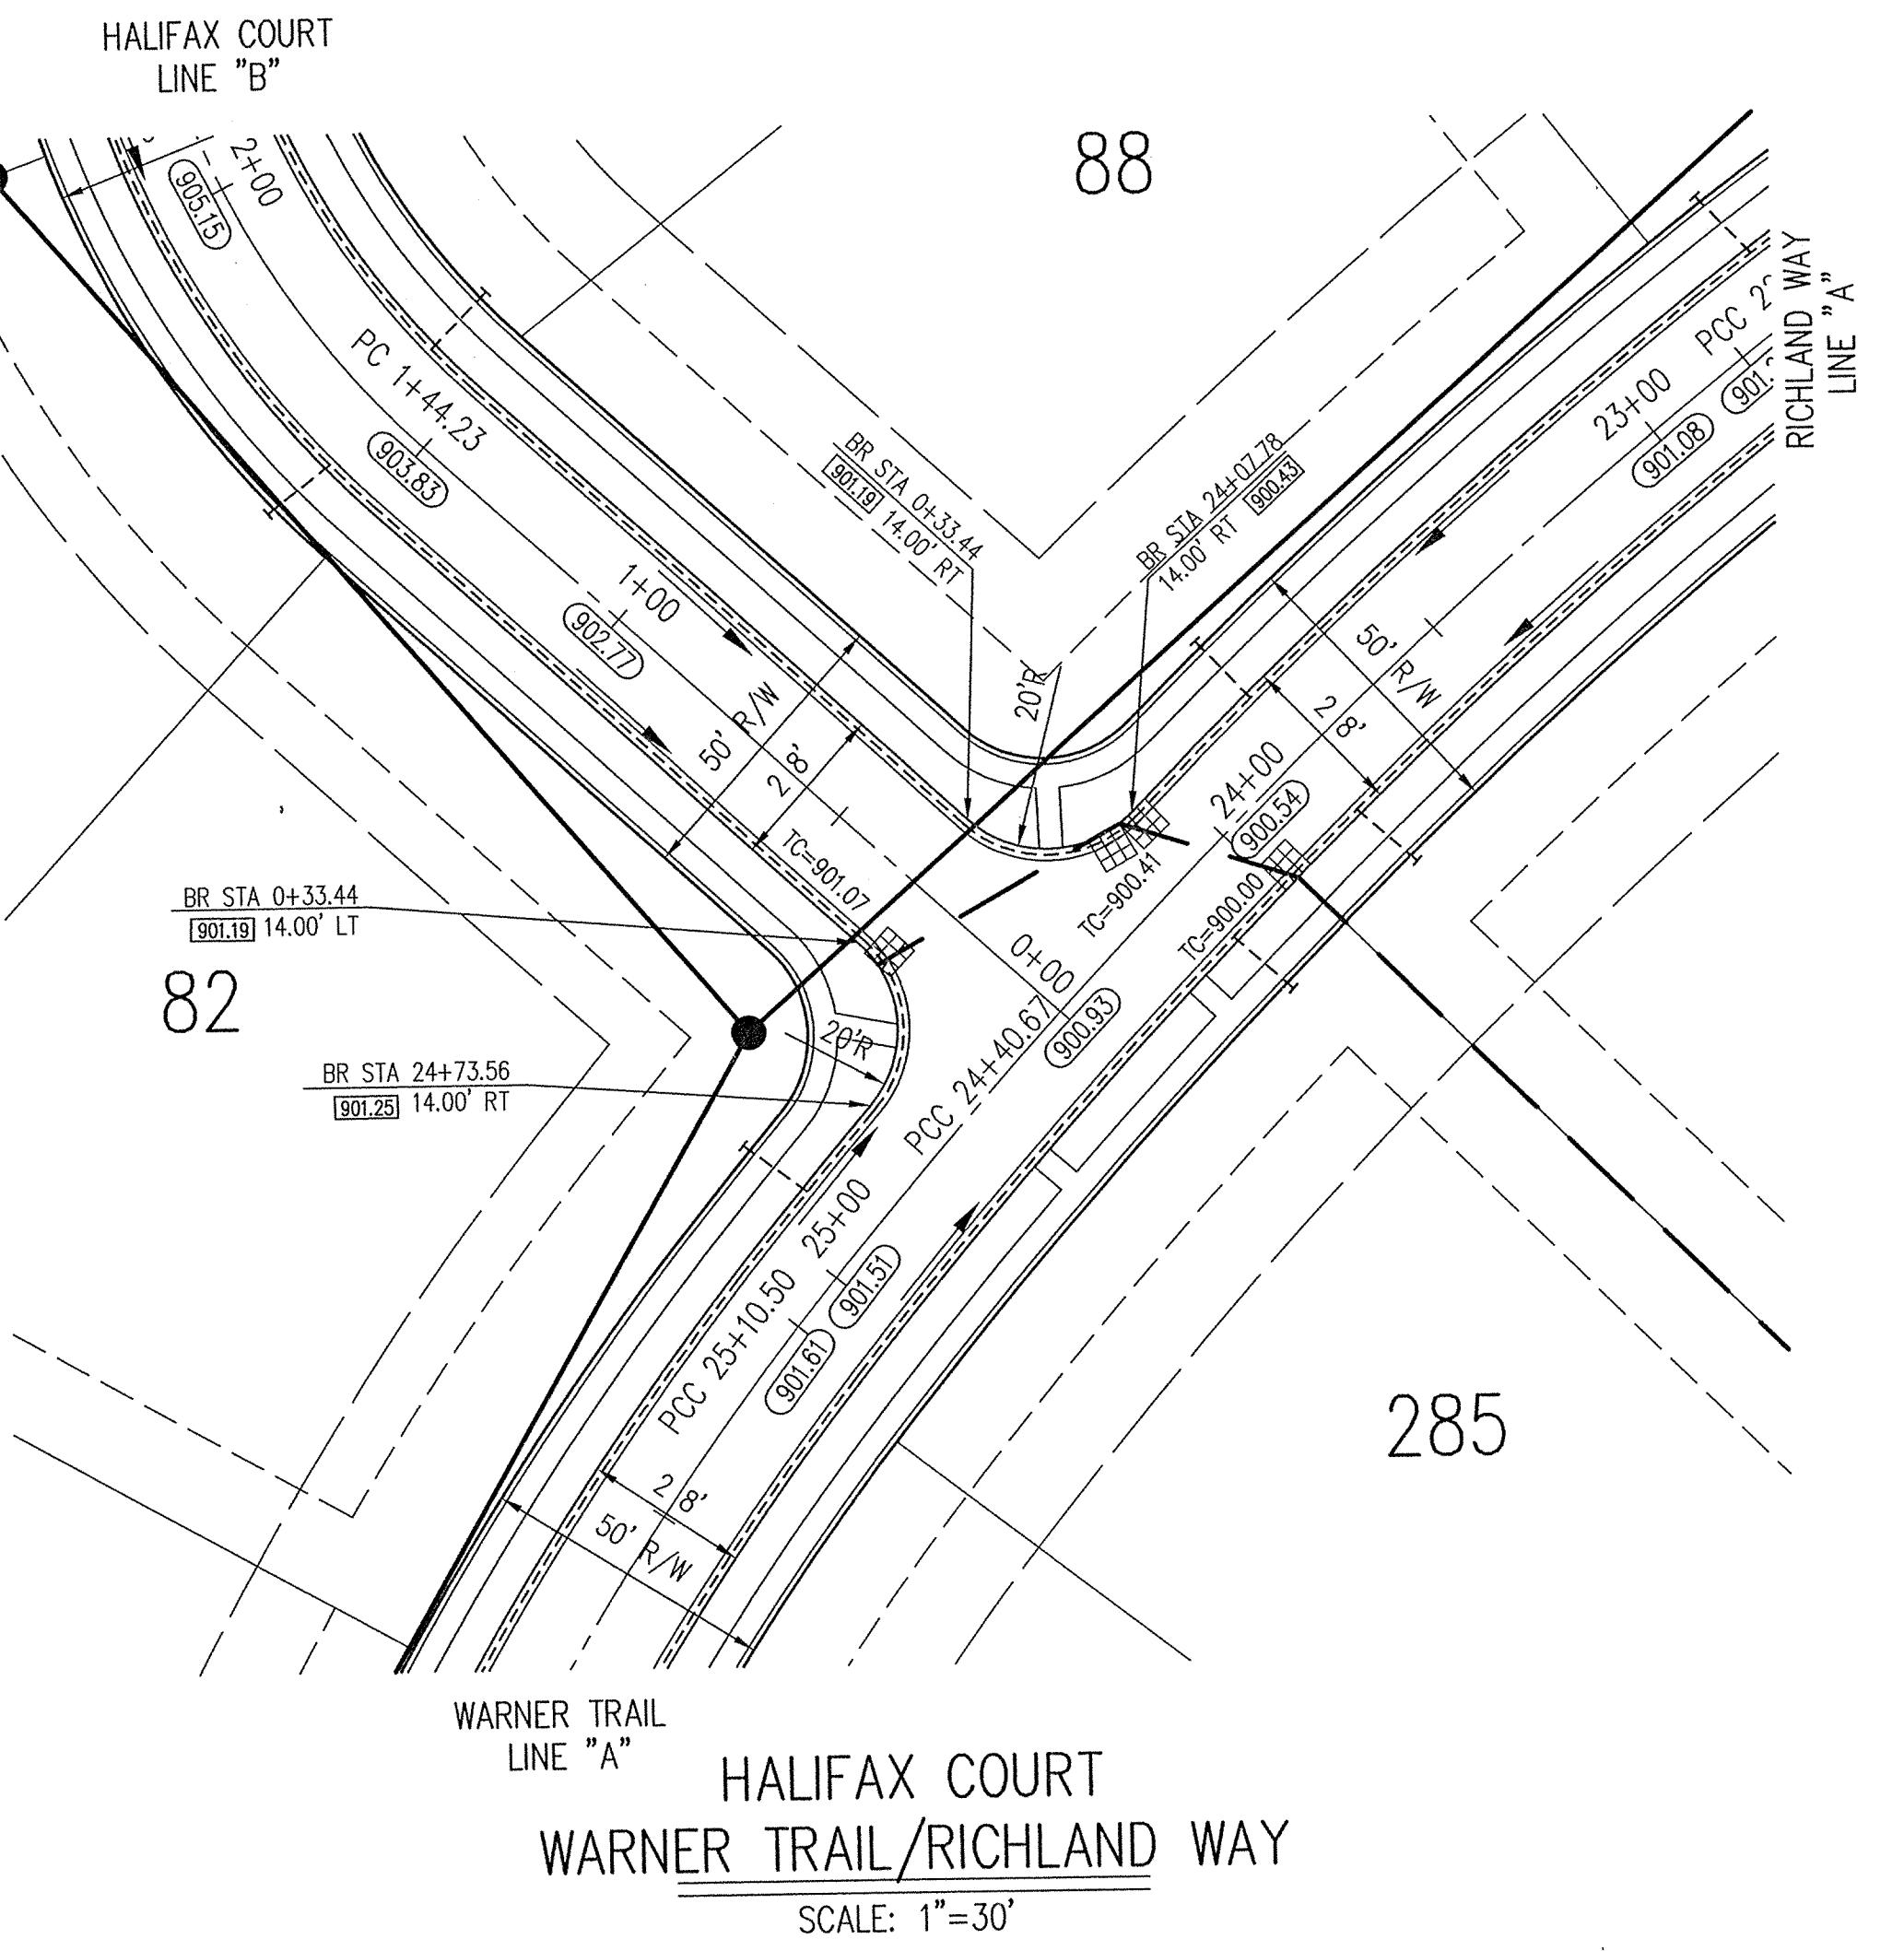
1-800-382-5544

## LEGEND

-  Existing Storm Sewer
-  New Storm Sewer
-  Existing Sanitary Sewer
-  New Sanitary Sewer
-  Existing Contour
-  ELEV DESC
-  Existing Elevation w/ description
-  New Pavement Grade
-  All Other Finish Grades
-  Flow Arrow

REVISIONS:  
1. 10/22/00/01, REVISED PER TAC COMMENTS.

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MERRIMAC  
SECTION 6  
WESTFIELD, INDIANA


FILED  
SEP 12 2001  
OFFICE OF HAMILTON COUNTY SURVEYOR

MERRIMAC CORP.  
CARMEL, INDIANA

DATE: 8/15/01 PROJECT NO.: 1045.004  
DRAWN BY: MG CHECKED BY:  
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CUL-D-E-SAC DETAILS  
DRAWING FILES:  
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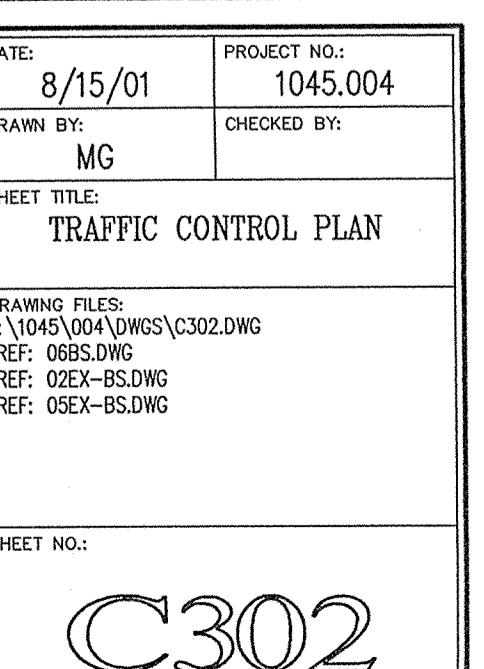
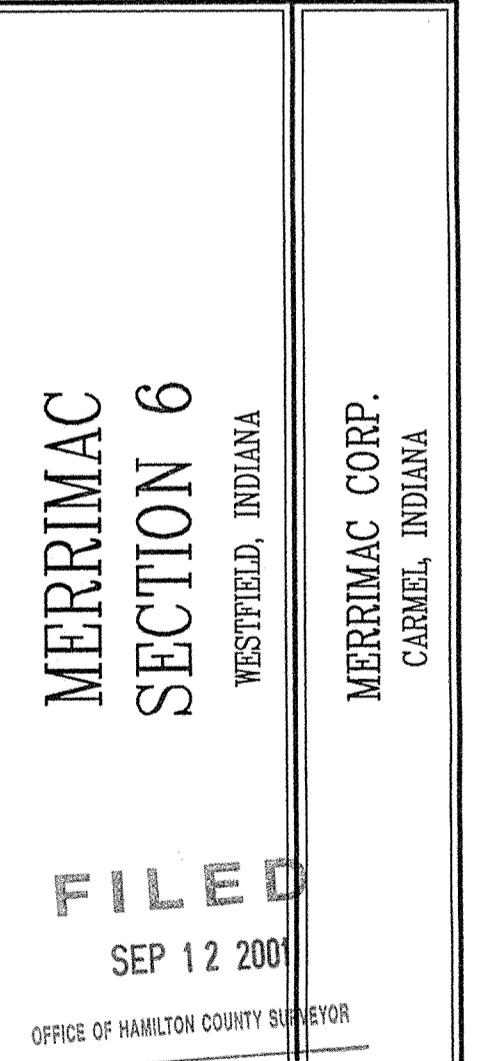
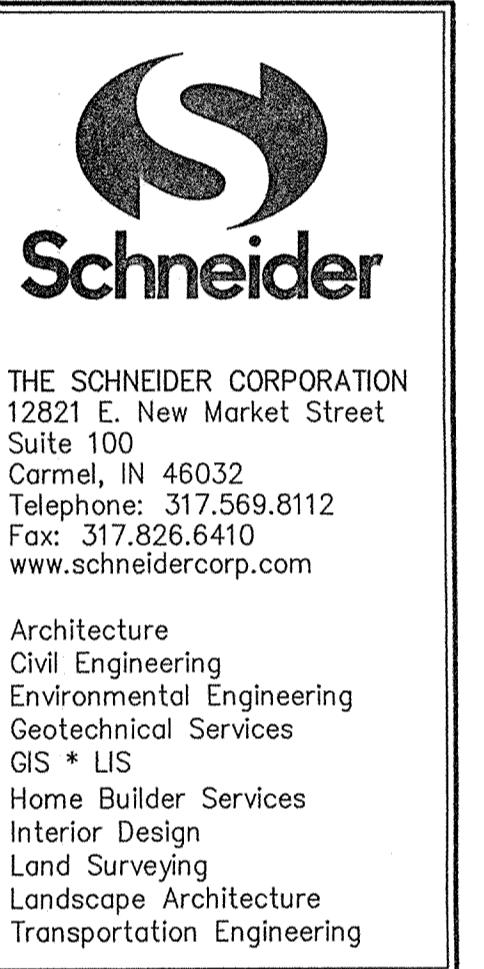
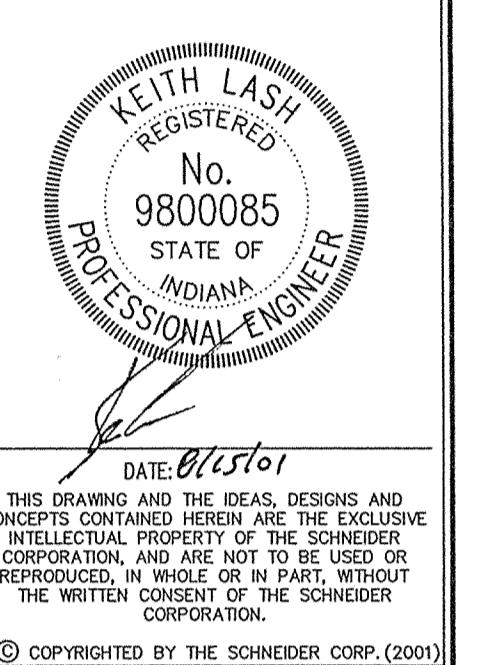
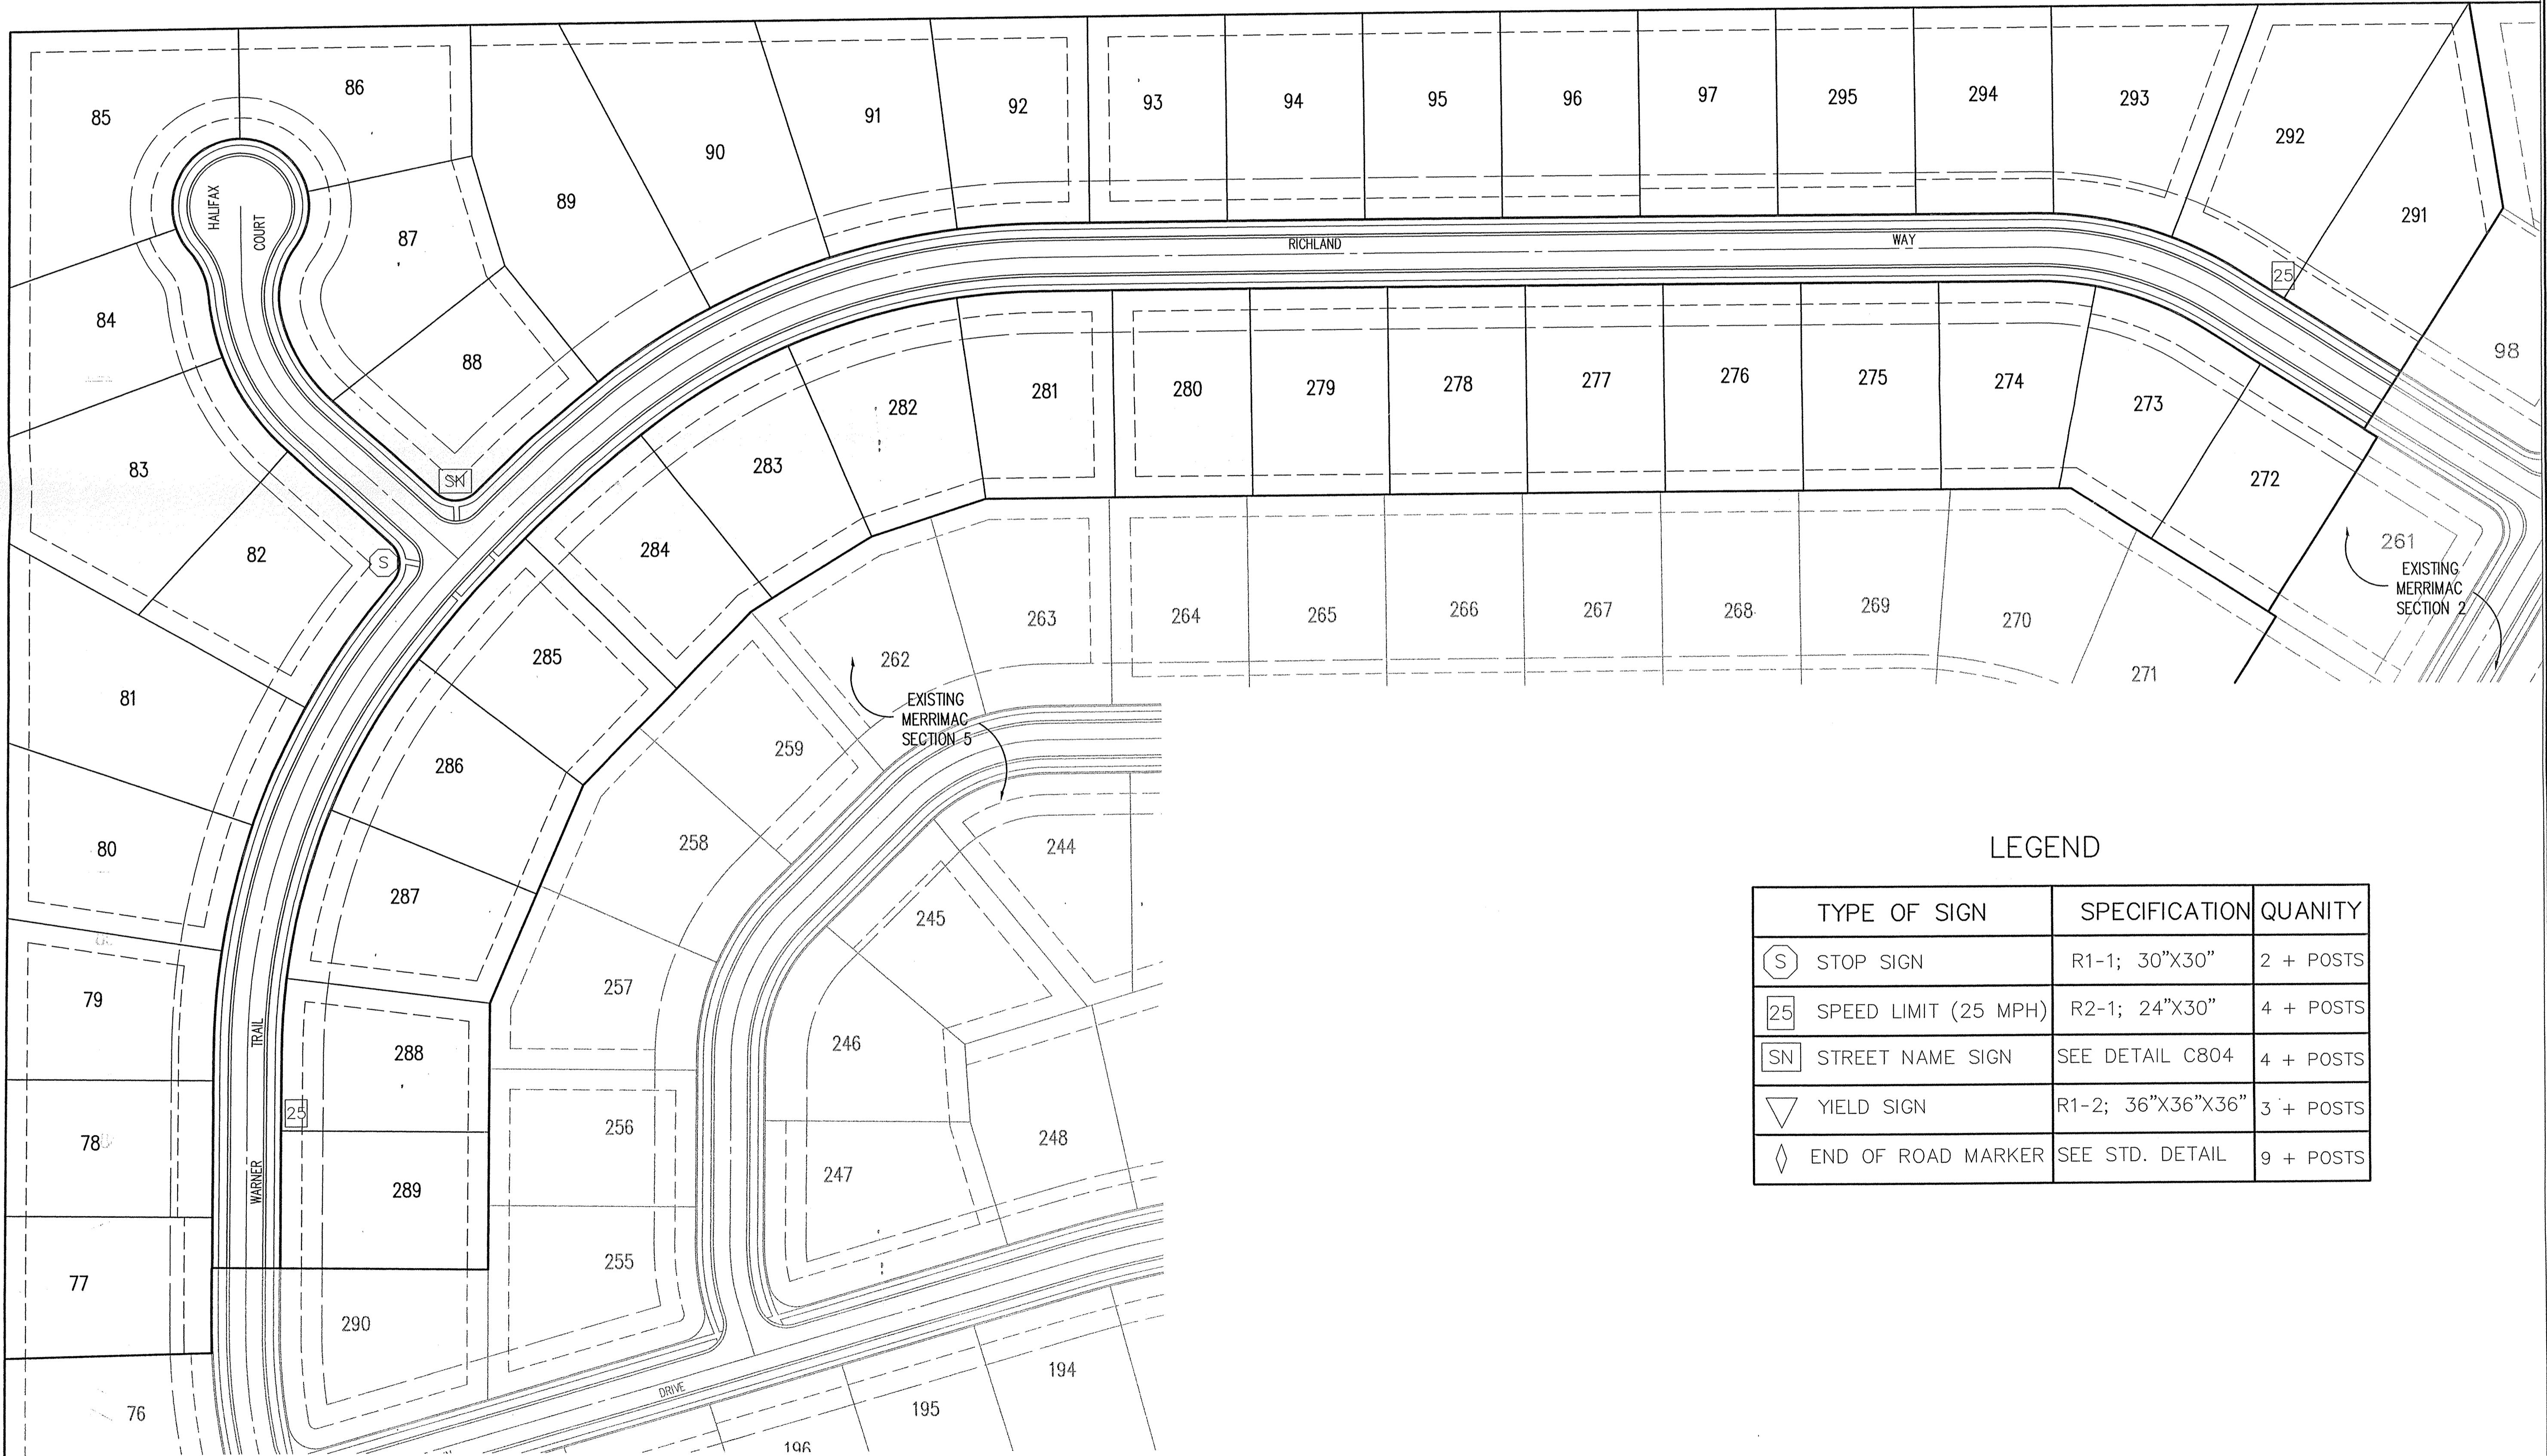
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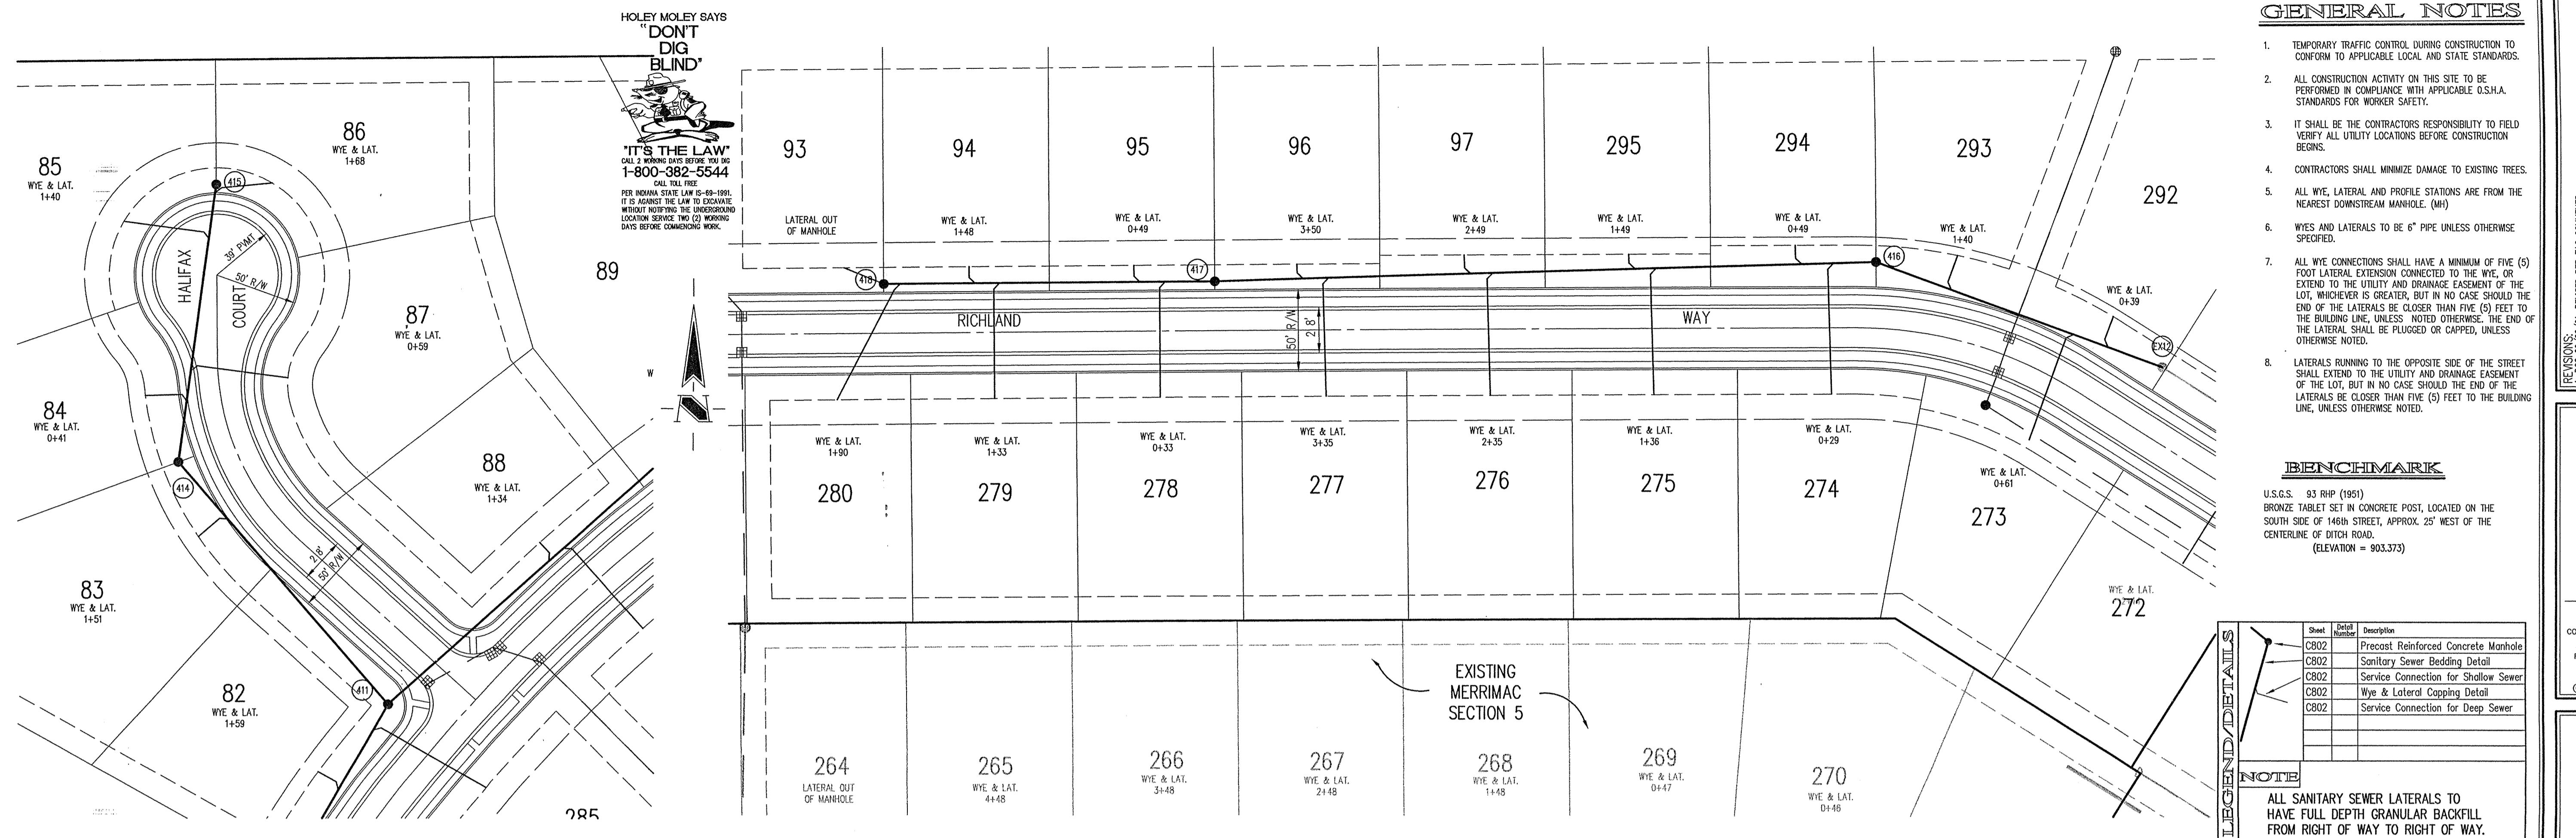


ASSUMED NORTH  
SCALE: 1"=60'

REVISIONS:  
1. DCC 09/06/01, REVISED PER TAC COMMENTS.

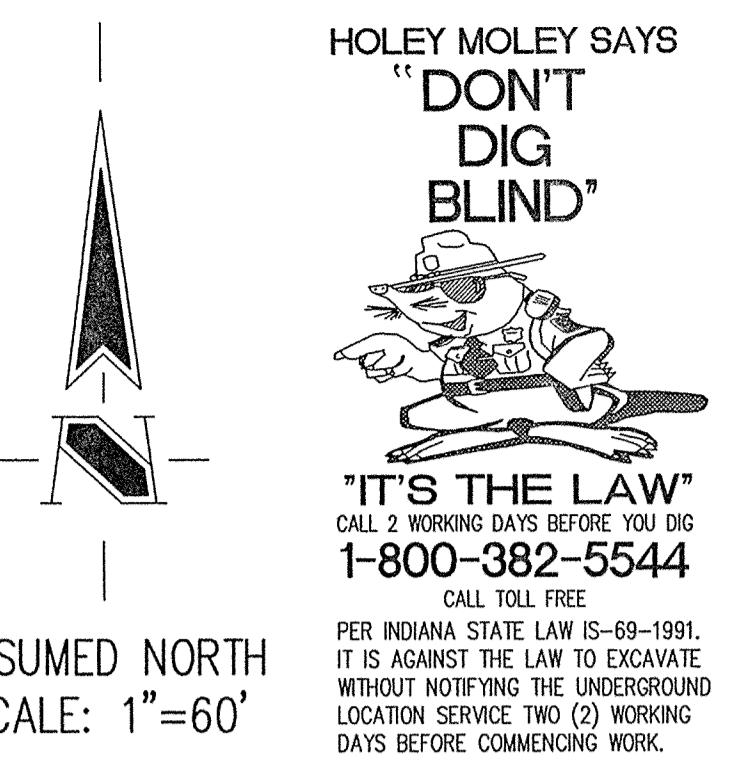






# SANITARY SEWER PLAN

SCALE: 1"=50'

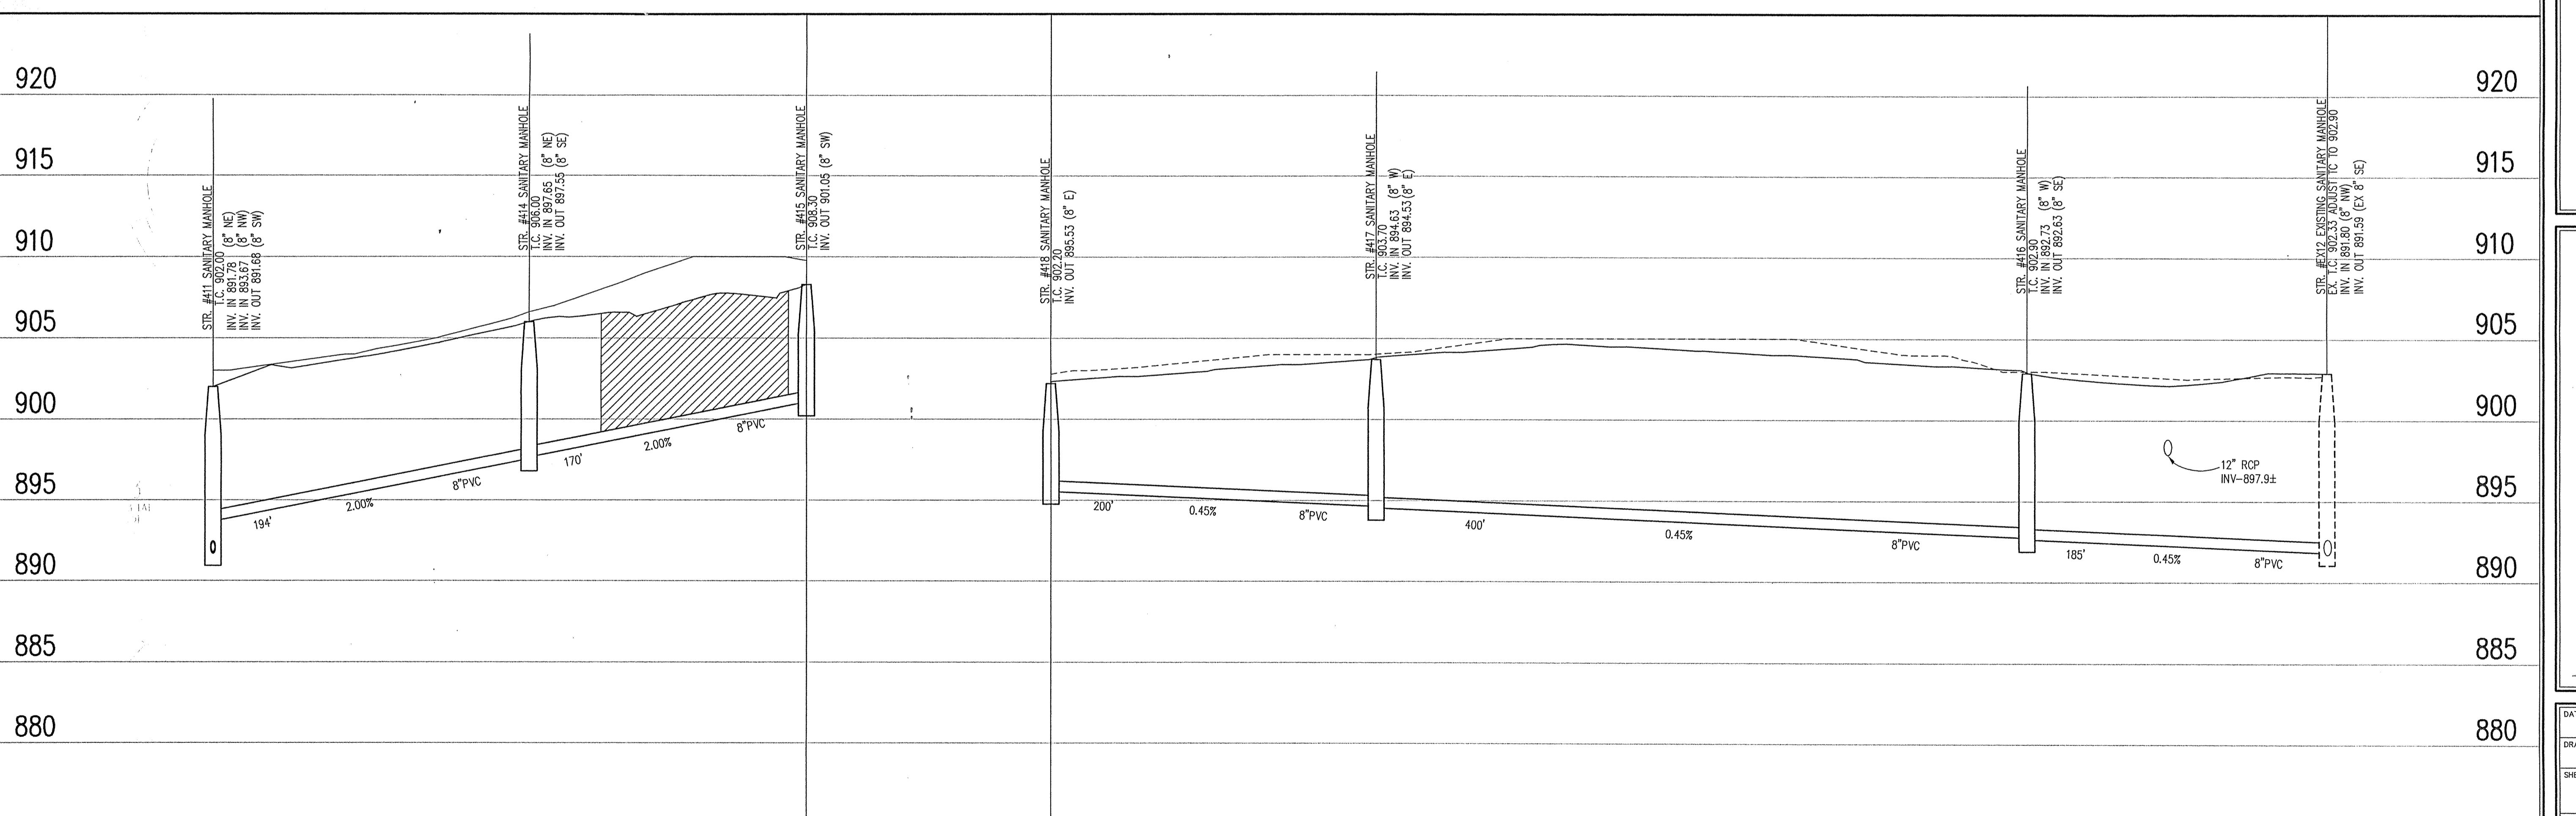

# SANITARY SEWER PROFILE

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A legend box containing three entries: 'Existing Grade' with a dashed line symbol, 'New Grade' with a solid line symbol, and 'Granular Backfill' with a diagonal hatching symbol.

SCALE: HORZ.: 1"=50'  
VERT: 1"=5'

SHEET NO.: **C102**


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8/15/01	1045.004
DRAWN BY:	CHECKED BY:
DCC	
SHEET TITLE:	
SANITARY SEWER PLAN & PROFILE	

MERRIMAC SECTION 6  
WESTFIELD, INDIANA


FILED  
SEP 12 2001

DATE: 8/15/01	PROJECT NO.: 1045.004
DRAWN BY: DCC	CHECKED BY:
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SHEET NO.:  
**C402**

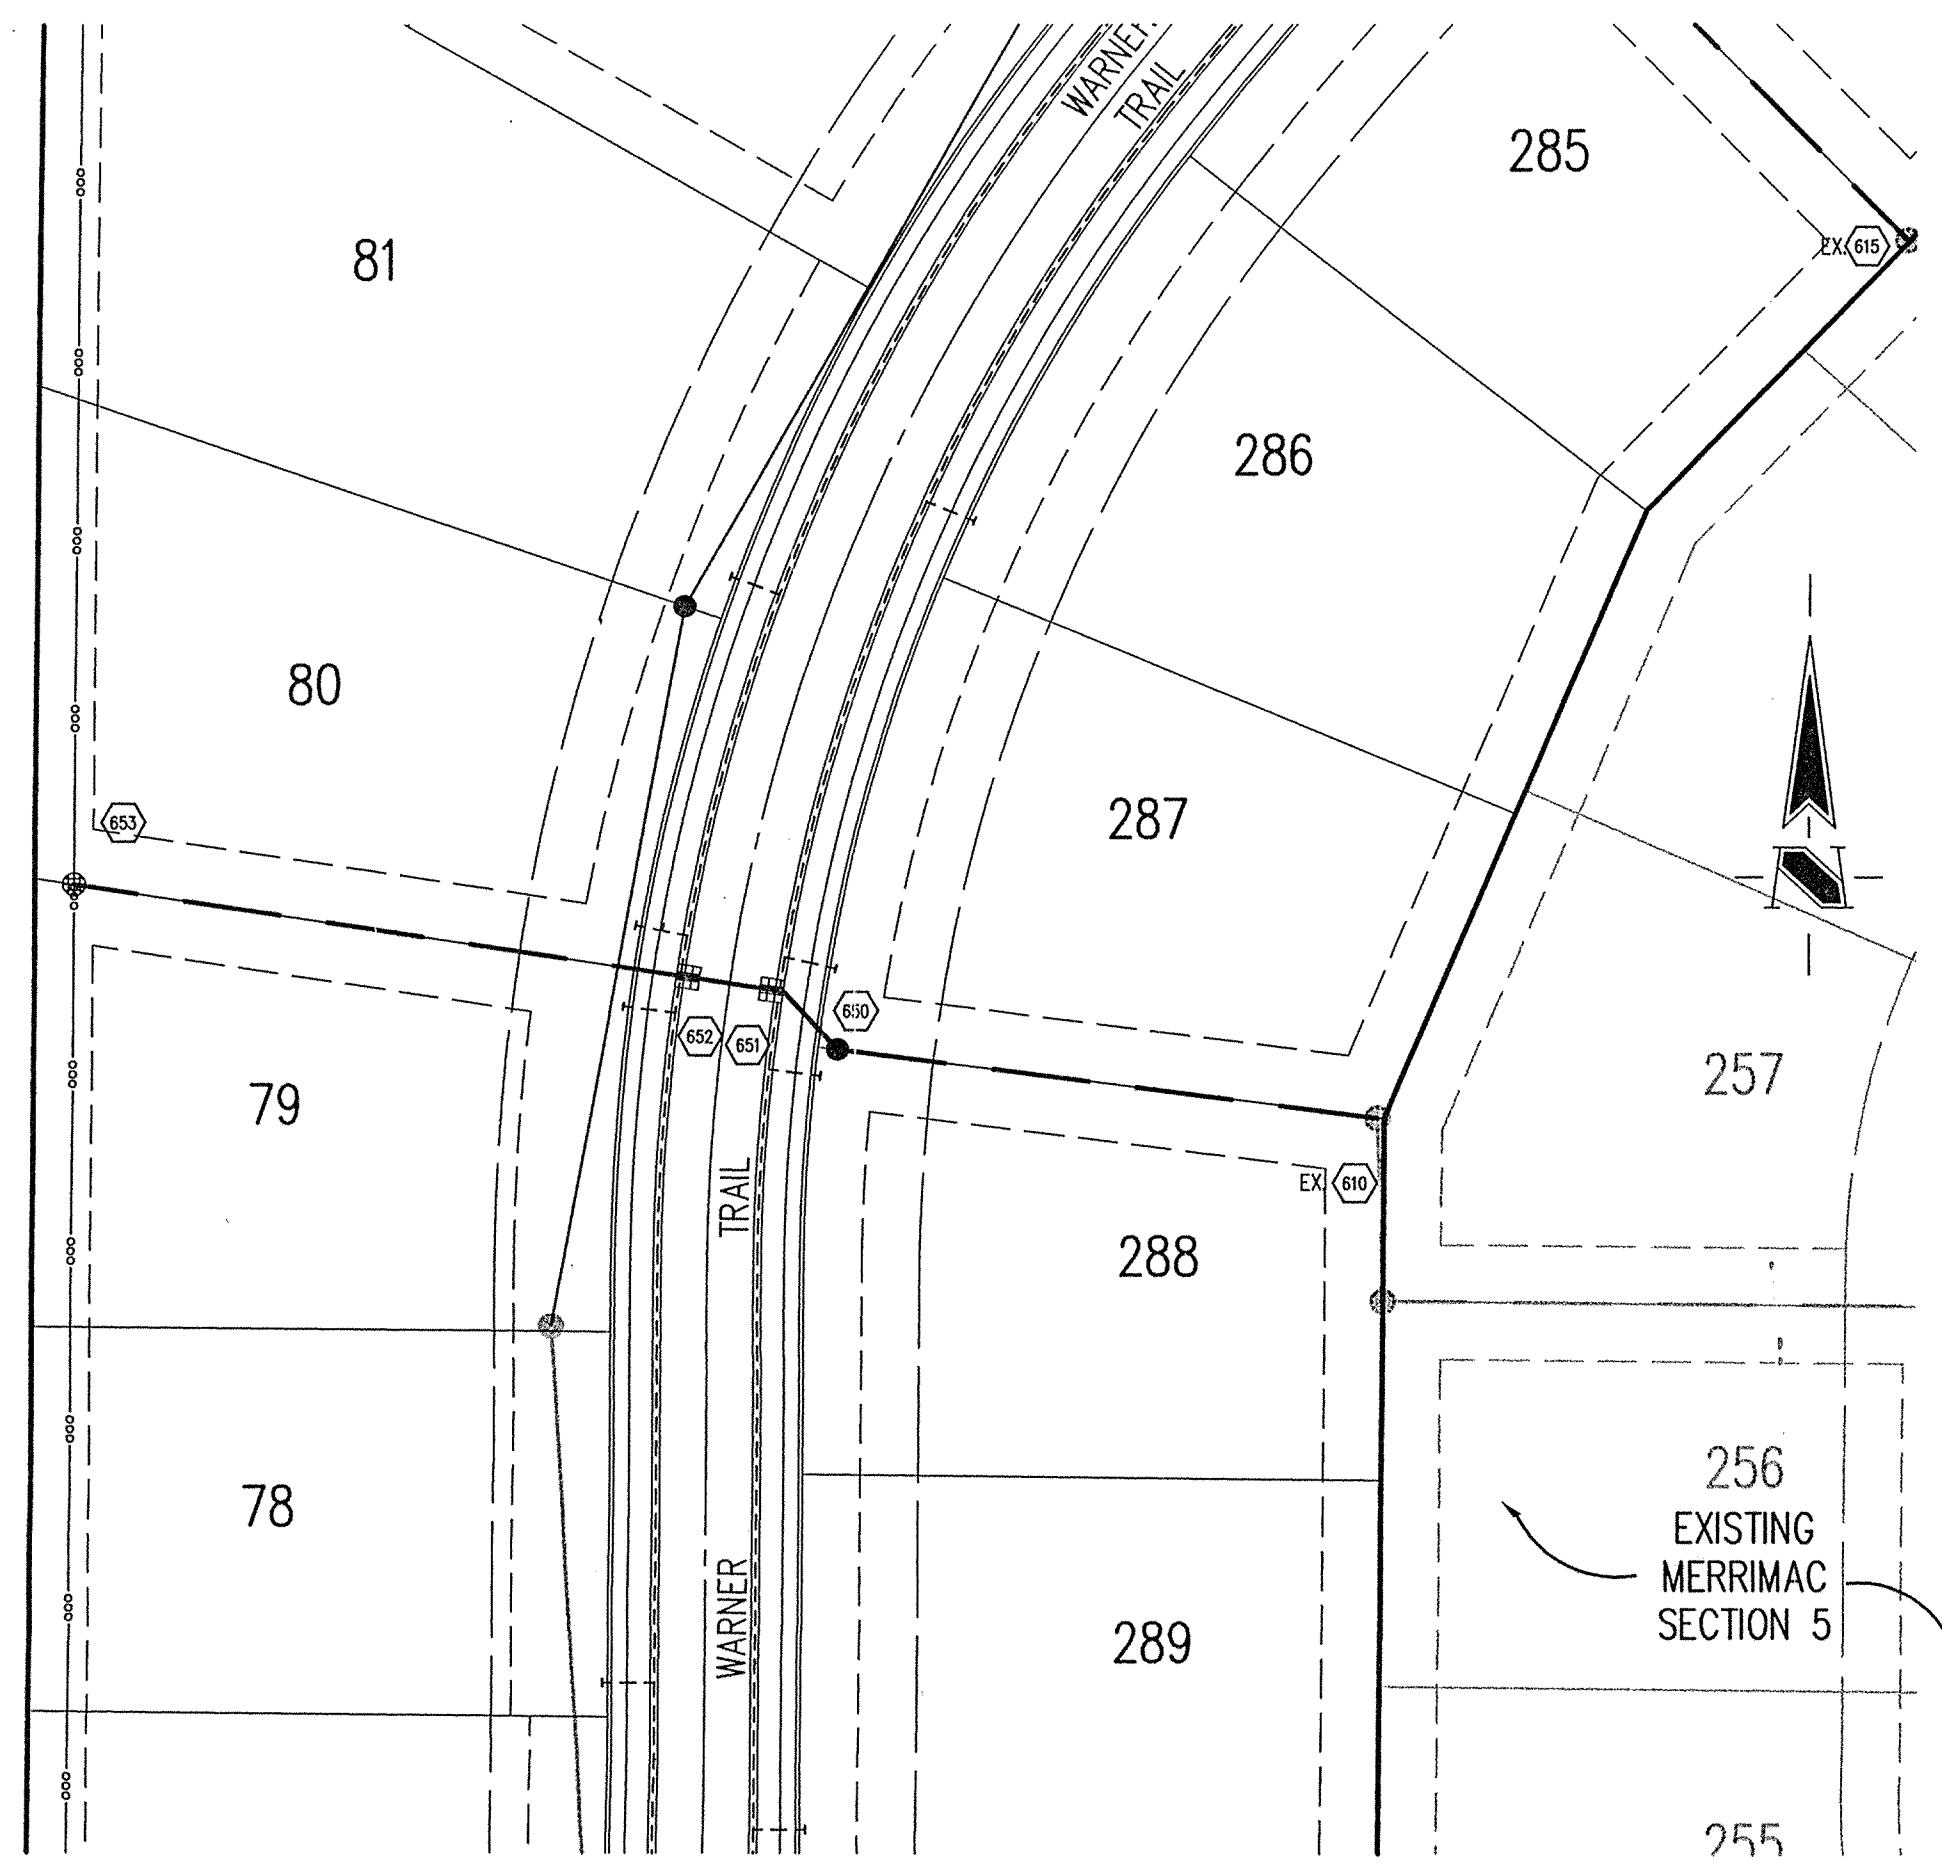


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"IT'S THE LAW"  
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1-800-382-5544  
CALL TOLL FREE  
PER INDIANA STATE LAW IS-69-1991.  
IT IS AGAINST THE LAW TO EXCAVATE  
WITHOUT NOTIFYING THE UNDERGROUND  
LOCATION SERVICE TWO (2) WORKING  
DAYS BEFORE COMMENCING WORK.

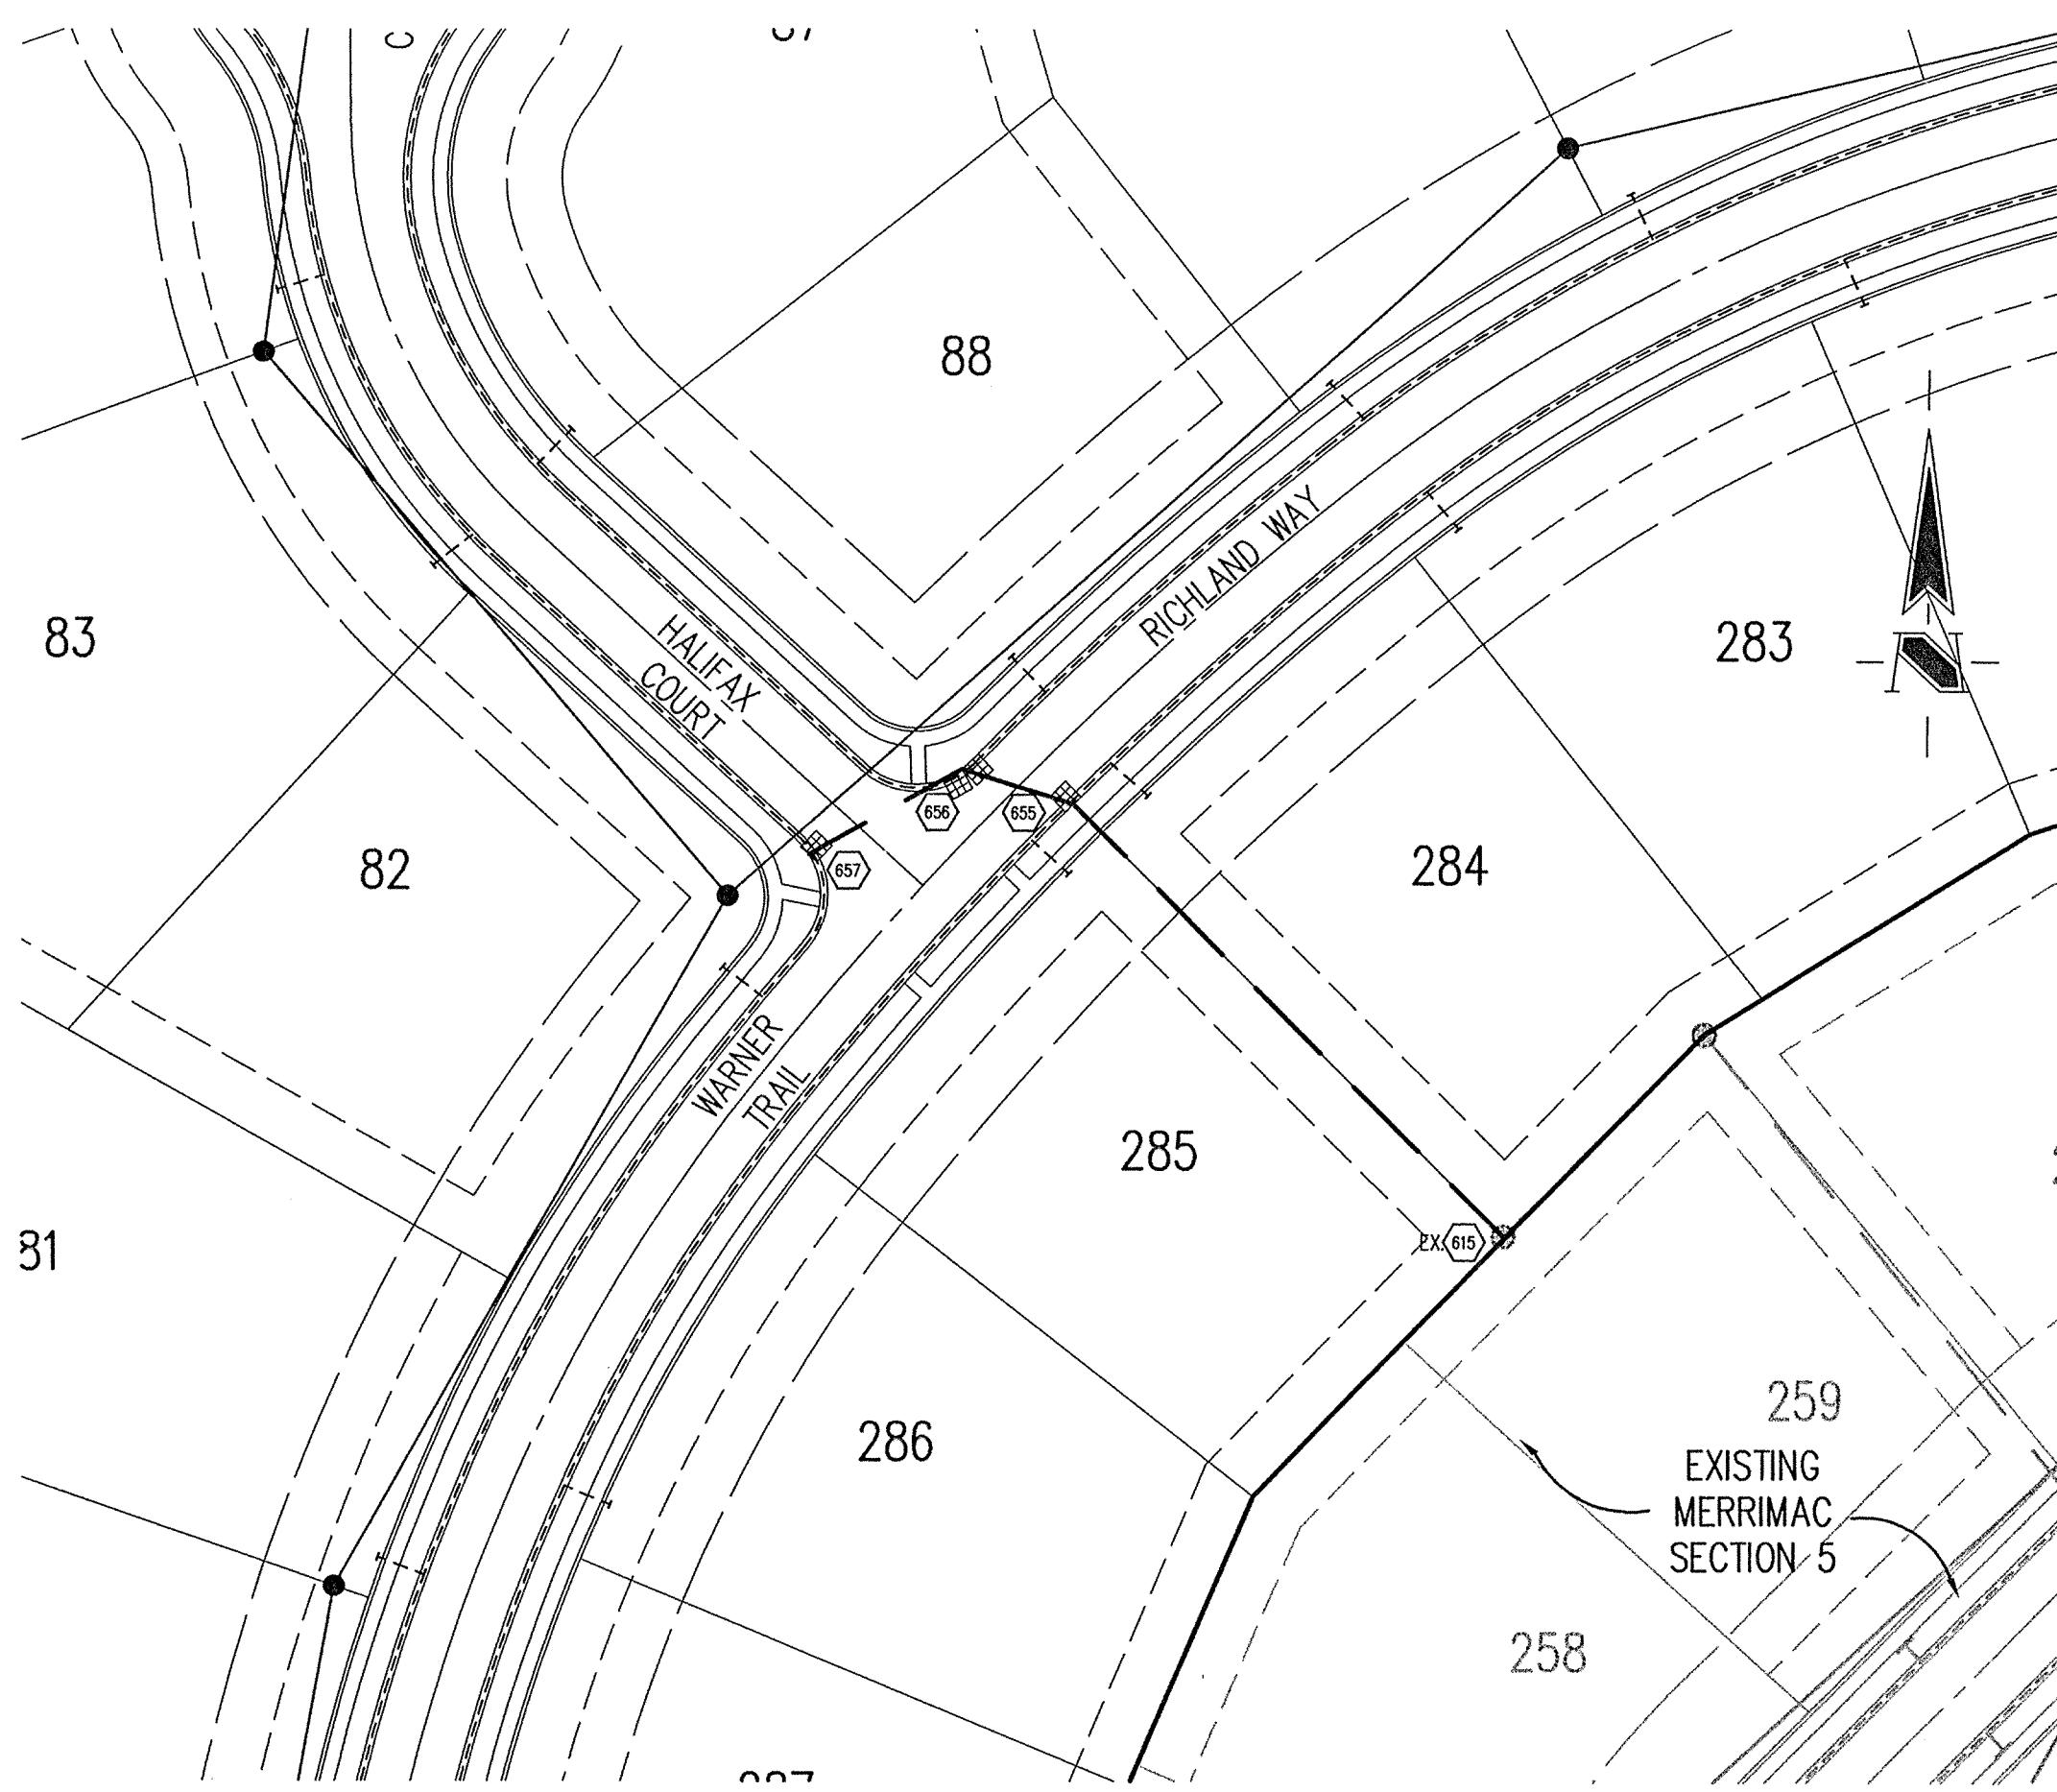


#### GENERAL NOTES

1. TEMPORARY TRAFFIC CONTROL DURING CONSTRUCTION TO CONFORM TO APPLICABLE LOCAL AND STATE STANDARDS.
2. ALL CONSTRUCTION ACTIVITY ON THIS SITE TO BE PERFORMED IN COMPLIANCE WITH APPLICABLE O.S.H.A. STANDARDS FOR WORKER SAFETY.
3. IT SHALL BE THE CONTRACTORS RESPONSIBILITY TO FELD VERIFY ALL UTILITY LOCATIONS BEFORE CONSTRUCTION BEGINS.
4. CONTRACTORS SHALL MINIMIZE DAMAGE TO EXISTING TREES.

REVISIONS:  
1.000 06/16/01, REvised per TAG comments.

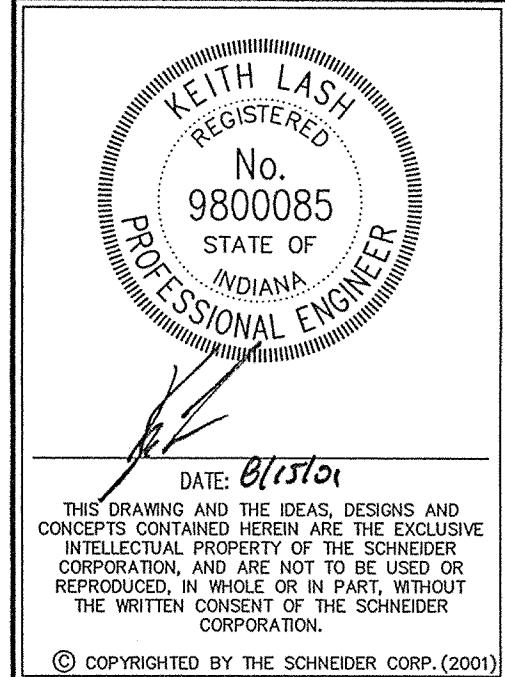

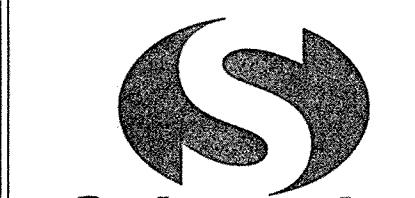  
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**MERRIMAC SECTION 6**  
WESTFIELD, INDIANA  
MERRIMAC CORP.  
CARMEL, INDIANA


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SEP 12 2001  
OFFICE OF HAMILTON COUNTY SURVEYOR

DATE: 8/15/01 PROJECT NO.: 1045.004  
DRAWN BY: MG CHECKED BY:  
SHEET TITLE: STORM SEWER PLAN & PROFILE  
DRAWING FILES: N:\VADSO\DWG\CS01-602.DWG  
XREF: GDS.DWG  
XREF: O2EX-BS.DWG  
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XREF: STORM.DWG

SCALE: HORIZ.: 1"=50'  
VERT.: 1"=5'  
**C601**


## STORM SEWER PLAN

SCALE: 1"=50'


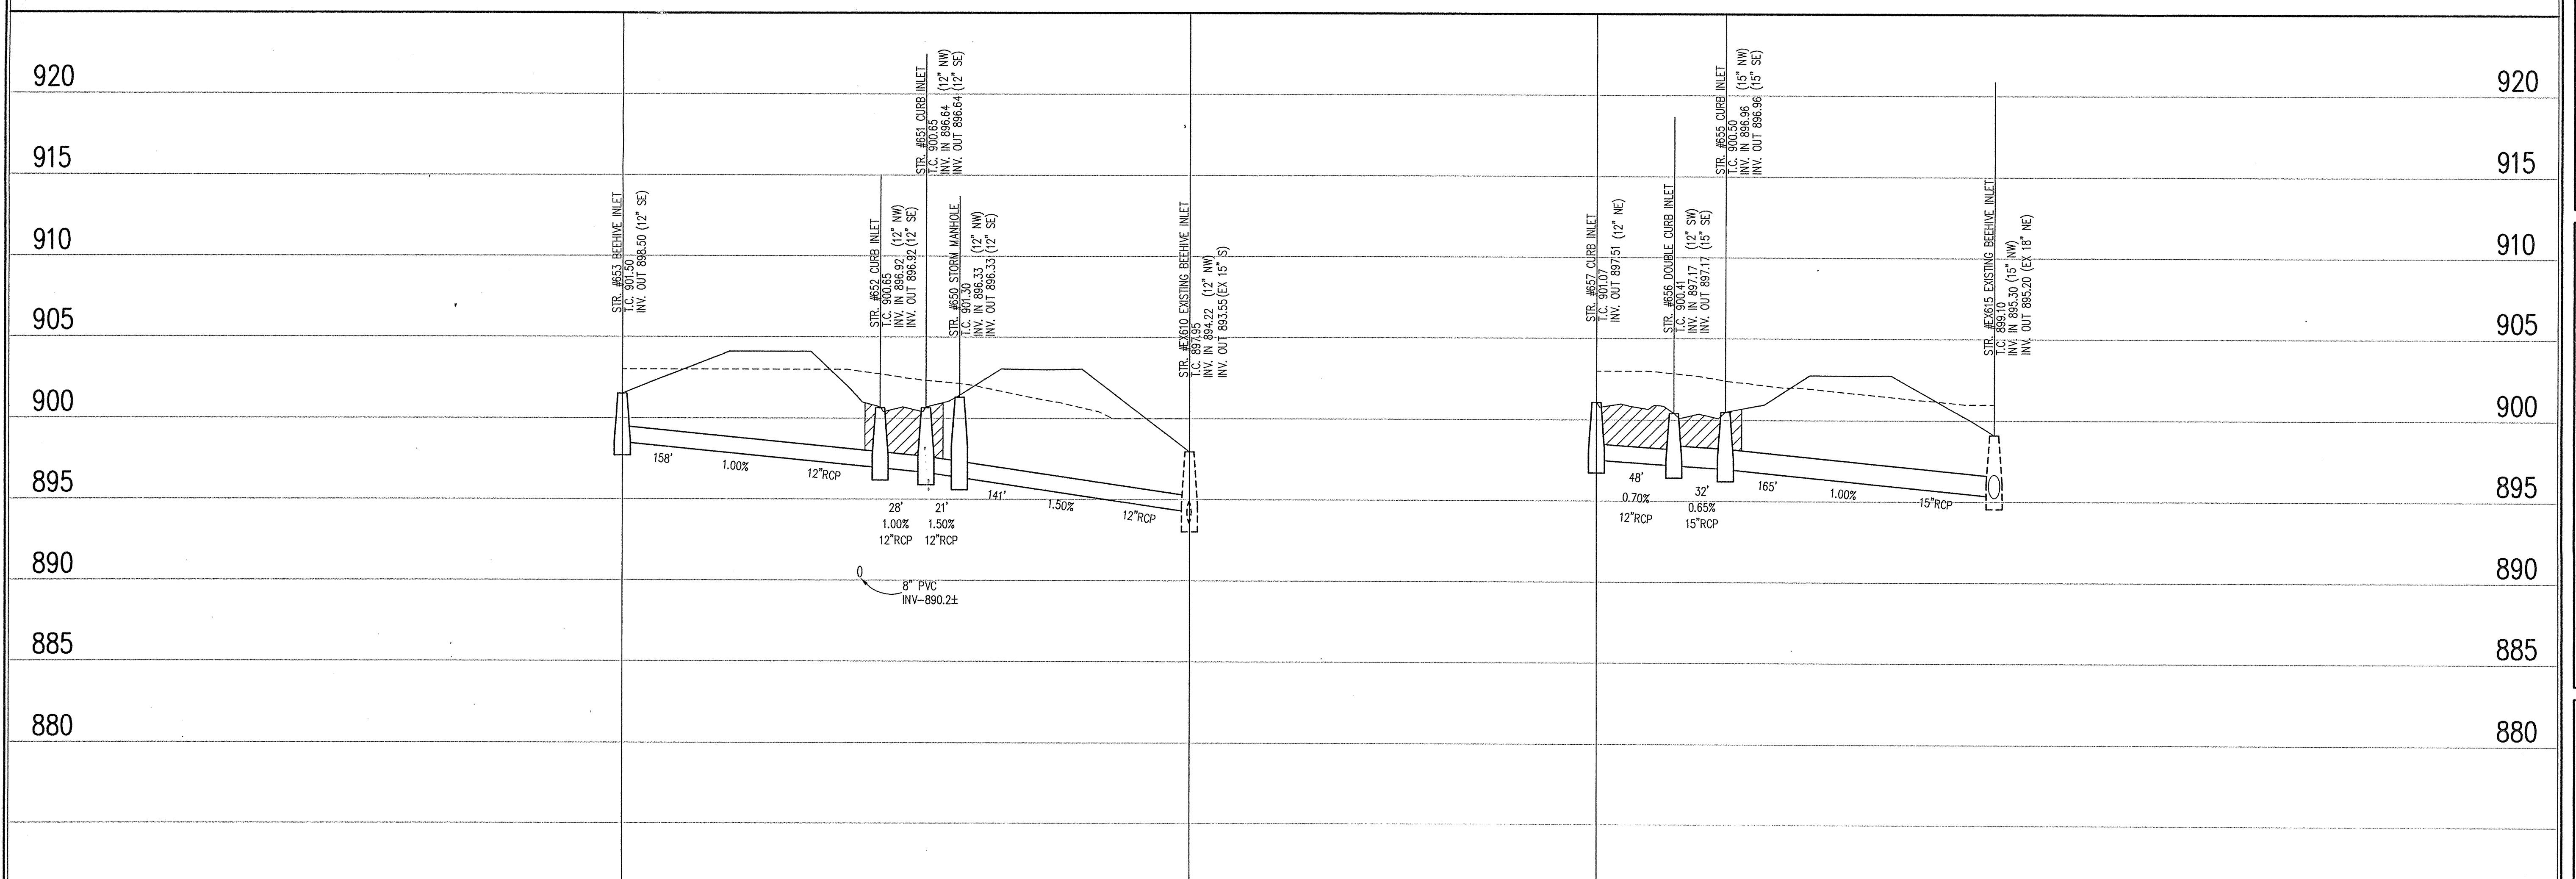


## STORM SEWER PROFILE

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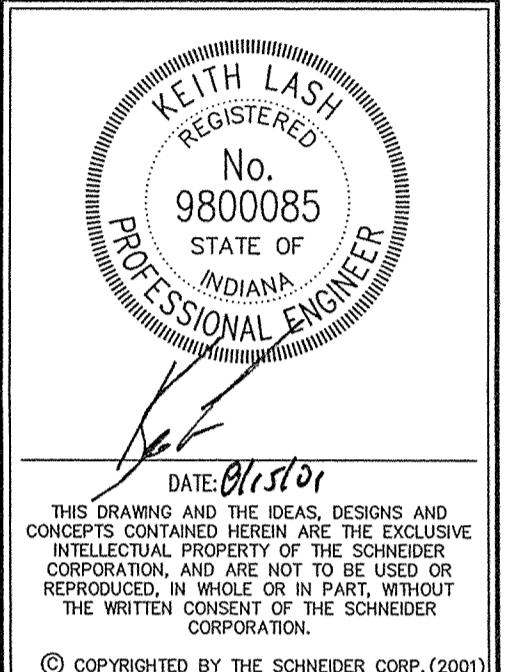
SCALE: HORIZ.: 1"=50'  
VERT.: 1"=5'

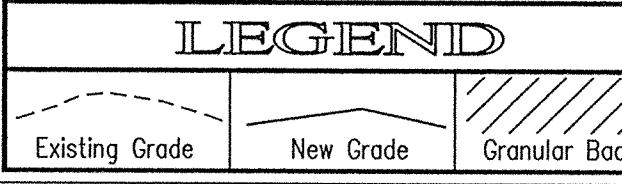

### GENERAL NOTES
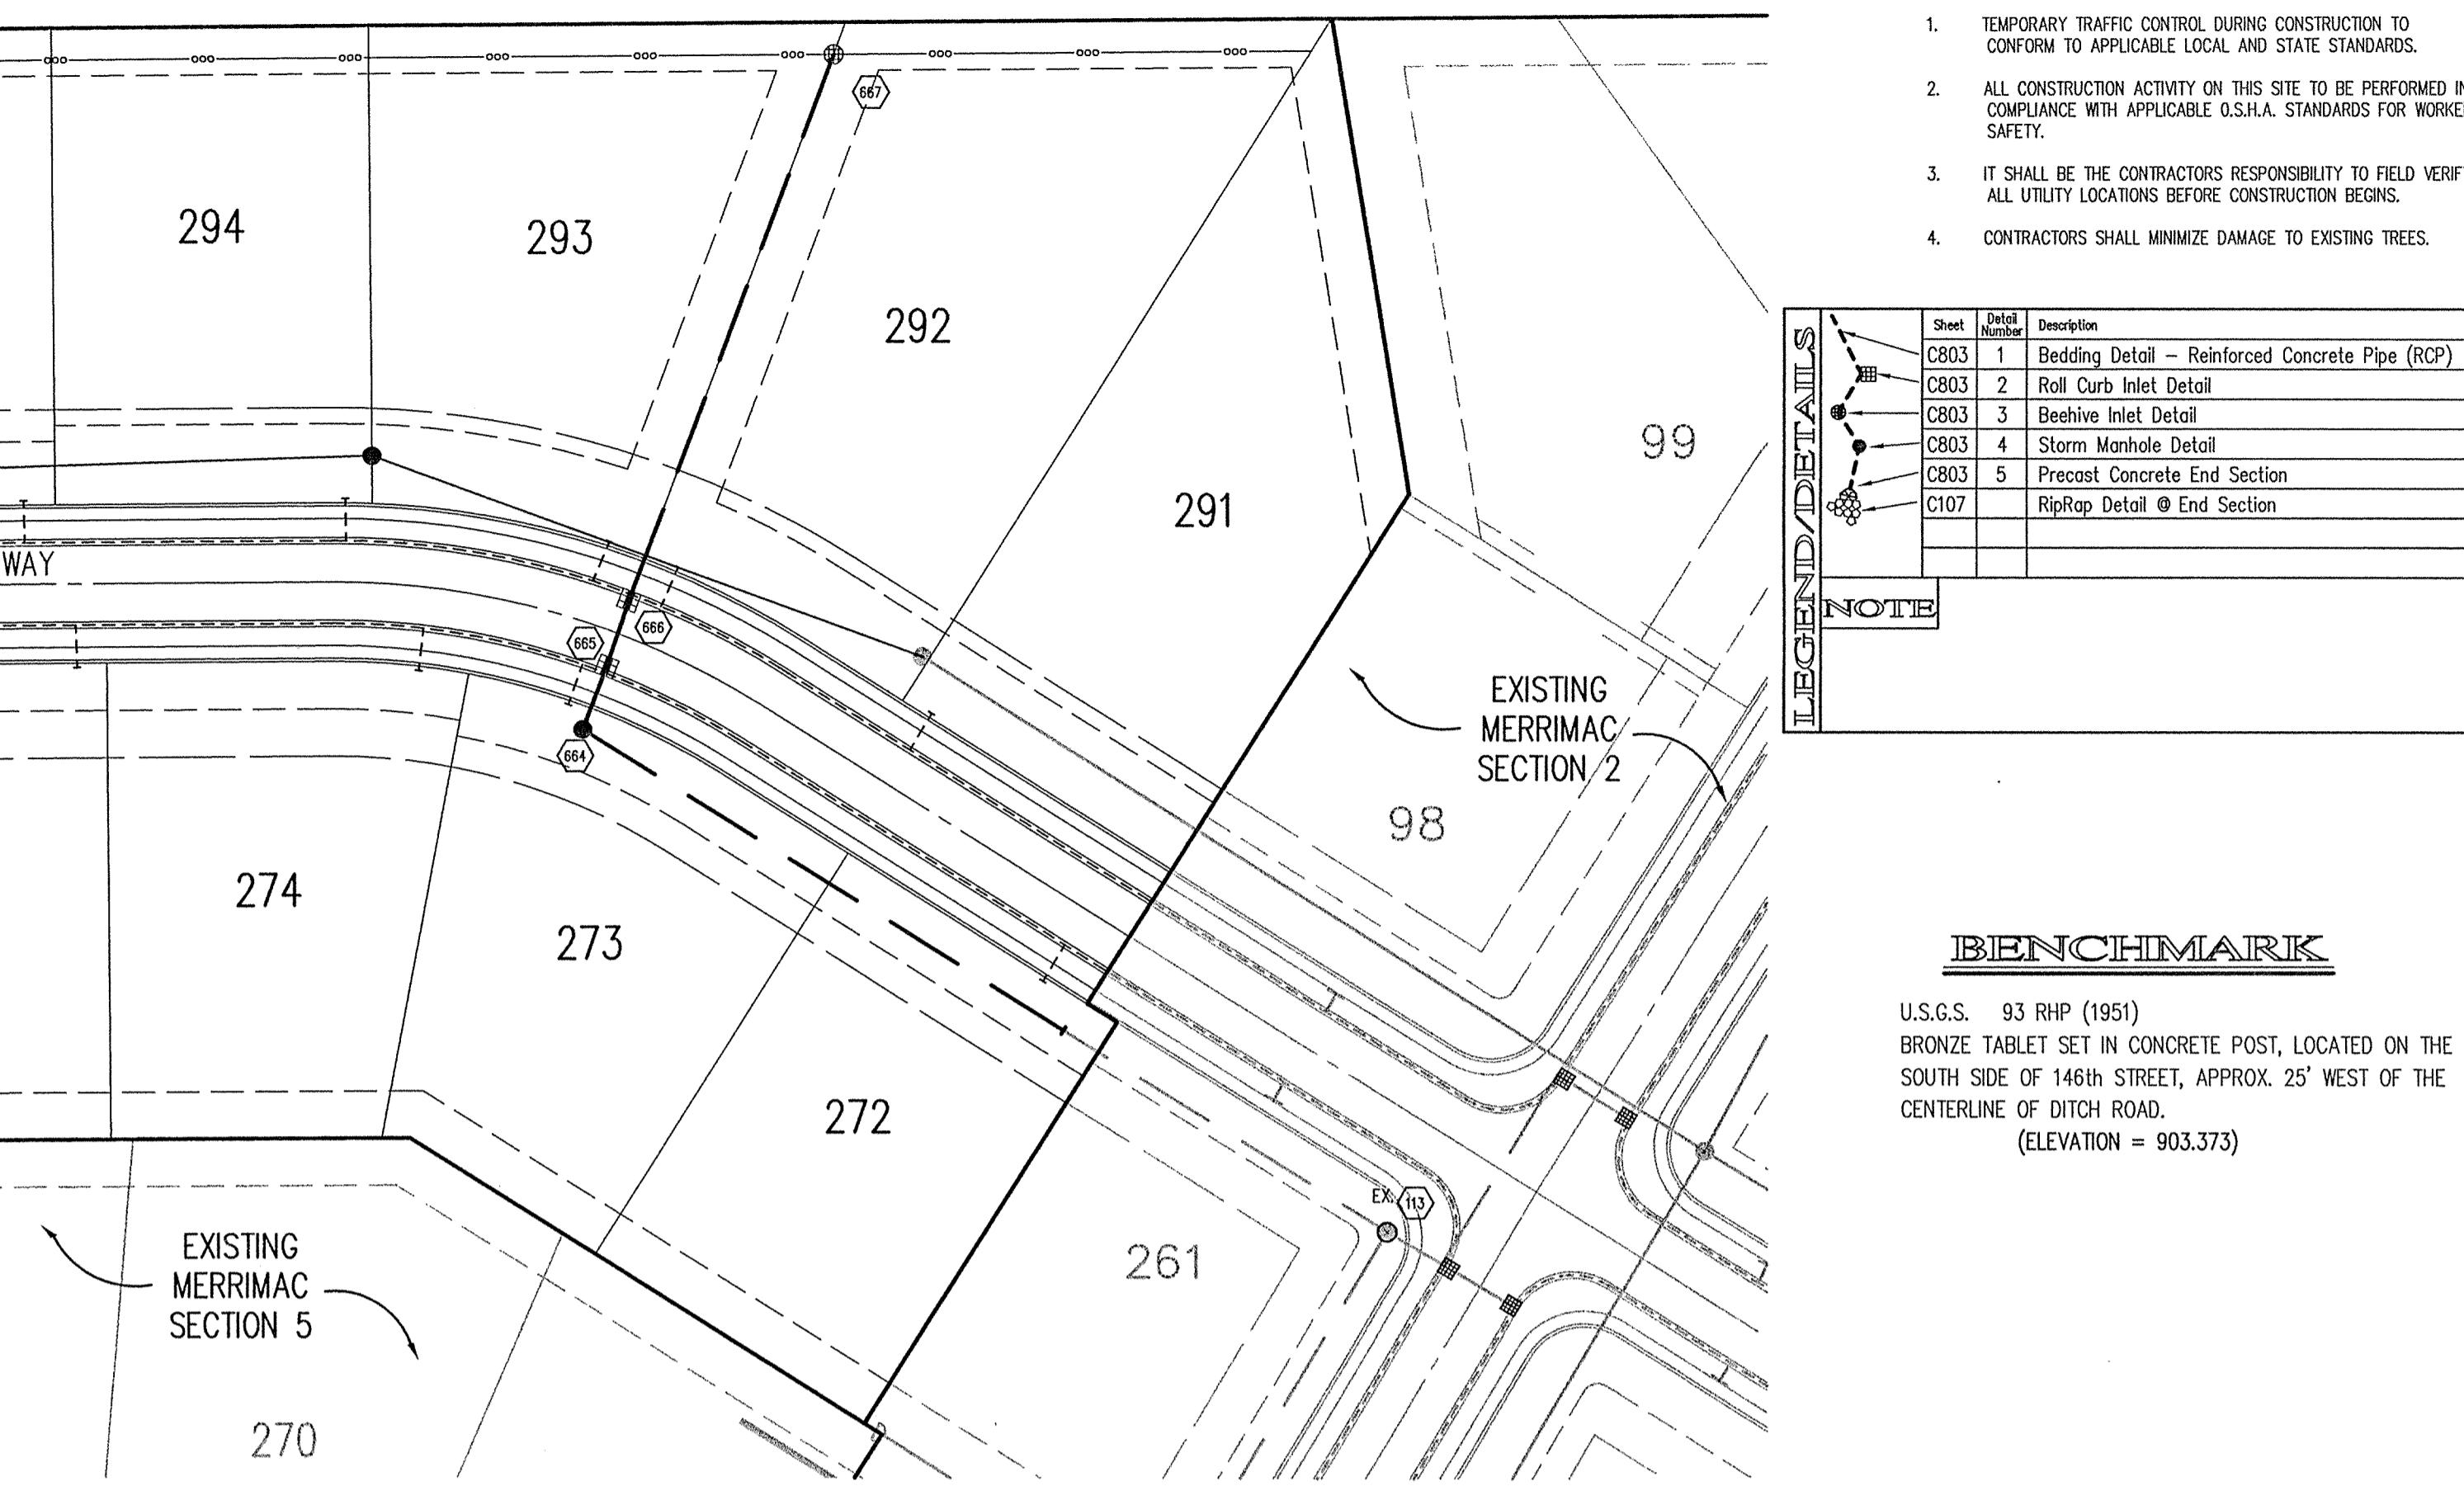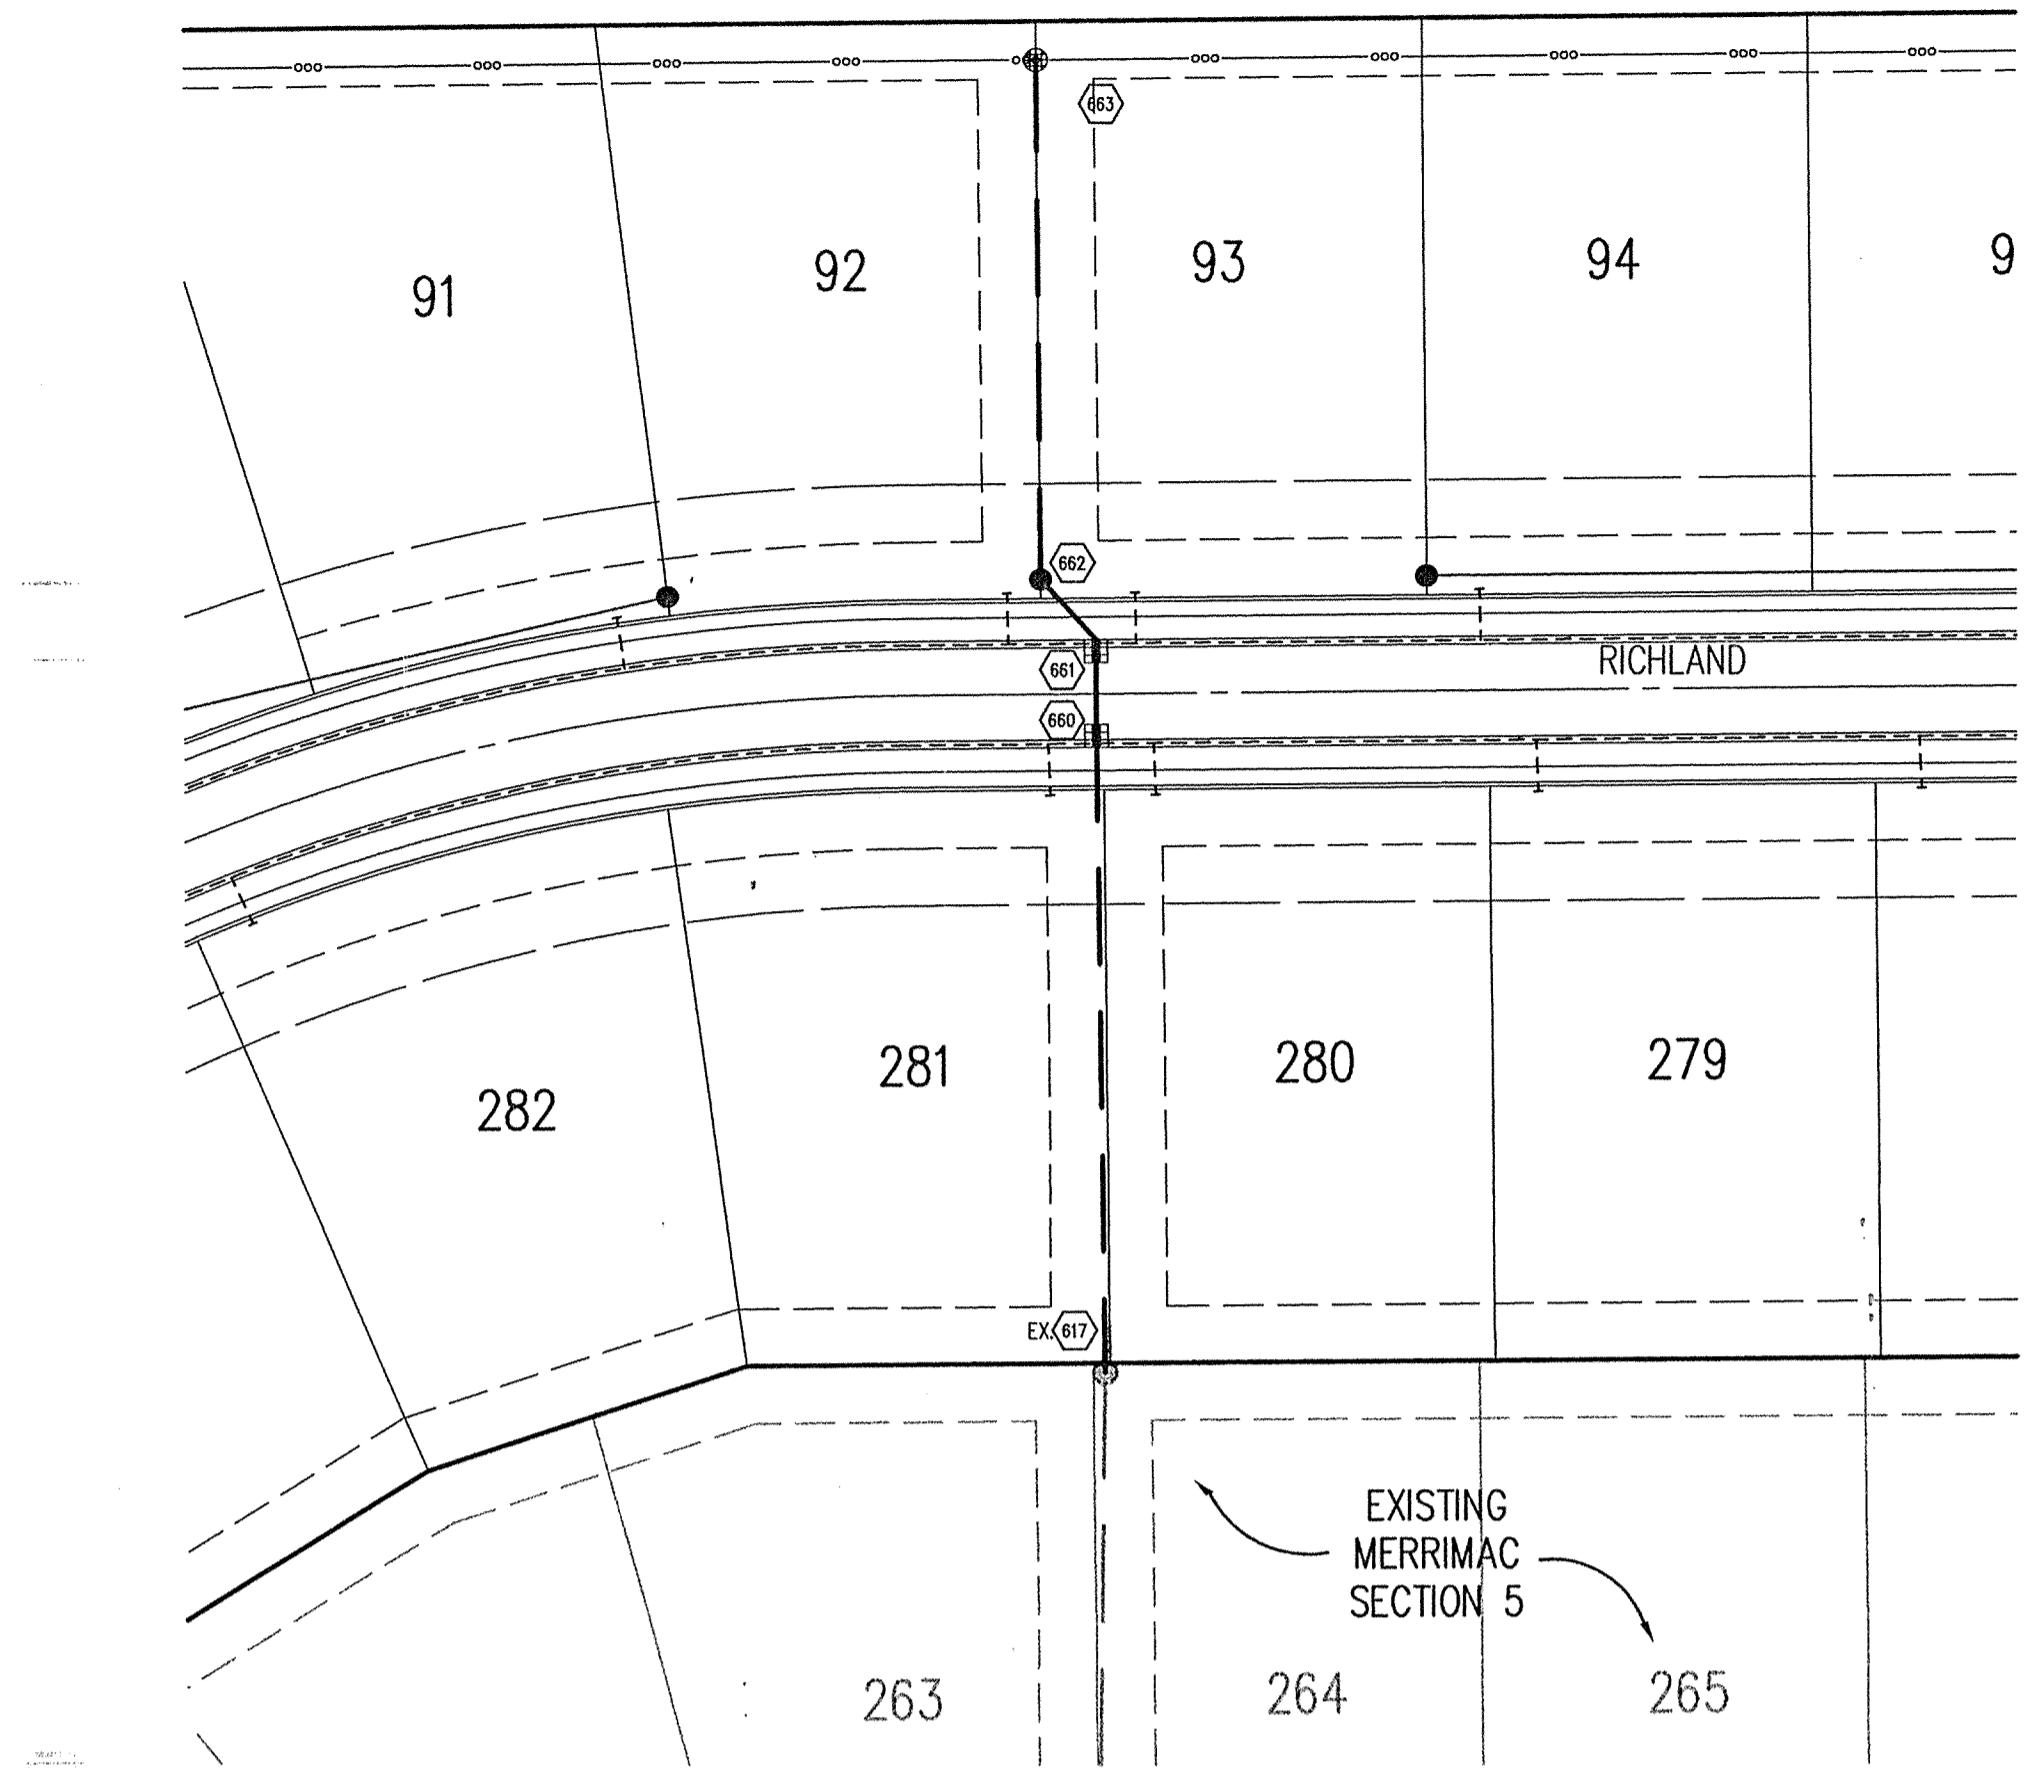
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2. ALL CONSTRUCTION ACTIVITY ON THIS SITE TO BE PERFORMED IN COMPLIANCE WITH APPLICABLE O.S.H.A. STANDARDS FOR WORKER SAFETY.
3. IT SHALL BE THE CONTRACTORS RESPONSIBILITY TO FIELD VERIFY ALL UTILITY LOCATIONS BEFORE CONSTRUCTION BEGINS.
4. CONTRACTORS SHALL MINIMIZE DAMAGE TO EXISTING TREES.

REVISIONS:  
1. DEC 18/01, REVISED FOR TAC COMMENTS.



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12821 E. New Market Street  
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Carmel, IN 46032  
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SECTION 6  
WESTFIELD, INDIANA  
MERRIMAC CORP.  
CARMEL, INDIANA

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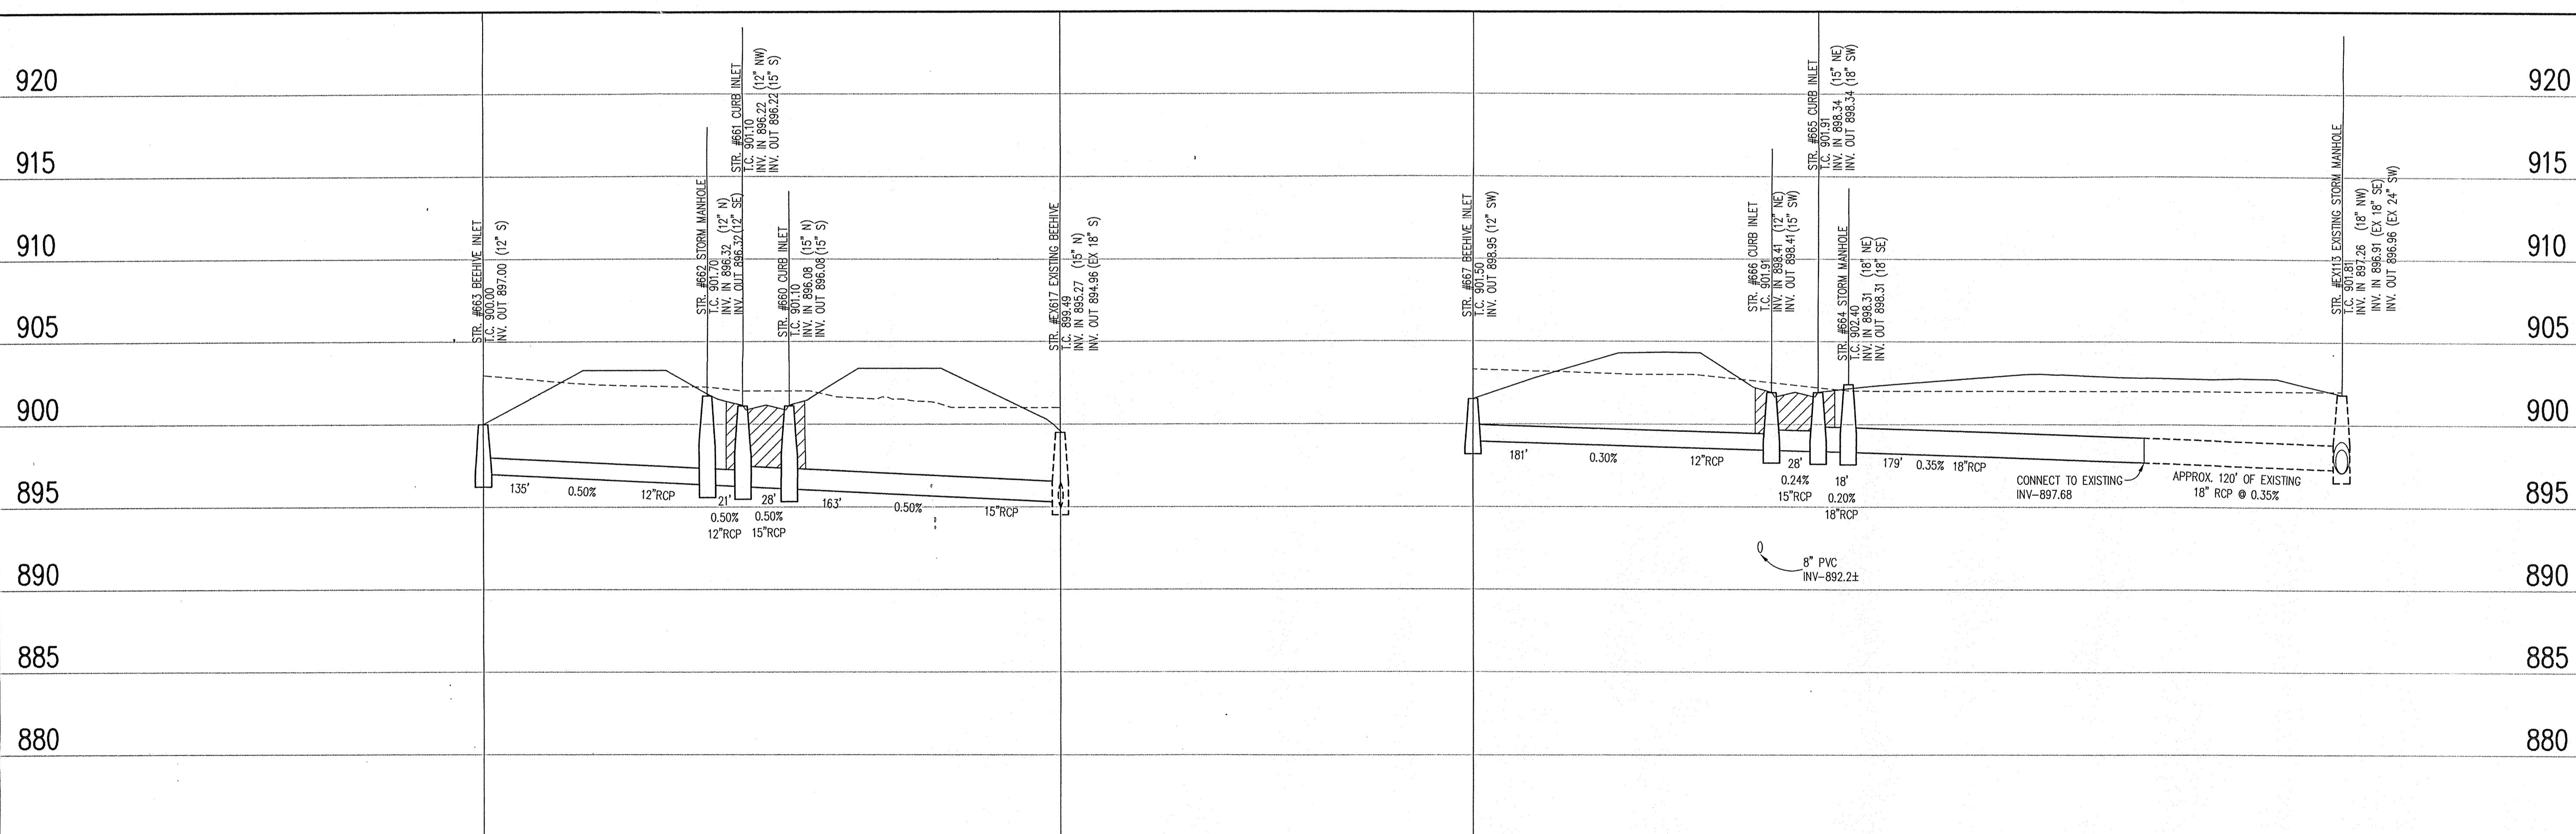
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DRAWN BY: MG CHECKED BY:  
SHEET TITLE: STORM SEWER PLAN & PROFILE  
DRAWING FILES:  
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XREF: 68SD.DWG  
XREF: 02EX-B5.DWG  
XREF: 02EX-B3.DWG  
XREF: STORM.DWG

SCALE NO.:

C602


### STORM SEWER PLAN

SCALE: 1"=50'




### STORM SEWER PROFILE

This copy printed from the Digital Archive of the Hamilton County Surveyor's Office; One Hamilton Co. Square, Ste. 188, Noblesville, IN 46060

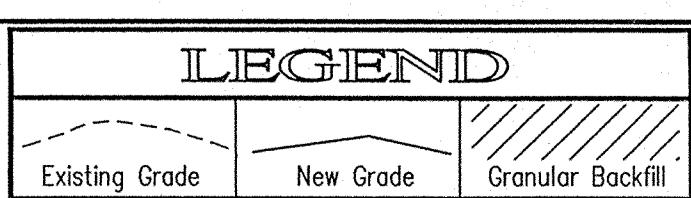


SCALE: HORIZ.: 1"=50'  
VERT.: 1"=5'

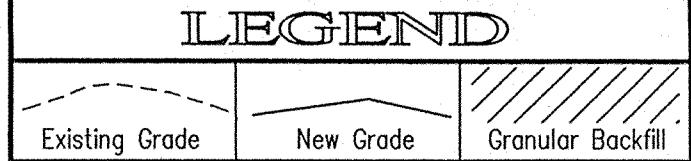

### BENCHMARK



U.S.G.S. 93 RHP (951)  
BRONZE TABLET SET IN CONCRETE POST, LOCATED ON THE  
SOUTH SIDE OF 146TH STREET, APPROX. 25' WEST OF THE  
CENTERLINE OF DITCH ROAD.  
(ELEVATION = 903.373)

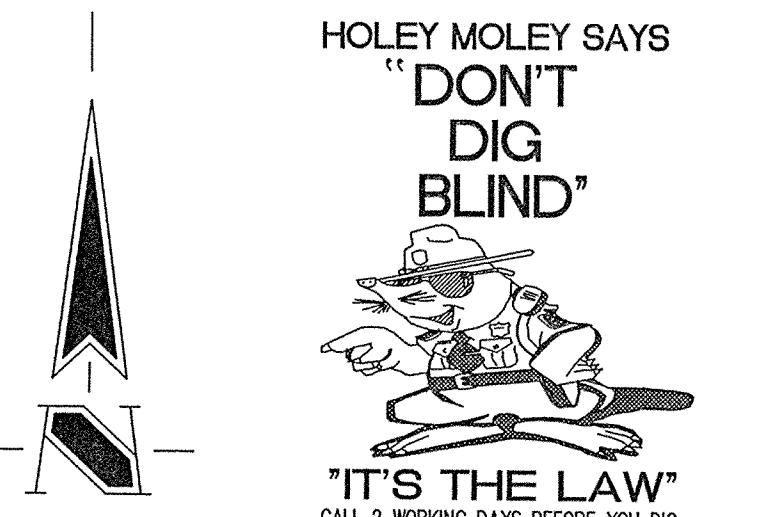

"IT'S THE LAW"  
CALL 2 WORKING DAYS BEFORE YOU DIG  
1-800-382-5544  
CALL TOLL FREE

PER INDIANA STATE LAW IS-69-1991.  
IT IS AGAINST THE LAW TO EXCAVATE  
WITHOUT NOTIFYING THE UNDERGROUND  
LOCATION SERVICE TWO (2) WORKING  
DAYS BEFORE COMMENCING WORK.

REVISIONS:  
1.DOC 09/06/01, REVISED FOR TAG COMMENTS.

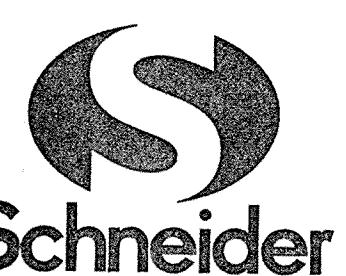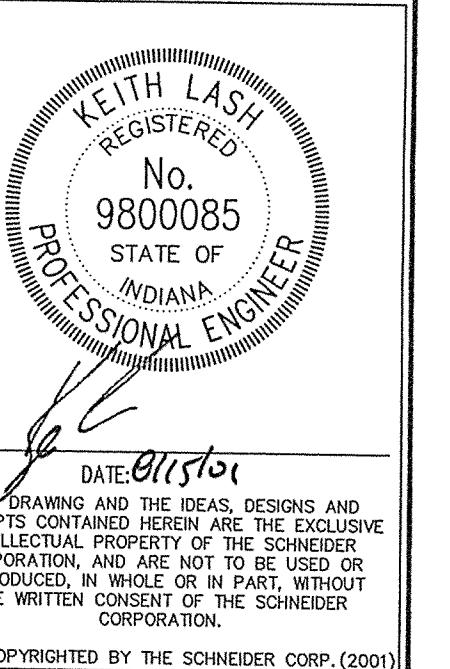

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SEP 12 2001  
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DATE:	8/15/01	PROJECT NO.:	1045.004
DRAWN BY:	MG	CHECKED BY:	
SHEET TITLE:			
WATER DISTRIBUTION PLAN			
DRAWING FILES: N-1045\004\CS\CS\701.DWG WREF: 02X-BSL.WMG XREF: 05X-BSL.WMG XREF: 1045STOP0.DWG			
SHEET NO.:			

C701

### GENERAL NOTES



1. TEMPORARY TRAFFIC CONTROL DURING CONSTRUCTION TO CONFORM TO APPLICABLE LOCAL AND STATE STANDARDS.
2. ALL CONSTRUCTION ACTIVITY ON THIS SITE TO BE PERFORMED IN COMPLIANCE WITH APPLICABLE O.S.H.A. STANDARDS FOR WORKER SAFETY.
3. FOR EASEMENT LOCATIONS SEE RECORDED PLAT.

### LEGEND

- NEW STORM SEWER
- EXISTING SANITARY SEWER
- EXISTING STORM SEWER
- NEW SANITARY SEWER
- V— EXISTING WATER MAIN
- V— NEW WATER MAIN WITH VALVE AND 3/4" SERVICE LINE TO EACH LOT
- +— NEW FIRE HYDRANT ASSEMBLY
- V— TEMPORARY FLUSHING HYDRANT
- V— REDUCER
- V— SAMPLE TAP

NOTE:

1. WATERLINE TO HAVE A MINIMUM COVER OF 57".
2. WATERLINE LATERALS TO HAVE A 10' HORIZONTAL MINIMUM SEPARATION TO SANITARY LATERALS.
3. ALL WATERLINE ARE TO BE 8" PIPE UNLESS OTHERWISE NOTED.
4. WATER MAIN VALVES SHALL NOT BE LOCATED UNDER PAVEMENT.

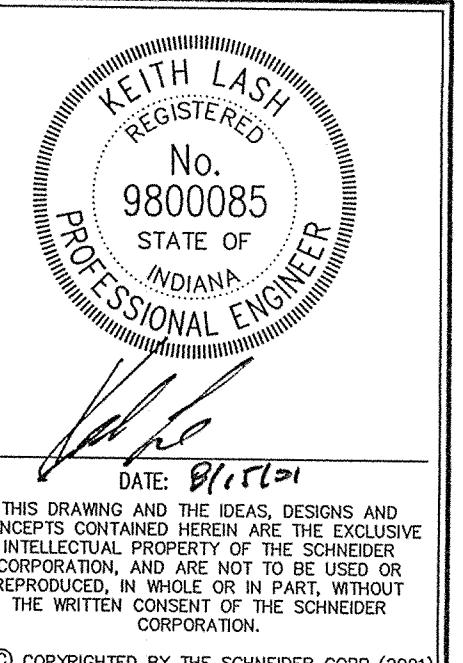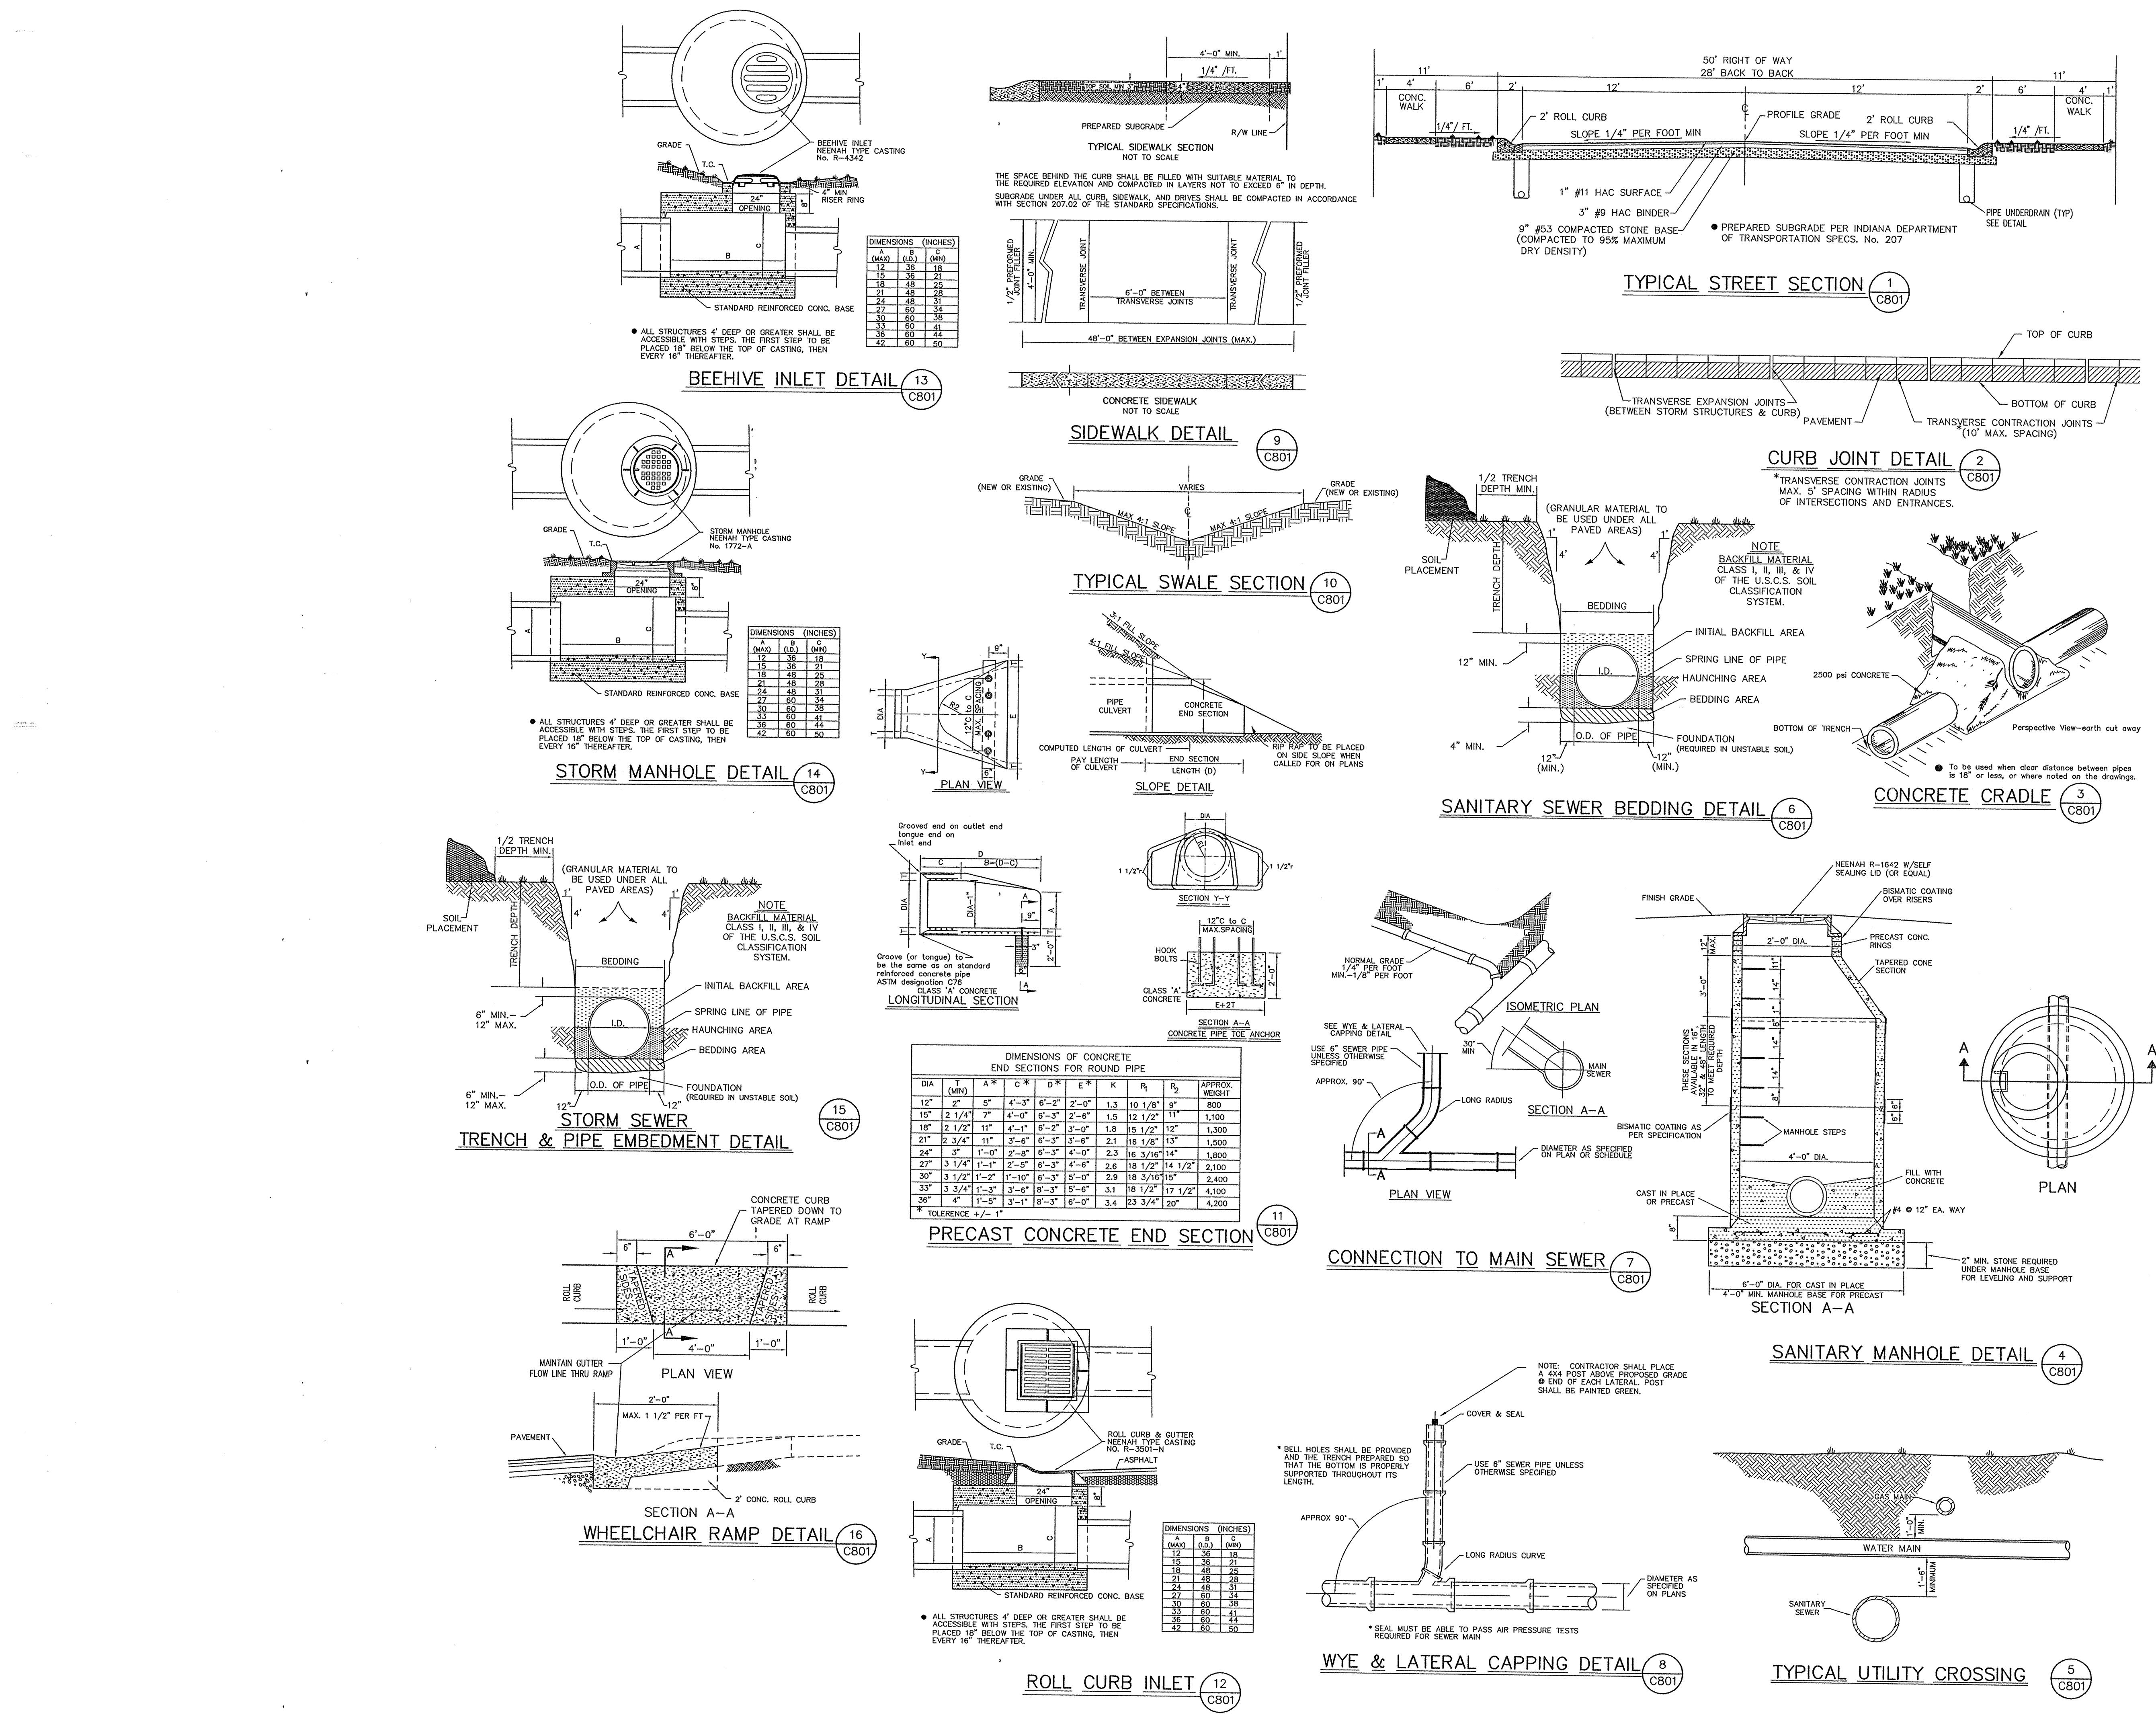

**Schneider**

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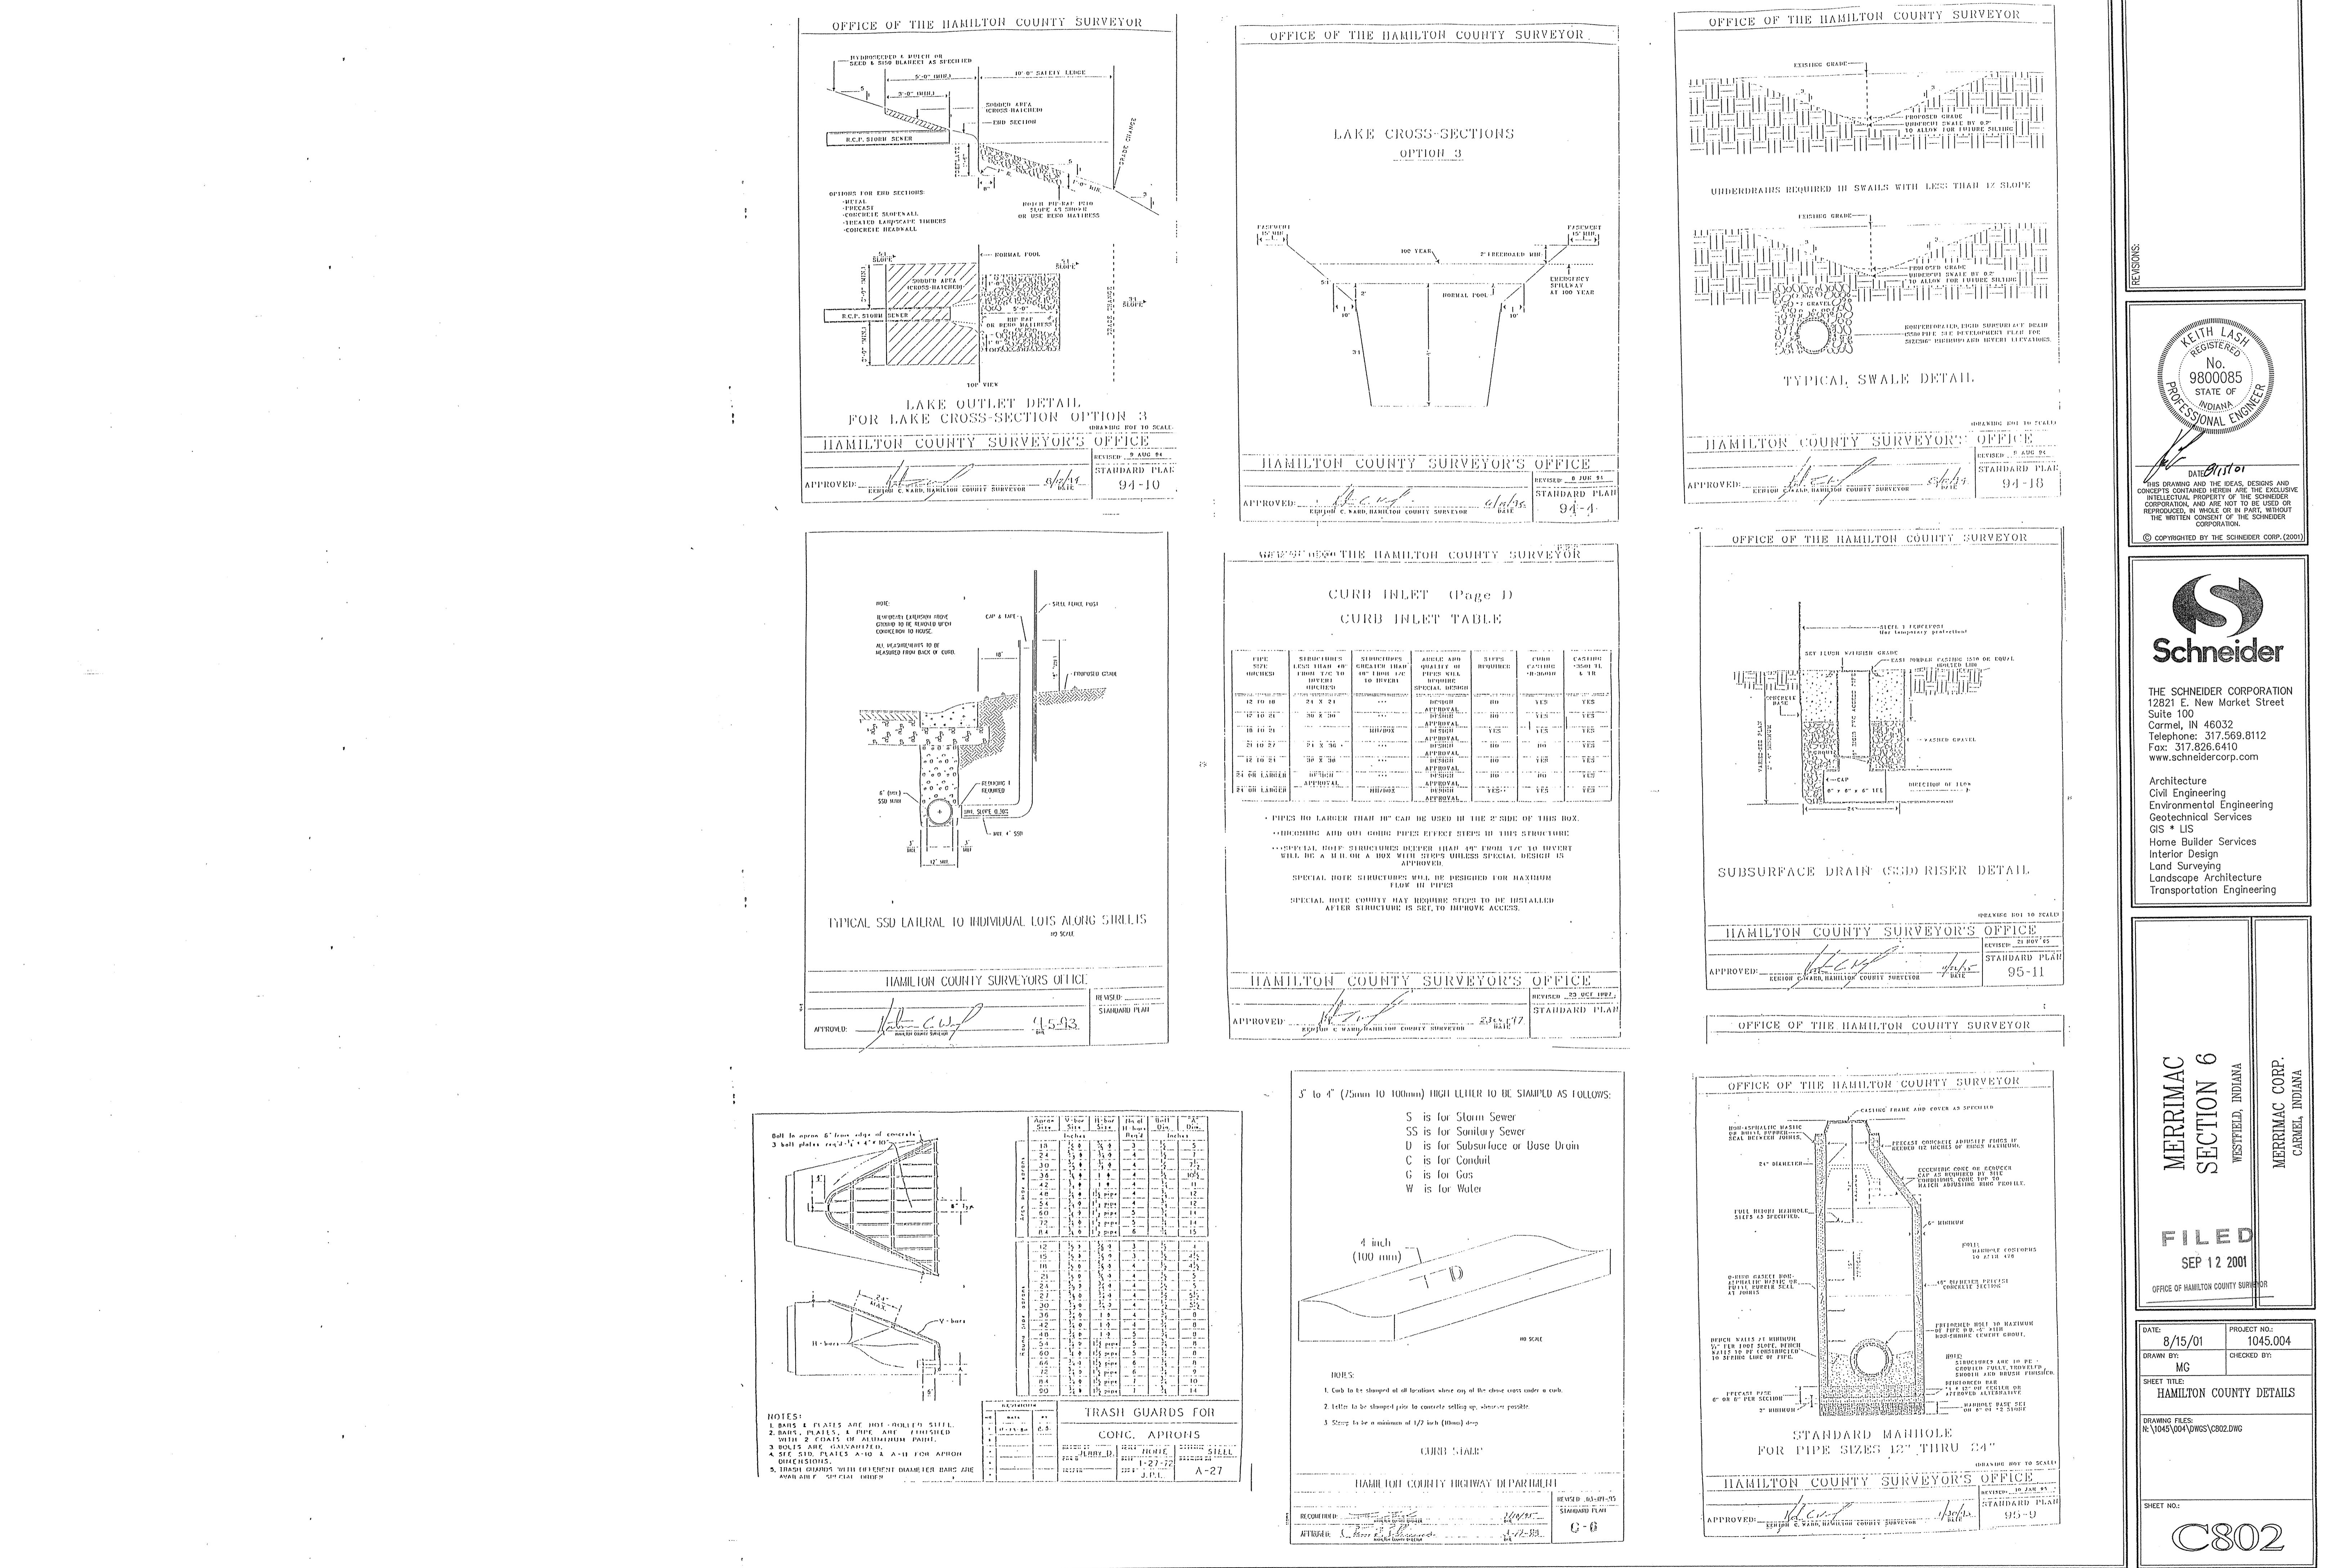
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SEP 12 2001  
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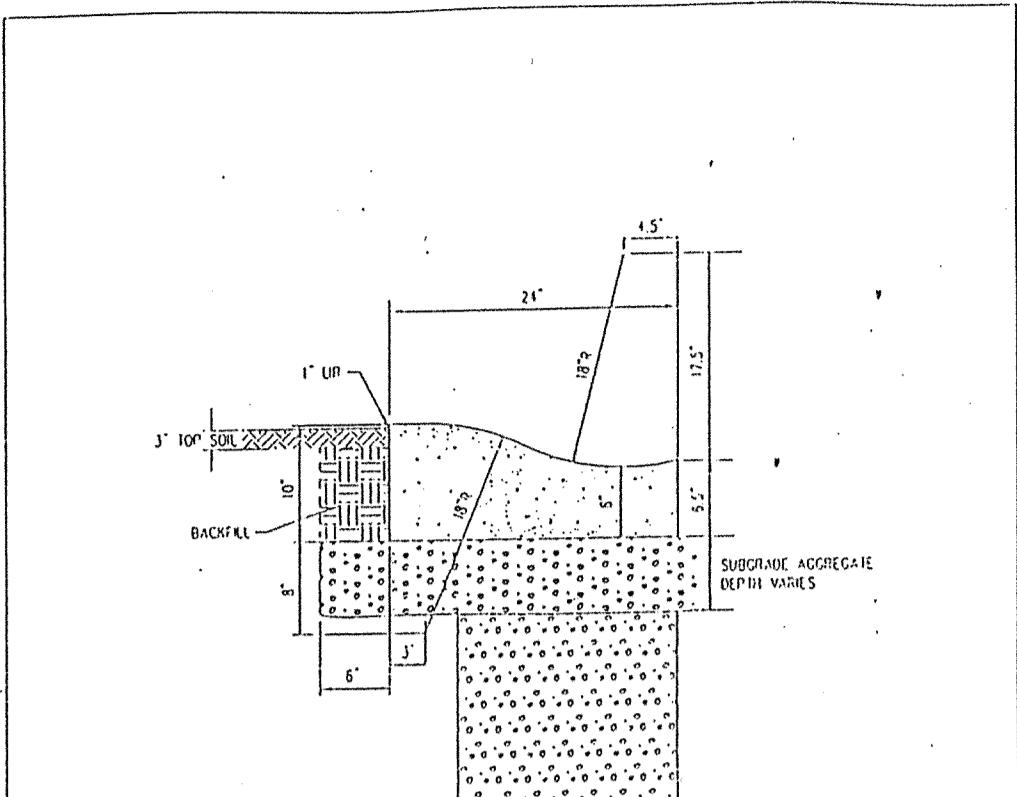
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DRAWN BY: MG CHECKED BY:  
SHEET TITLE: GENERAL DETAILS  
DRAWING FILE: N:\1045\004\DWGS\C801.DWG

SHEET NO.: C801

C801


REVISIONS:






CONCRETE ROLL CURB & GUTTER  
IN SCALE

HAMILTON COUNTY HIGHWAY DEPARTMENT	
RECOMMENDED:	1-5-93
APPROVED:	1-5-93
REvised:	STANDARD PLAN
C-1	

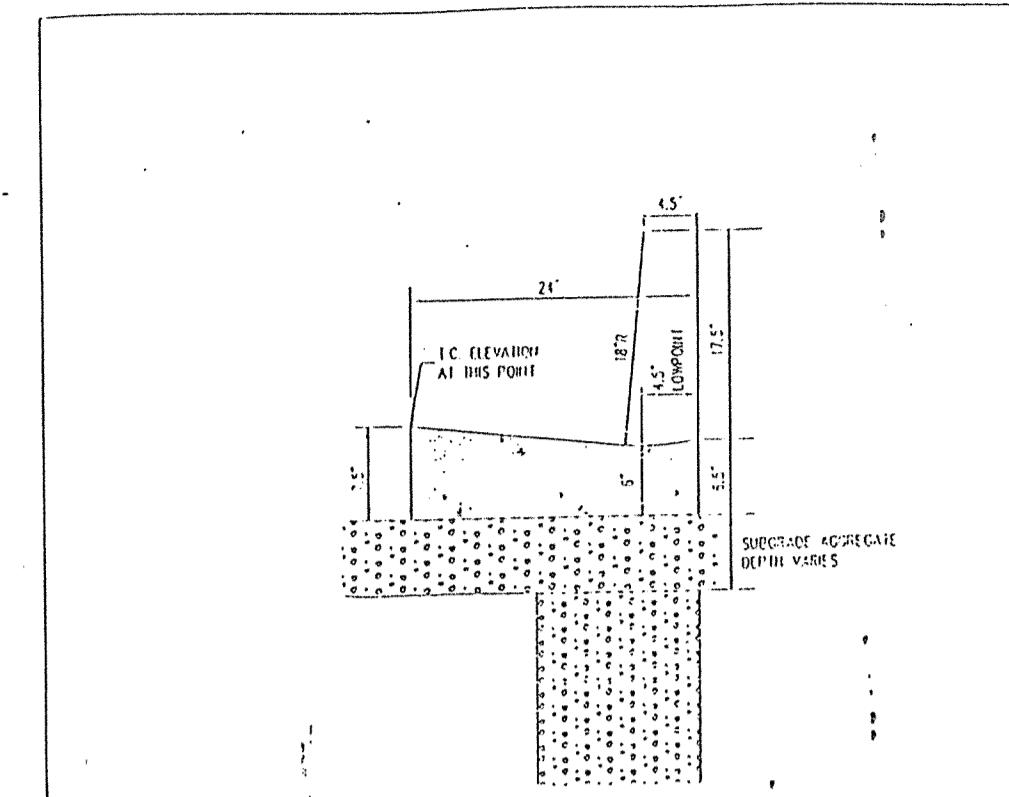


VALLEY GUTTER DETAIL  
IN SCALE

HAMILTON COUNTY HIGHWAY DEPARTMENT	
RECOMMENDED:	1-5-93
APPROVED:	1-5-93
REvised:	STANDARD PLAN
C-3	

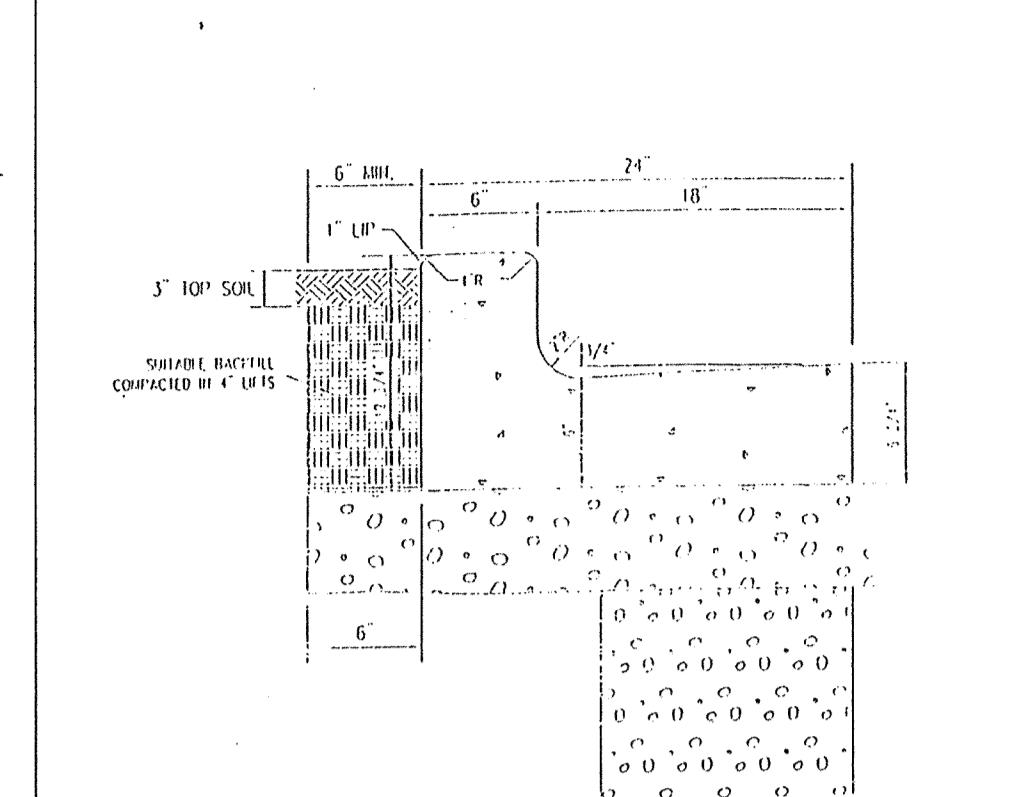


COMBINED CONCRETE CURB & GUTTER (TYPE II)  
IN SCALE

HAMILTON COUNTY HIGHWAY DEPARTMENT	
RECOMMENDED:	1-5-93
APPROVED:	1-5-93
REvised:	STANDARD PLAN
C-4	

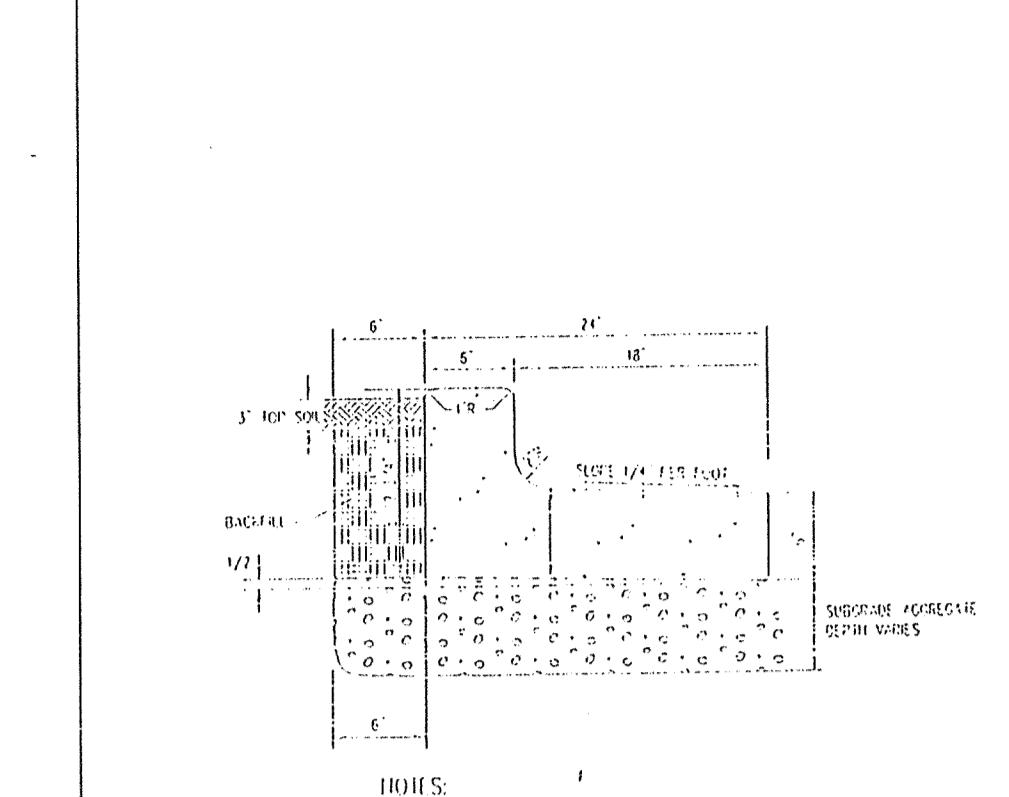


TYPICAL COMBINED CURB & GUTTER  
WITH REVERSED STORM GUTTER  
IN SCALE

HAMILTON COUNTY HIGHWAY DEPARTMENT	
RECOMMENDED:	1-5-93
APPROVED:	1-5-93
REvised:	STANDARD PLAN
C-5	

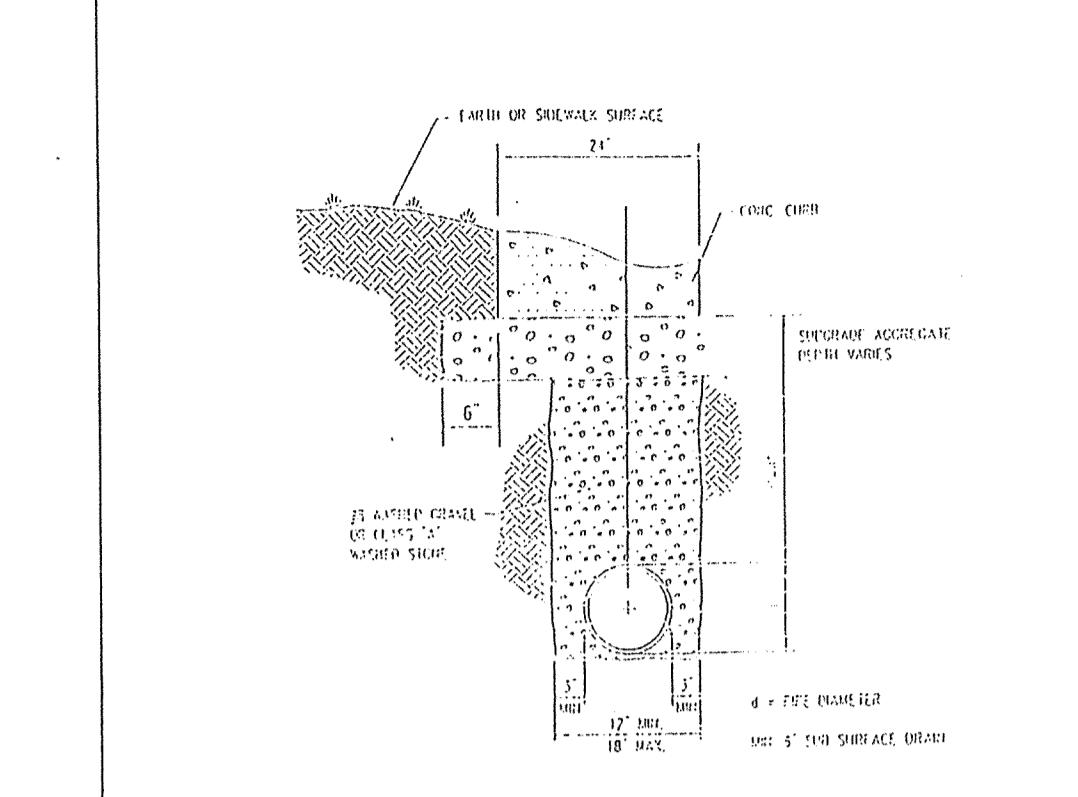

PPIPE UNDERDRAIN  
IN SCALE

HAMILTON COUNTY HIGHWAY DEPARTMENT	
RECOMMENDED:	1-5-93
APPROVED:	1-5-93
REvised:	STANDARD PLAN
P-1	

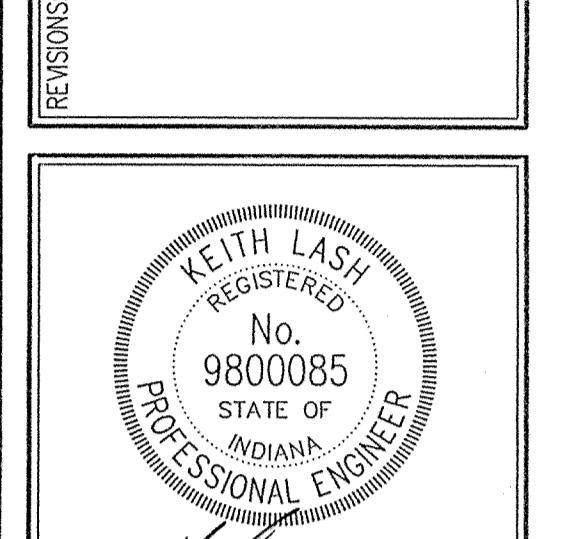


DATE: 8/15/01  
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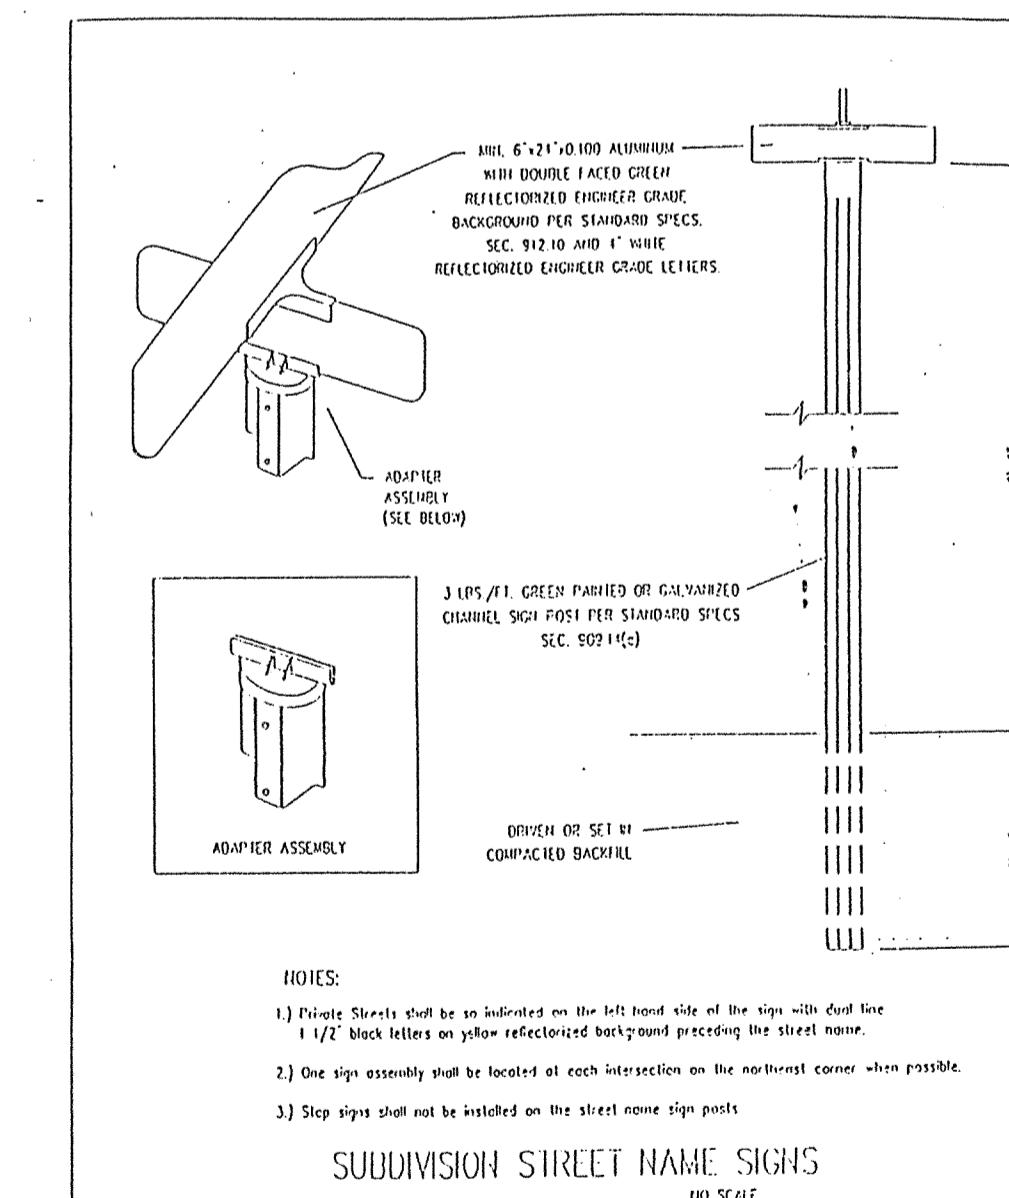
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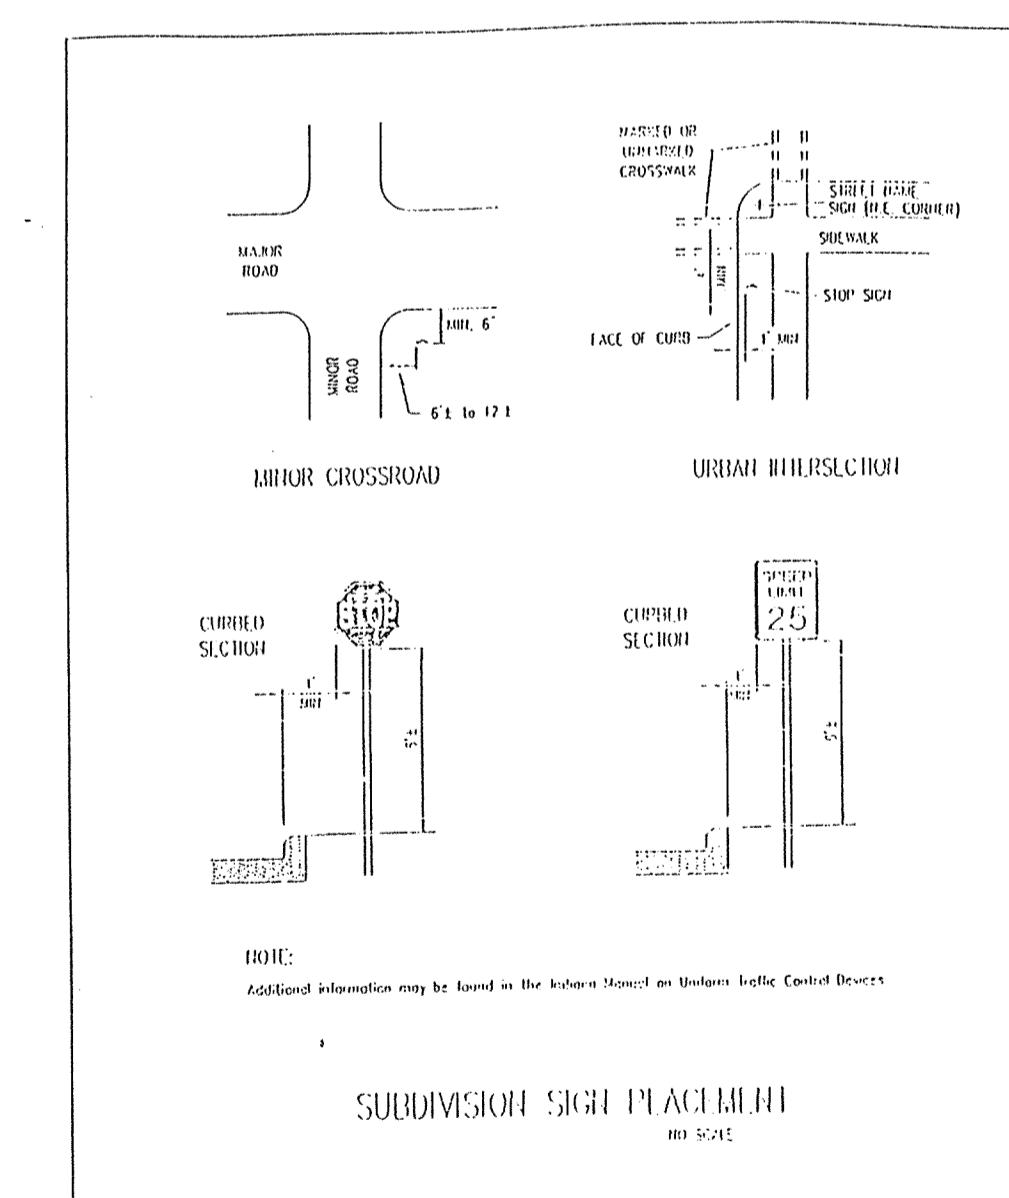
TYPICAL SUBDIVISION REGULATORY SIGNS  
IN SCALE

HAMILTON COUNTY HIGHWAY DEPARTMENT	
RECOMMENDED:	1-5-93
APPROVED:	1-5-93
REvised:	STANDARD PLAN
S-1	




SUBDIVISION STREET NAME SIGNS  
IN SCALE

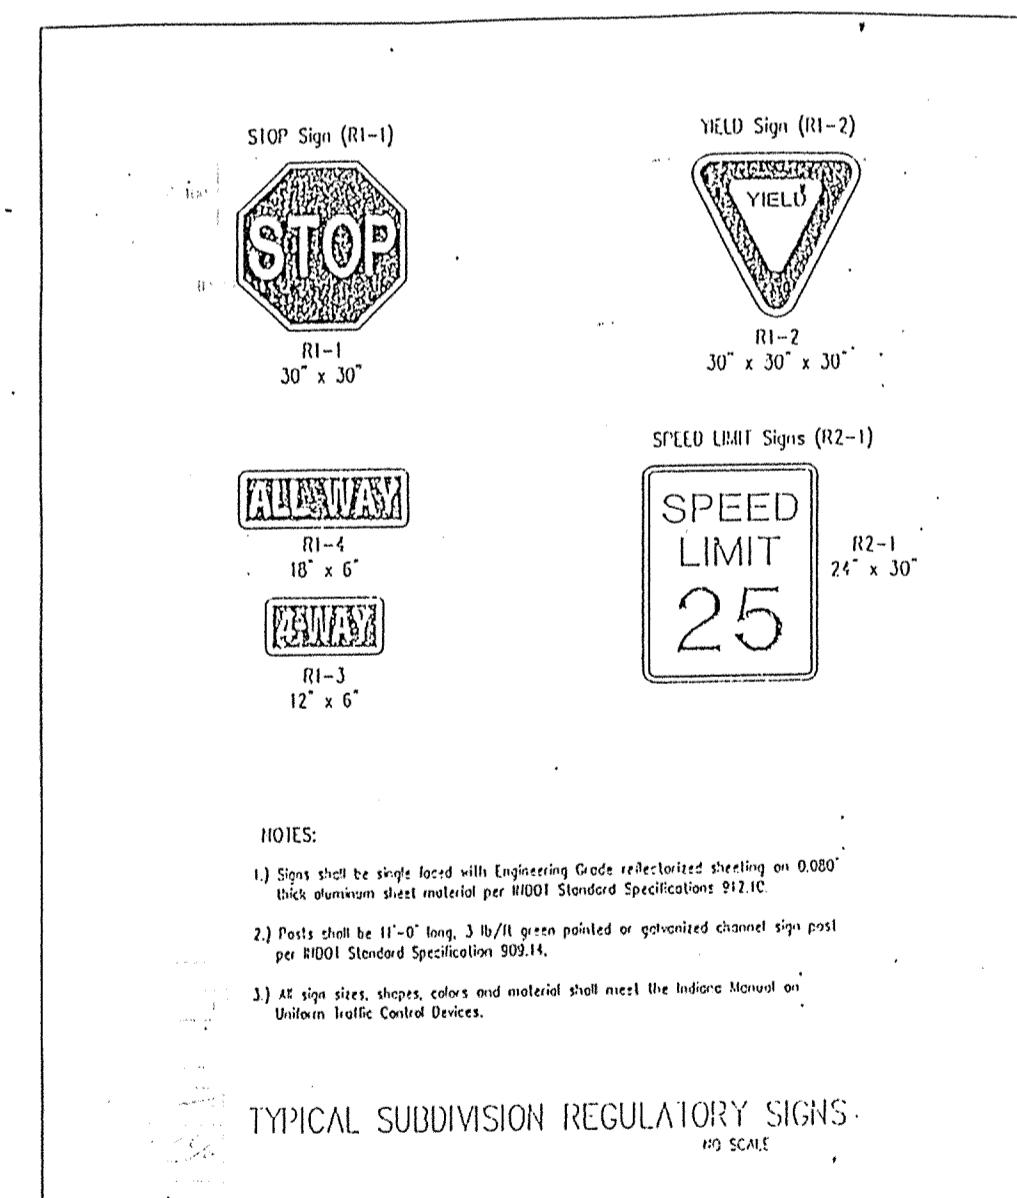HAMILTON COUNTY HIGHWAY DEPARTMENT	
RECOMMENDED:	1-5-93
APPROVED:	1-5-93
REvised:	STANDARD PLAN
S-2	




SUBDIVISION SIGN PLACEMENT  
IN SCALE

HAMILTON COUNTY HIGHWAY DEPARTMENT	
RECOMMENDED:	1-5-93
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REvised:	STANDARD PLAN
S-3	

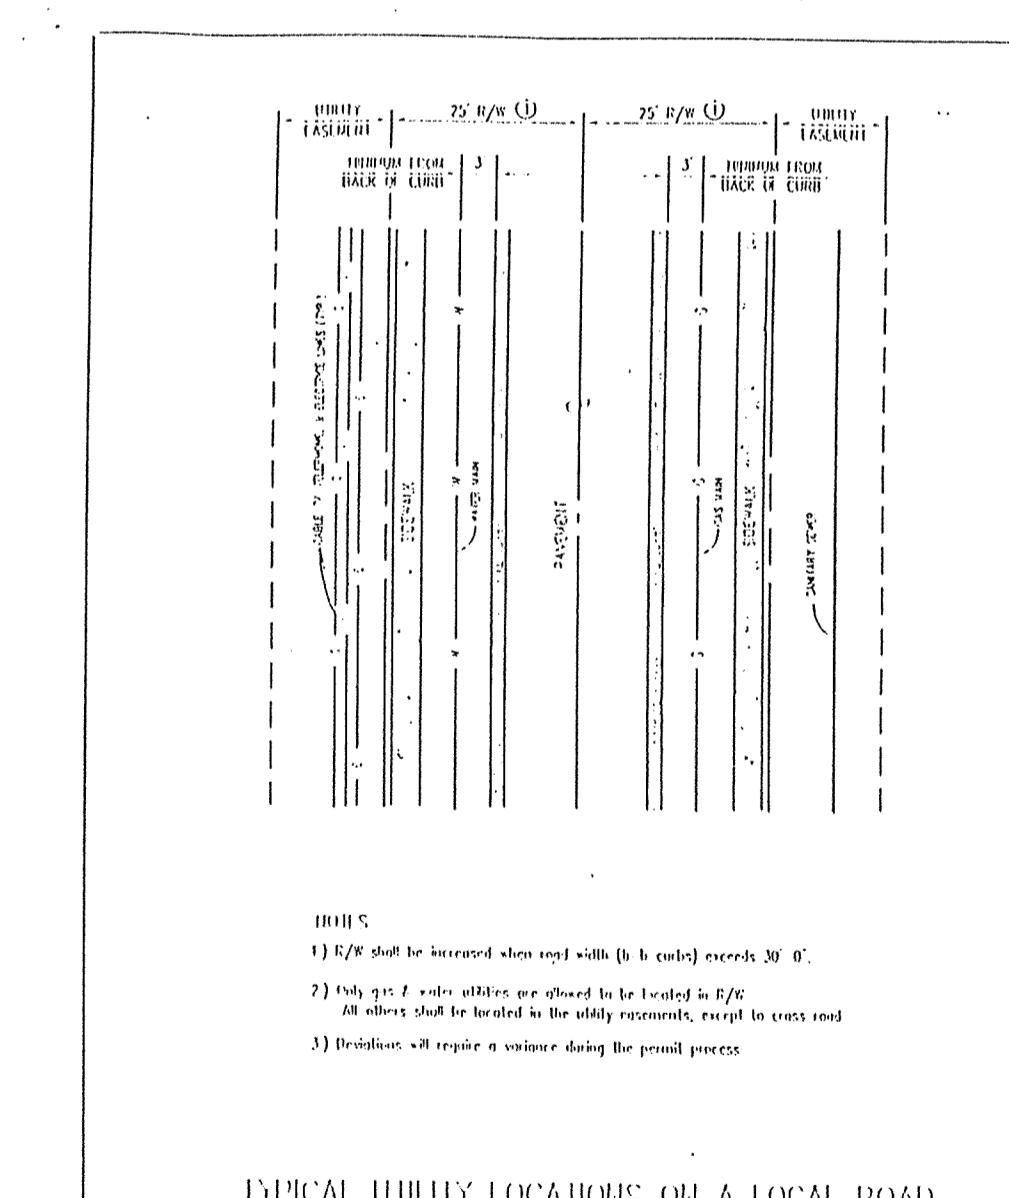

TYPICAL UTILITY LOCATIONS ON A LOCAL ROAD  
IN SCALE

HAMILTON COUNTY HIGHWAY DEPARTMENT	
RECOMMENDED:	1-5-93
APPROVED:	1-5-93
REvised:	STANDARD PLAN
U-2	

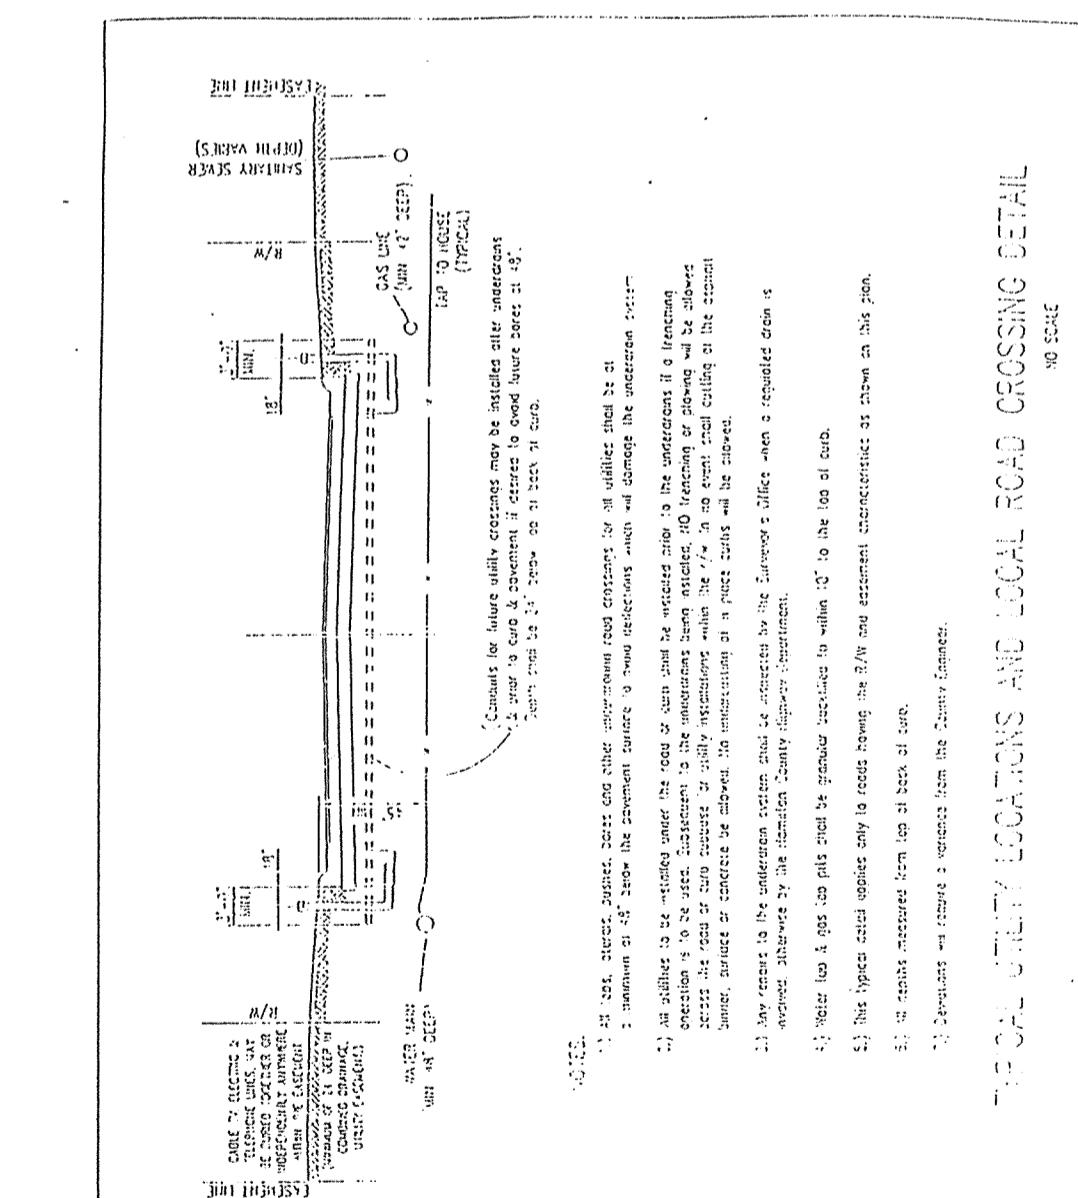


UTILITY LOCATIONS ON LOCAL ROAD CROSSING DETAIL  
IN SCALE


HAMILTON COUNTY HIGHWAY DEPARTMENT	
RECOMMENDED:	1-5-93
APPROVED:	1-5-93
REvised:	STANDARD PLAN
U-1	

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SEP 12 2001  
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WESTFIELD, INDIANA  
CARMEL, INDIANA  
SHEET NO.: C803  
DRAWING FILE: N:\1045\004\DWGS\CB03.DWG  
SHEET TITLE: HAMILTON COUNTY DETAILS  
DATE: 8/15/01 PROJECT NO.: 1045.004  
DRAWN BY: MG CHECKED BY:  
SHEET NO.: C803  
C803

**REQUIREMENTS:**  
CONTRIBUTING DRAINAGE AREA: 1 ACRE MAXIMUM.  
CAPACITY: RUNOFF FROM A 2-YR. FREQUENCY, 24-HR. DURATION STORM EVENT ENTERING THE STORM DRAIN WITHOUT BYPASS FLOW.  
LOCATION: AT CURB INLETS WHERE PONDING IS NOT LIKELY TO CAUSE INCONVENIENCE OR DAMAGE.  
GRAVEL: 1-2 IN. DIAMETER (INDOT No. 2).  
WIRE MESH: CHICKEN WIRE OR HARDWARE CLOTH WITH 1/2 IN. OPENINGS.  
GEOTEXTILE FABRIC (OPTIONAL): FOR FILTRATION.

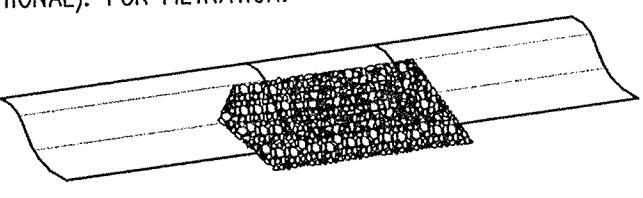


**INSTALLATION:**  
1. INSTALL GRAVEL CURB INLET PROTECTION AS SOON AS THE STREETS ARE PAVED IN A NEW DEVELOPMENT SITUATION OR BEFORE LAND DISTURBING ACTIVITIES IN STABILIZED AREAS.  
2. PLACE WIRE MESH OVER THE CURB INLET OPENINGS AND/OR GRADE SO IT EXTENDS AT LEAST 12 IN. BEYOND BOTH TOP AND BOTTOM OF THE OPENING/GRADE.  
3. INSTALL GEOTEXTILE FABRIC OVER THE WIRE MESH FOR ADDITIONAL FILTRATION (OPTIONAL).  
4. PILE GRAVEL OVER THE WIRE MESH TO ANCHOR IT AGAINST THE CURB, COVERING THE INLET OPENING COMPLETELY.

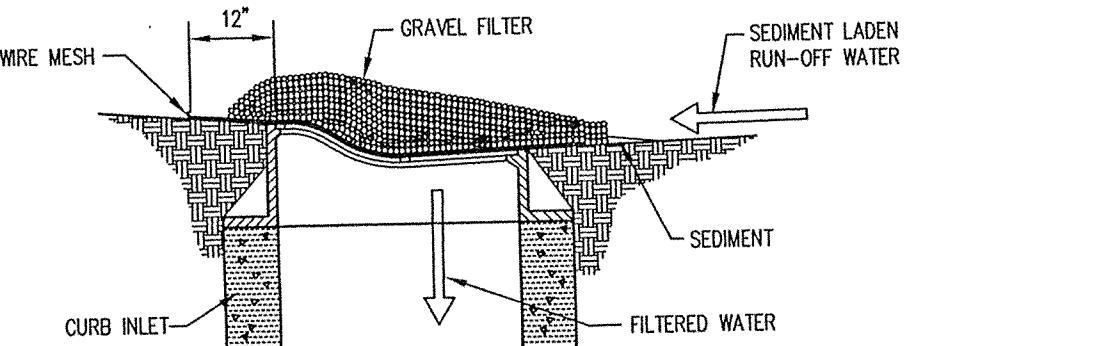


**Maintenance:**  
\* AFTER EACH STORM EVENT, REMOVE SEDIMENT AND REPLACE THE GRAVEL; REPLACE THE GEOTEXTILE FILTER FABRIC IF USED.  
\* PERIODICALLY REMOVE SEDIMENT AND TRACKED-ON SOIL FROM THE STREET (BUT NOT BY FLUSHING WITH WATER) TO REDUCE THE SEDIMENT LOAD ON THE CURB INLET PRACTICE.  
\* INSPECT PERIODICALLY, AND REPAIR DAMAGE CAUSED BY VEHICLES.  
\* WHEN THE CONTRIBUTING DRAINAGE AREA HAS BEEN STABILIZED, REMOVE THE GRAVEL, WIRE MESH, GEOTEXTILE FABRIC, AND ANY SEDIMENT AND DISPOSED OF THEM PROPERLY.

**COMMON CONCERN:**  
SEDIMENT NOT REMOVED FROM ROADWAY AND GRAVEL AND FABRIC NOT REPLACED FOLLOWING A STORM EVENT--  
RESULTS IN INCREASED SEDIMENT TRACKING, TRAFFIC HAZARD, AND EXCESSIVE PONDING.  
DRAINAGE AREA TOO LARGE -- CAUSES SEDIMENT OVERLOAD AT THE INLET AND/OR BY-PASS FLOW.  
SLOPE TOO STEEP -- RESULTS IN BYPASS FLOW AND/OR DISLODGE OF THE GRAVEL, AND HARDWARE CLOTH;  
CONSIDER REPLACING WITH OR USING IN COMBINATION WITH A SANDBAG CURB INLET PROTECTION (PRACTICE 3.64)

### GRAVEL CURB INLET PROTECTION

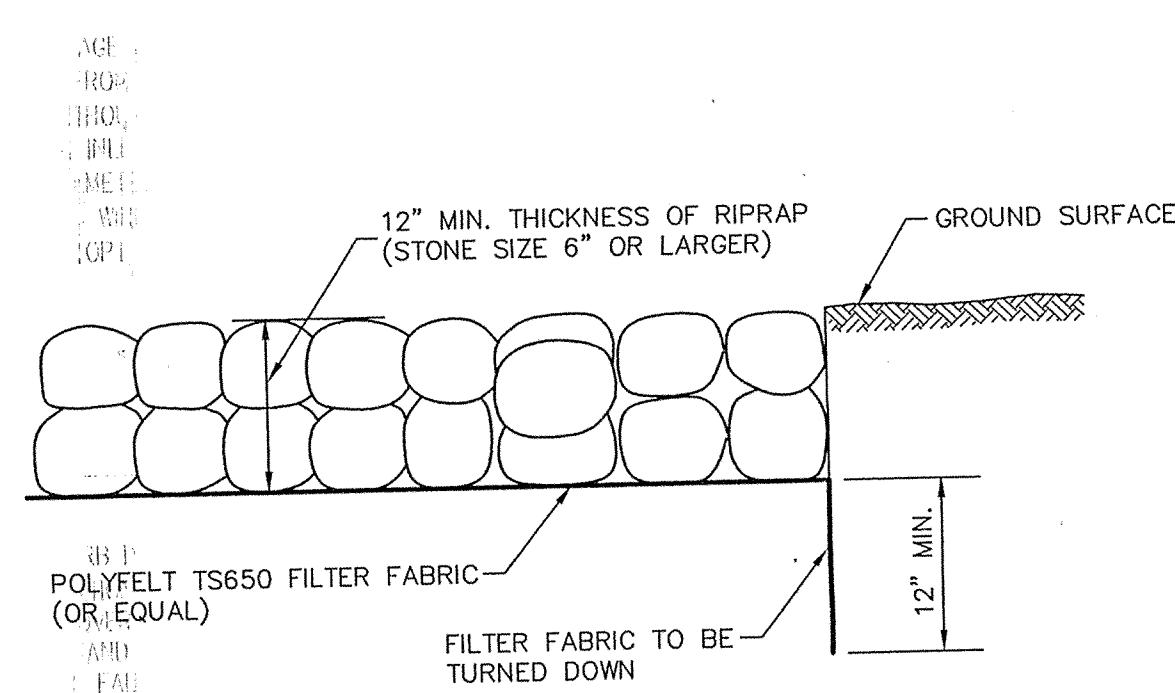

### RIPRAP/FILTER CLOTH DETAIL

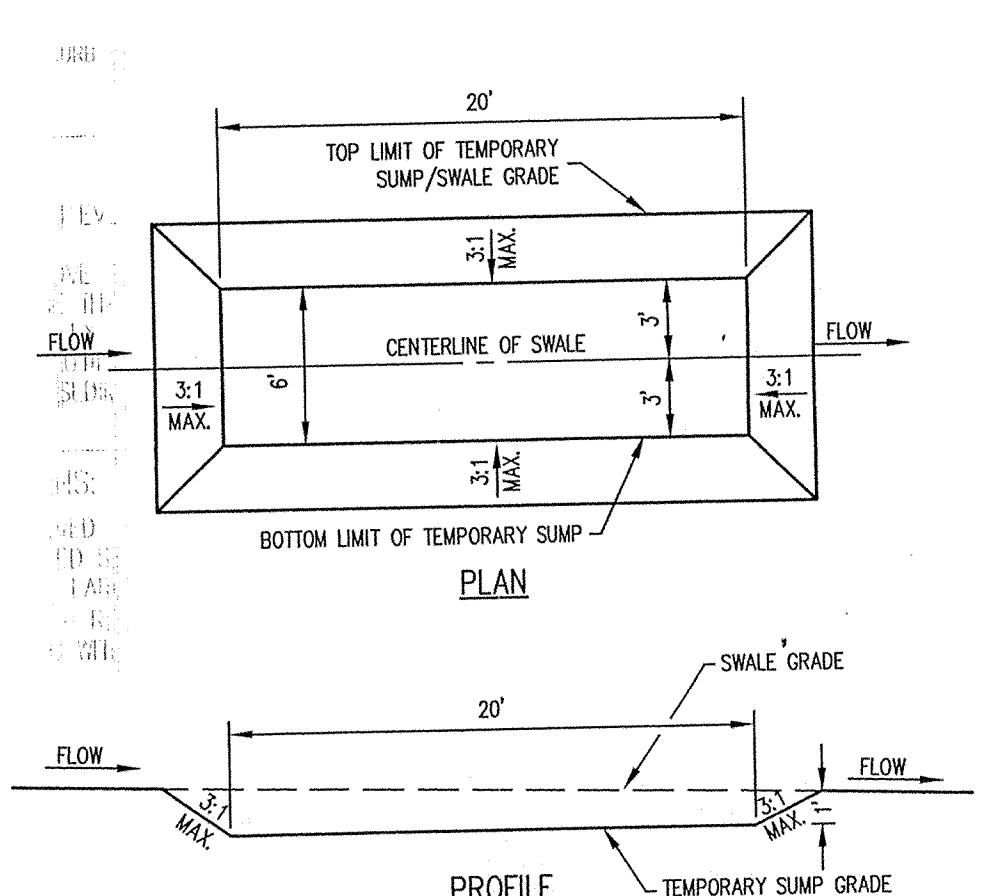

**TEMPORARY SILTATION SUMPT DETAIL**  
SCALE: NONE


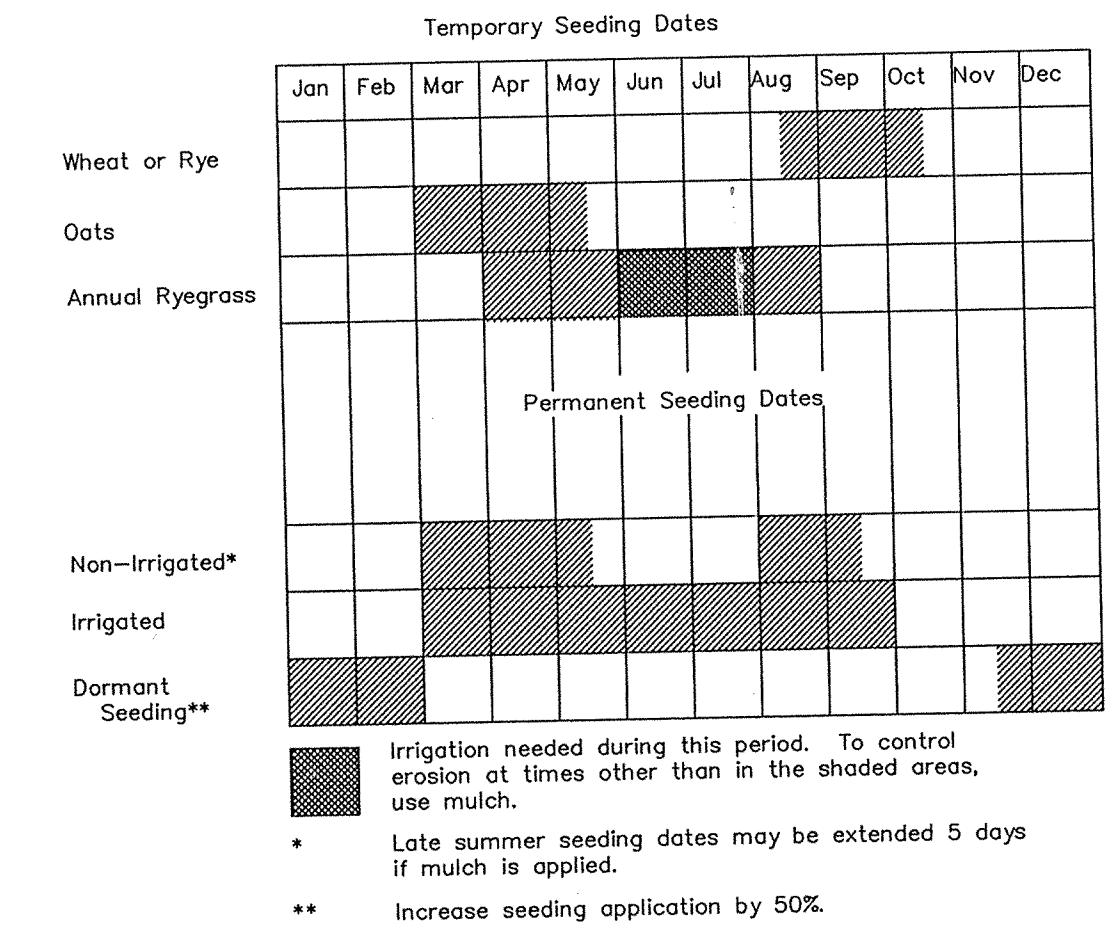


FIGURE 5-3

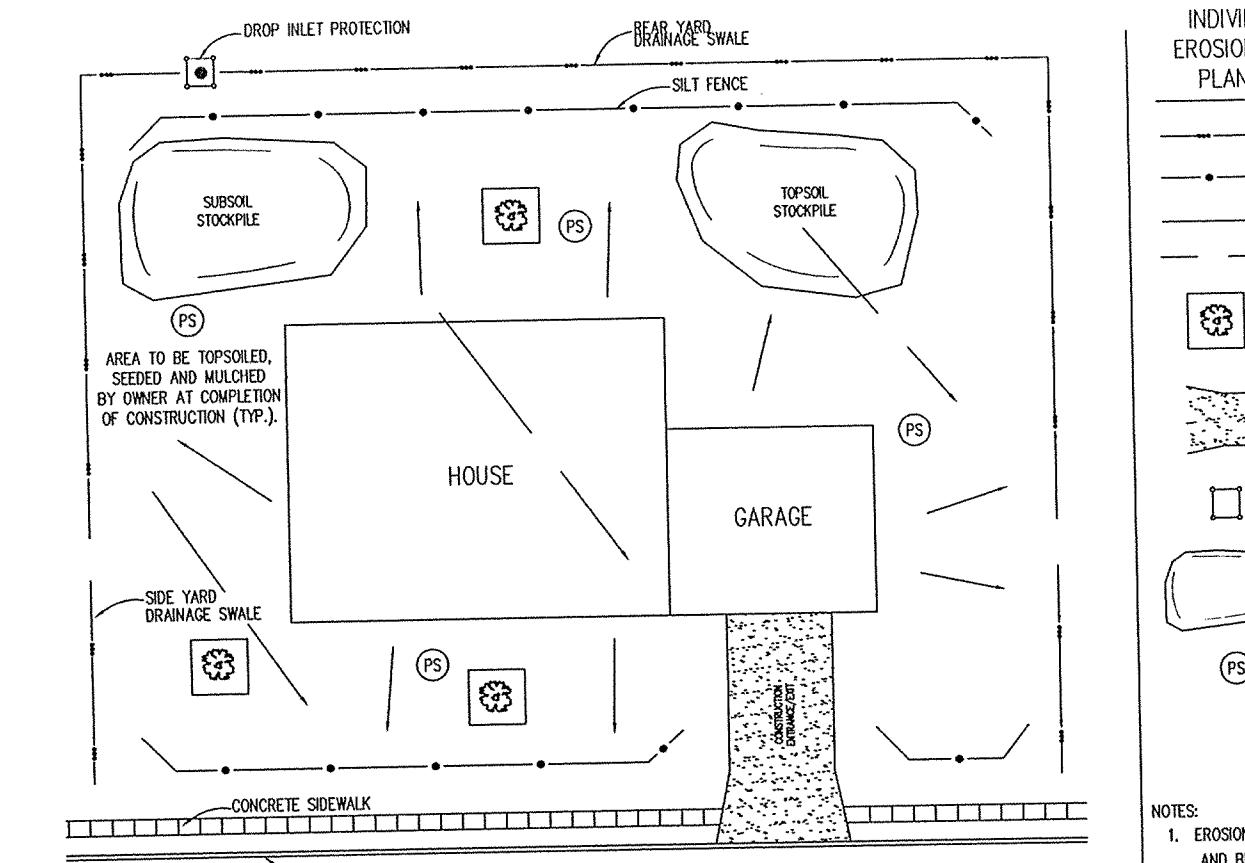

SAMPLE EROSION/SEDIMENT CONTROL PRACTICE PLAN FOR A TYPICAL ONE- OR TWO-FAMILY DWELLING UNDER CONSTRUCTION  
SCALE: NONE

### SILT FENCE

SCALE: NONE  
Silt Fence shall be a machine produced, non-woven geotextile of 100% polypropylene meeting the physical properties below.  
All stakes shall be 2" X 2" hardware 36" tall with 24" till loath staked to stakes over fabric as reinforcement.  
All silt fence shall be prefabricated by the supplier. No field assembly will be accepted.

Fabric Weight.....	4 oz/syd
Grab Strength.....	Warp 125 lbs.
Elongation.....	Warp 50 %
Trapezoidal Tear Strength.....	50 lbs.
Burst Strength.....	200 psi
UV Resistance.....	> 70 %
A.O.S.....	50-80
Slurry Flow Rate.....	225 gpm/sq. ft
Sediment Retention.....	75 %

Ranking:  
1 Good  
2 Medium  
- Not tolerable

Salt Tolerance (to both soil salts & spray):  
T Tolerance  
MT Medium Tolerance  
S Slight Tolerance

SPECIES	SOIL CONDITION	Wet	Norm	Dry	Soil Depth inches Or 2-3/2' max	Soil Tension Tolerance	Fertilizer Tolerance	Water Tolerance	Rooting Tolerance	Emergent Height (inches)	Salt Tolerance	Soil Spray
Creeping Red Fescue <i>Festuca rubra</i>	2	1	2	1	1	1	Med.	1	20-25	12-18	7-21	S
Kentucky Bluegrass <i>Poa pratensis</i>	2	1	2	1	1	1	Med.	1	23-35	12-18	10-20	MT
Tall Fescue <i>Festuca L. arundinacea</i>	2	1	1	1	1	1	Low	1	24-35	24-36	5-14	T
Perennial ryegrass <i>Lolium perenne</i>	2	1	2	-	1	2	Med-High	2	15-20	12-18	5-10	MT
Crownvetch <i>Coronilla varia</i>	-	1	1	2	-	-	Low	1	5-10	24	14-21	T
Red Clover <i>Trifolium pratense</i>	-	1	-	2	-	-	Med.	1	7-10	18	5-10	S S

### EROSION CONTROL BY HOUSE BUILDERS

- Temporary and permanent seeded areas established by the developer will be maintained by the home builder and his subcontractors. Straw bale dams or silt fences previously installed will be maintained.
- A construction drive to the house-site from the street shall be installed of Number 2 Stone, 6" thick and a minimum of 12' wide. This shall be utilized for access to the house and any mud or dirt tracked into the street shall be promptly removed to a stable area (water shall not be used to flush silt or mud to the storm sewer).
- In a particularly persistent erosion condition, silt fencing or other measures may be required by the developer.
- When time is appropriate, and as soon as possible, roof down spout extenders of non-perforated drain tile should be extended to the street or other solid outlet until a lawn is established.

### EROSION CONTROL MEASURES MAINTENANCE REQUIREMENTS

- INSPECT STRAW BALES DURING EACH STORM EVENT AND PROMPTLY REMOVE ANY SEDIMENT DEPOSITS TO ENSURE ADEQUATE STORAGE VOLUME FOR THE NEXT RAIN, TAKING CARE NOT TO UNDERLINE THE ENTRENCHED BALES.
- INSPECT SILT FENCE DURING CONSTRUCTION AND REPAIR IMMEDIATELY.
- AFTER THE CONTRIBUTING DRAINAGE AREA HAS BEEN STABILIZED, REMOVE ALL STRAW BALES AND SEDIMENT, BRING THE DISTURBED AREA TO GRADE, AND STABILIZE IT.

### SILT FENCE MAINTENANCE REQUIREMENTS

- INSPECT SILT FENCE PERIODICALLY AND AFTER EACH STORM EVENT.
- FENCE FABRIC TEARS, STRAIGHTEN FENCE IF IN ANY WAY BECOMES DEFECTIVE AND REPAIR IMMEDIATELY.
- REMOVE SEDIMENT WHEN IT REACHES HALF THE HEIGHT OF THE FENCE AT ITS LOWEST POINT OR IS CAUSING THE FABRIC TO BULGE.
- FLUSH SILT FENCE PERIODICALLY.
- CHECK THE SPILLWAY DEPTH PERIODICALLY TO ENSURE A DEPTH OF 12"-18" AND REPAIR IF NECESSARY.
- PROMPTLY REPLACE ANY DISPLACED RIPRAP, BEING CAREFUL THAT NO STONES IN THE SPILLWAY ARE ABOVE THE FABRIC.
- AFTER ALL SEDIMENT AREAS HAVE BEEN STABILIZED, REMOVE THE STRUCTURE AND SEDIMENT, SHRED THE SITE TO BLEND WITH ADDING AREAS, AND STABILIZE.

### SANDBAG CURB INLET SEDIMENT BARRIER MAINTENANCE REQUIREMENTS

- INSPECT FREQUENTLY FOR DAMAGE BY VEHICULAR TRAFFIC, AND REPAIR IF NECESSARY.
- INSPECT AFTER EACH STORM EVENT.
- REMOVE SEDIMENT, WITHOUT FLUSHING, WHEN IT REACHES HALF THE HEIGHT OF THE BARRIER.
- DEPOSIT REMOVED SEDIMENT WHERE IT WILL NOT ENTER STORM DRAINS.

### BLOCK AND GRAVEL CURB INLET PROTECTION MAINTENANCE REQUIREMENTS



- AFTER EACH STORM EVENT, REMOVE THE SEDIMENT AND REPLACE THE GRAVEL;
- INSPECT THE GEOTEXTILE FABRIC, IF USED.
- PERIODICALLY REMOVE SEDIMENT AND TRACED-ON SOIL FROM THE STREET, WITHOUT FLUSHING, TO REDUCE THE SEDIMENT LOAD ON THE CURB INLET PRACTICE.
- INSPECT PERIODICALLY, AND REPAIR DAMAGE CAUSED BY VEHICLES.

### EROSION CONTROL BLANKET (SURFACE APPLIED) MAINTENANCE REQUIREMENTS


- DURING VEGETABLE ESTABLISHMENT, INSPECT AFTER STORM EVENTS FOR ANY EROSION BELOW THE BLANKET.
- IF ANY eroSION OCCURS, PULL BACK THAT PORTION OF THE BLANKET COVERING IT, ADD SOIL, RE-SEED THE AREA, AND RE-LAY THE BLANKET.
- AFTER VEGETATION ESTABLISHMENT, CHECK THE TREATED AREA PERIODICALLY.

### TEMPORARY GROWTH CONSTRUCTION ENTRANCE MAINTENANCE REQUIREMENTS



- INSPECT ENTRANCE PAD AND SEDIMENT DISPOSAL AREA DAILY AND AFTER STORM EVENTS OR HEAVY USE.
- REPAVE PAD AS NEEDED FOR REINFORCE AND RUNOFF CONTROL.
- TOPDRESS ENTRANCE PAD AS NEEDED.
- IMMEDIATELY REMOVE MUD AND SEDIMENT TRACKED OR WASHED ONTO PUBLIC ROADS BY BRUSHING OR SWEEPING. FLUSHING SHOULD ONLY BE USED IF THE WATER IS CONVEYED INTO A SEDIMENT TRAP OR BASIN.
- REPAIR ANY BROKEN ROAD PAVEMENT IMMEDIATELY.

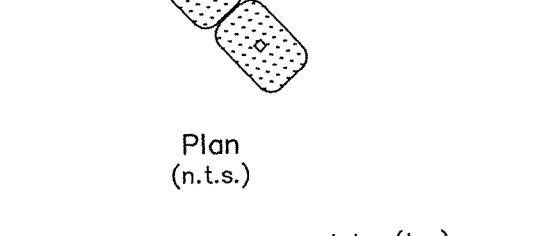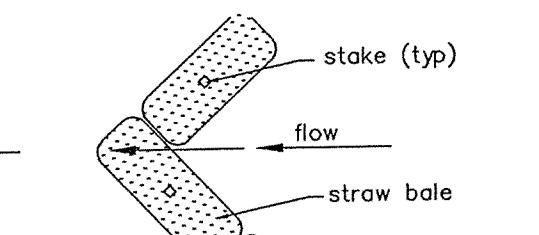

### SEDIMENT FILTER DETAIL

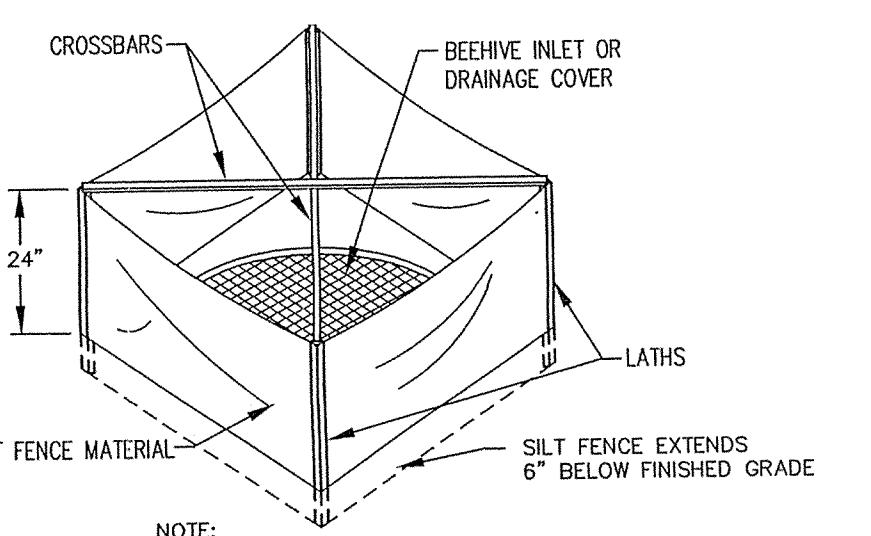

### INLET PROTECTION - SILT FENCE

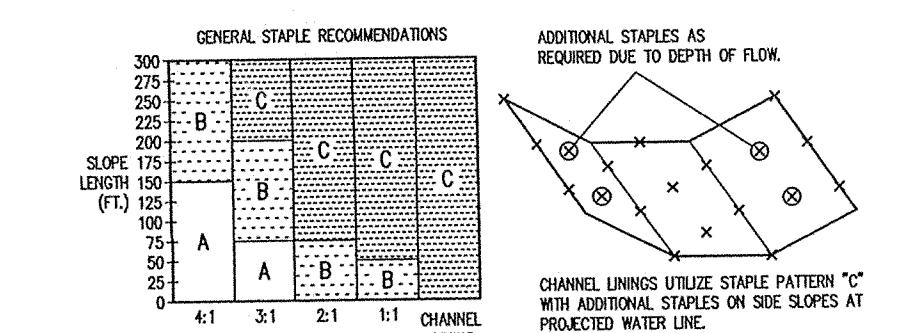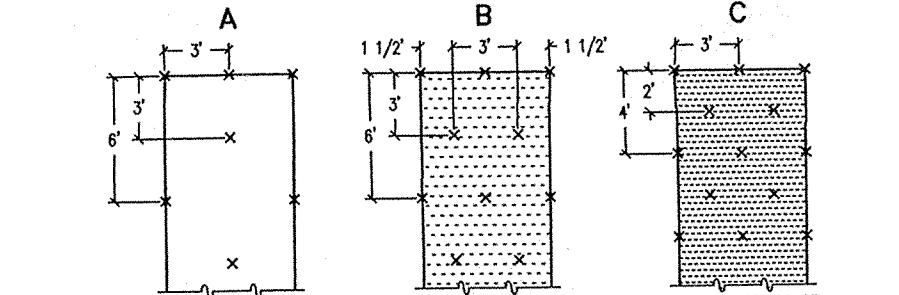

ADDITIONAL STAPLES AS REQUIRED DUE TO DEPTH OF FLOW.

CHANNEL LINING STAPLE PATTERN "C" WITH ADDITIONAL STAPLES AT PROJECTED WATER LINE.

SILT FENCE MATERIAL

GENERAL STAPLE RECOMMENDATIONS

ADDITIONAL STAPLES AS REQUIRED DUE TO DEPTH OF FLOW.

CHANNEL LINING STAPLE PATTERN "C" WITH ADDITIONAL STAPLES AT PROJECTED WATER LINE.

SILT FENCE MATERIAL

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SILT FENCE MATERIAL

GENERAL STAPLE RECOMMENDATIONS

ADDITIONAL STAPLES AS REQUIRED DUE TO DEPTH OF FLOW.

CHANNEL LINING STAPLE PATTERN "C" WITH ADDITIONAL STAPLES AT PROJECTED WATER LINE.

SILT FENCE MATERIAL

## WATER MAINS

### 1. SCOPE OF WORK:

A. The work required under this section includes all cold water distribution lines, valves, hydrants, and related items including excavating and backfilling necessary to complete the work shown on the drawings. The ends of water service lines shall be tightly plugged or capped at the terminal points pending the connecting to of such lines of the building piping as specified in the plumbing specifications and architectural drawings.

### 2. MATERIALS:

A. Cast Iron Pipe: Cast iron pipe shall meet AWWA Specification C-105 with push-on joints meeting AWWA Specification C-111. Wall thickness shall be determined from Table 6.4 in AWWA C-105. Ductile iron pipe shall meet AWWA C-150 and C-151 Specifications. Pipe to be cement lined per AWWA C-104.

B. Copper Tubing: Shall be seamless, annealed copper tubing complying with Federal Specification MW-T-799. Fittings shall be wrought copper or cast bronze with solder joints. Solder shall be of a composition recommended by the manufacturer of the fittings.

C. Fire Hydrants: Shall comply with AWWA Specification C-502 and shall meet local standards and requirements, particularly as to nozzle diameters and threads, direction of opening and dimensions of operating and cap nuts. Fire hydrants shall have one pump and two hose nozzles. A valve opening not less than 5 inches and a 6 inch inlet connection. The length of the hydrant barrel shall be determined by the specified depth of cover over the pipe.

D. Valves: All valves and stops shall have ends mated or adapters shall be provided for the proper installation in the lines in which they are located. Valves shall meet local standards or in the absence of such standards, the following requirements:

1. Valves in cast iron pipe shall be iron body, bronze mounted, disc gate valves conforming to AWWA Specification C-500. They shall open in the same direction as those used in the local waterworks system. Valve stems shall terminate in 2 inch wrench nuts. Furnish two (2) keys.

2. Valves in copper pipe shall be standard brass body, round-way, ground-key stops with T heads. Furnish two (2) keys.

E. Valve Boxes: Shall meet local standards or in the absence of such, shall comply with the following requirements:

1. For iron body valves, boxes shall be approved standard buffallo-type, cast iron, adjustable shaft boxes, having a minimum shaft diameter of 5-1/4 inches.

2. For brass body valves (stops) boxes shall be approved standard cast iron extension service boxes, having a minimum diameter of 2-1/2 inches and having lid held in place by a brass or bronze bolt. The castings shall be coated with two coats of coal-tar pitch varnish. Furnish two (2) keys for bolt in lids.

F. Stops: Stop shall be those manufactured by Ford or Mueller Corporation with AWWA taper thread, and with copper compression type fitting on outlet, or equal.

G. Blow-off Valves: Blow-off valves shall be those manufactured by Mueller Corporation (H-10283 or H-10291), or equal.

H. Angle Valves: Angle valves at the end of water service stub are to be copper compression type fitting, and are to be protected with plastic bag over the valve.

I. Tops: 3/4" tops in lines smaller than 4 inches shall be only by tapped tee or tapping saddle. Water service lines should be marked on curbs with a stamped "W" placed while pouring curbs.

J. APPLICATION:

A. Permits and Codes: The intent of this section is the specifications if that the contractor's bid on the work covered herein shall be based upon the drawings and specifications but that the work shall comply with all applicable codes and regulations. Contractor shall furnish all necessary bonds to get permits for cuts and connections.

B. Existing Improvements: Maintain in operating condition all active utilities and sewers and other pipe system that may be encountered.

C. Trenching: Lay off pipe in open trenches, except when local authority gives written permission for tunneling. Provide a separate trench for the water line of least 10 feet horizontally from any sanitary sewer. In locations where separate trenches for sewer and water lines are impractical lay the water pipe on a solid shelf of least 18 inches above the top of the sewer.

D. Width of Trench: Excavate trenches minimum of pipe diameter plus 12".

E. Shoring and bracing: Sheet and brace trenches as necessary to protect workmen and adjacent structures. All shoring shall comply with the Occupational Safety and Health Administration Standards.

F. Water Removal: Keep trenches free from water while construction therein is in progress. Under no circumstances lay pipe or appurtenances in standing water. Conduct the discharge from trench dewatering to drains or natural drainage channels.

G. Grading Trench Bottoms: The bottom quadrant of the pipe shall be fully and uniformly supported. The full load shall rest on the bore of the pipe. The trench may be excavated to a depth of 4 inches or more below final grade with sand, crushed stone or gravel backfill to bring it back to pipe laying grade. For a depth of least 12 inches above the top of the pipe backfill with earth or granular material free from large stones, roots or frozen clogs. Tamp this backfill thoroughly taking care not to disturb the pipe. Backfill under walks, parking areas, driveways and streets with granular material only and tamp thoroughly, by approved methods. Trenches parallel to and within 10 feet of paved roadways shall be constructed the same.

H. Tests: Before joints are covered, fill the piping with water, opening hydrants or at least two hours at a pressure of 100 pounds per square inch. Inspect all joints for leakage and remedy any leaks. Upon completion of the water distribution mains, flush out the system until the water runs clear. As soon as the system has been flushed out, it shall be sterilized in accordance with the requirements of Hamilton Western Utilities.

I. If a horizontal distance of 10 feet cannot be maintained between the water line and a sanitary sewer line, one of the following shall be done:

a. Water line laid in a separate trench and 18" above sewer.

b. Water line laid in same trench on a bed of undisturbed earth and sewer of least 18" below bottom of water line.

Where water lines and sewer lines cross and the water line cannot be placed above the sewer with a minimum of 18" vertical clearance, the sewer must be constructed of water works grade cast iron pipe with mechanical joints within 10 feet of the water line.

J. Utilities: It shall be the responsibility of each contractor to verify all existing utilities and conditions pertaining to his phase of the work. It shall also be the contractors responsibility to contact the owners of the various utilities before work is started. The contractor shall notify in writing the owners or the engineer of any changes, errors, or omissions found on these plans on in the field before work is started or resumed.

K. New Water Main Construction: Contractor to record dimension of each water stub and valves from nearest fire hydrant measured along water main. The locations of hydrants and water valves, along with any other construction charges are to be incorporated on the original construction drawings and "Record Drawing" prints submitted to Engineer's Office or seen after completion of construction as possible.

Contractor shall submit in his bid the cost of PVC main as well as cost iron.

The following specifications shall apply to the PVC application:

### PVC Water Main Pipe

A. All pipe or fitting joints underground shall be push-on joint or mechanical joint type as noted or equal.

B. Pipe for water mains laid in the trenches shall be PVC (Polyvinyl Chloride) plastic pressure pipe which meets the requirements of ASTM D-1784 for PVC compounds and ASTM D-3139 for push-on joints. The pipe barrel and bell shall be DR18 (dimension ratio). The pipe shall be rated for 150 psi water working pressure and meet all the requirements of AWWA Standard C-900. Pipe shall be Clow Corporation of Oak Brook, Illinois Super Main 900 PVC pipe or equal. Transitions from pipe material to another shall be made using manufacturer's recommended fittings or gaskets.

C. Each length of pipe shall bear the name or trademark of the manufacturer, the location of the plant, and the date of manufacture. Each length shall be marked to designate the class or strength of the pipe. The marking shall be made on the exterior or interior of the pipe barrel near the bell or groove end and shall be plainly visible.

### Fittings and Specs

A. All pipe fittings and specials for trench-lay main using PVC pipe shall be push-on joint ductile cast iron with a pressure rating of 350 psi and conform to ANSI/AWWA-C110/A21.10 and ANSI/AWWA-C111/A21.11 Standards. Fittings shall be Clow Corporation of Oak Brook, Illinois Super Bell-Tite fittings or equal.

### Fitting and Valve Enclosure

A. All iron fittings and valves shall be enclosed with a polyethylene enclosure of a maximum eight (8) mil thickness and conform to ANSI/AWWA-C105/A21.5. Polyethylene encasement shall be Clow Corporation of Oak Brook, Illinois or equal.

### Pipe Tracing Tape


A. All pipe shall be traced with "Terra Tape" by Reel Industries, Inc., P.O. Box 33248, Houston, Texas 77033 or equal. tape shall be "Detectable" type imprinted with "Caution Buried Water Line Below."

### Gate Valves


A. All gate valves shall be iron body, bronze mounted, double disc, parallel seat type gate valves, conforming to AWWA Standard Specifications C500. They shall open in a counter clockwise direction. Valves placed in a valve box shall terminate in 2 inch square operating nut and have non-rising stems. One valve wrench shall be supplied to the Owner for this project. Gate valves shall be as made by Kennedy Valve Manufacturing Co., Inc., Elkhorn, New York, Mueller or equal.

### Valve Boxes




A. Valve boxes shall be a three-piece cast iron type (base, center section, and sliding type adjustable extension) together with a "slay-pul" cover marked "WATER". The base shall be of the size recommended by the manufacturer for the size valve with which it is to be used. Wall thickness of the base and vertical sections shall not be less than 3/16 inch, and each valve box shall have a minimum shaft diameter of 5-1/4 inches.

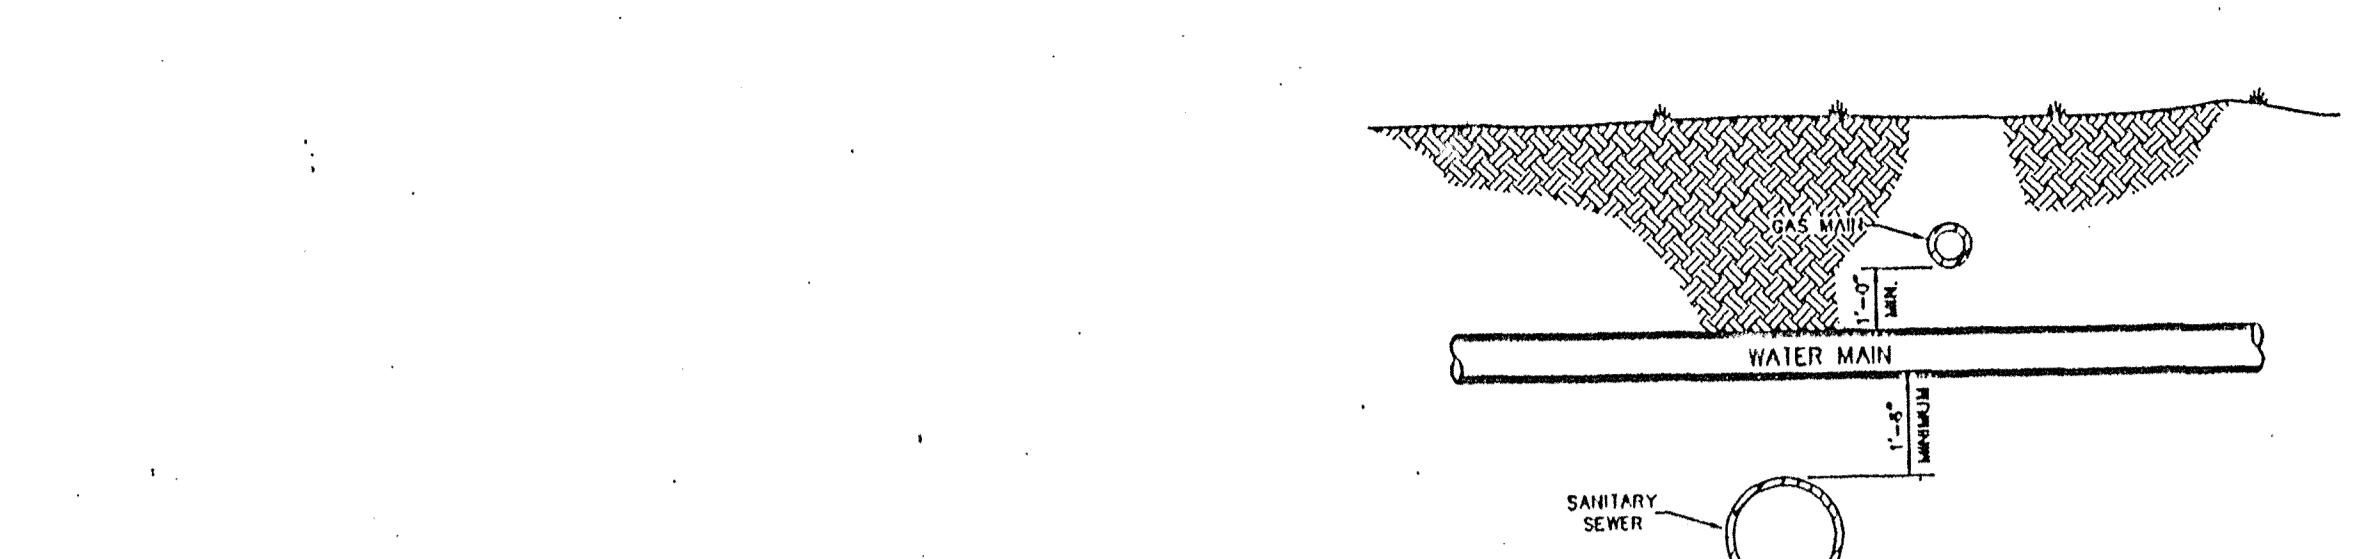


TYPICAL UTILITY CROSSING

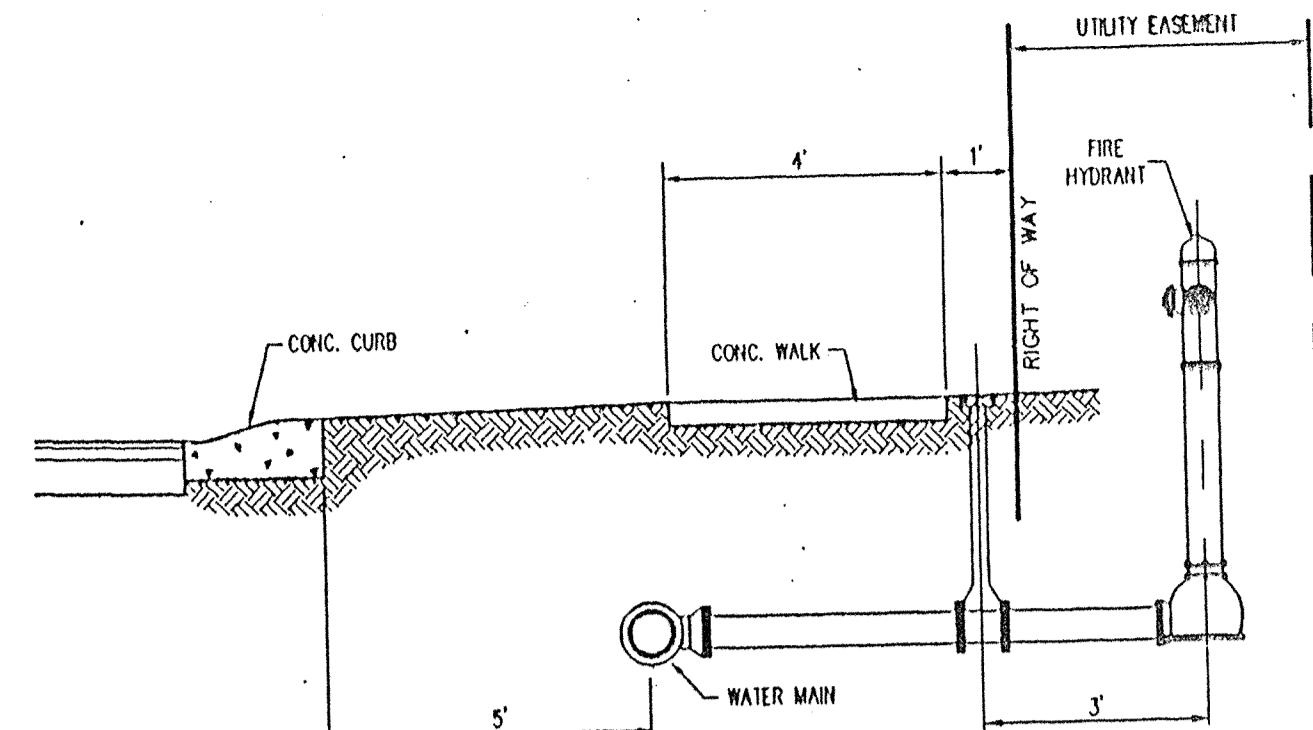


TYPICAL SECTION - HYDRANT & MAIN LOCATION

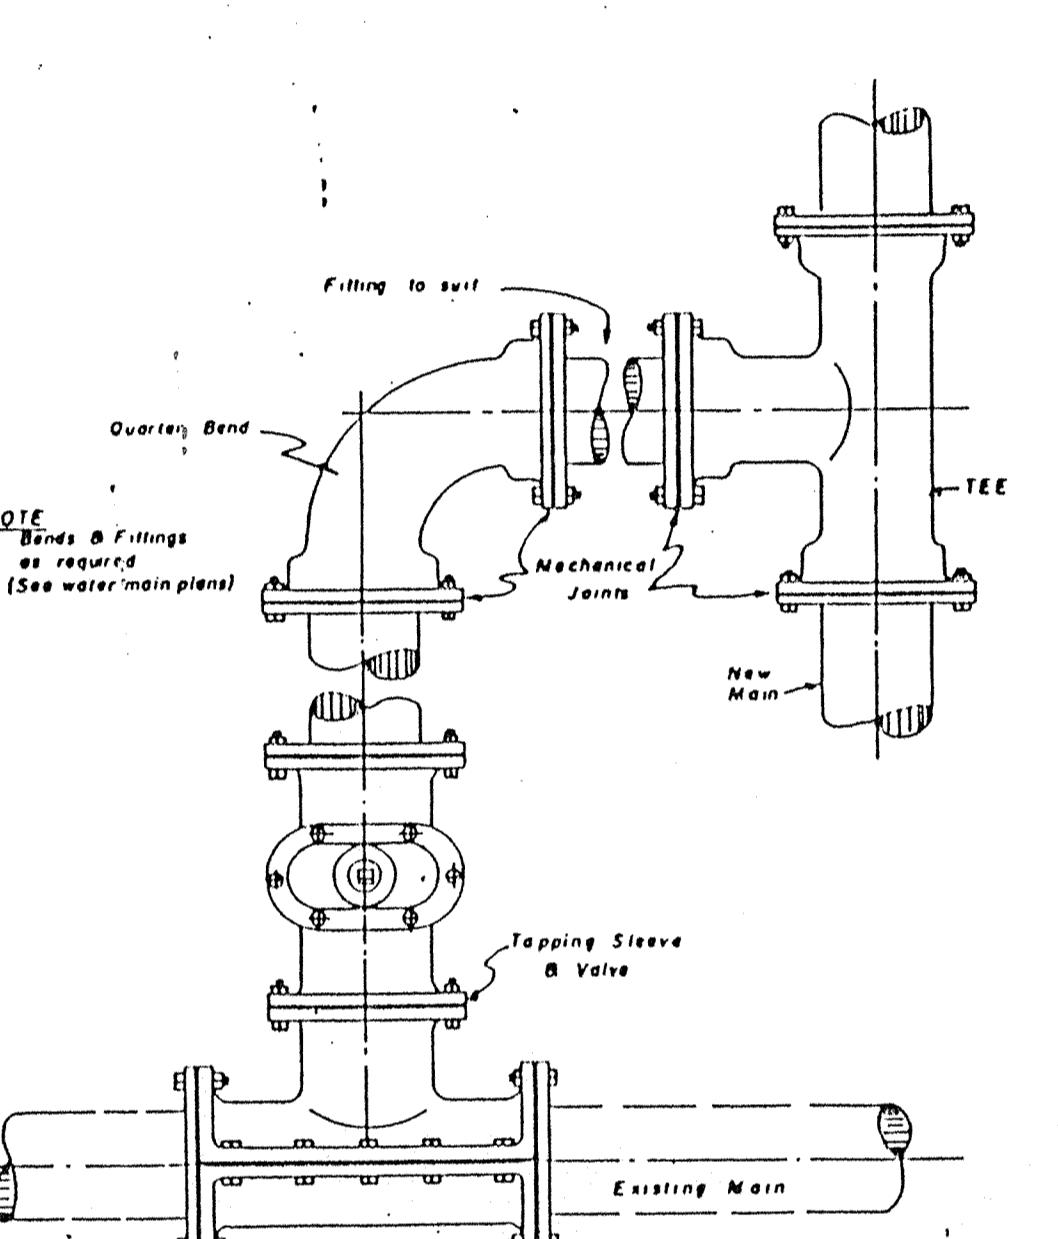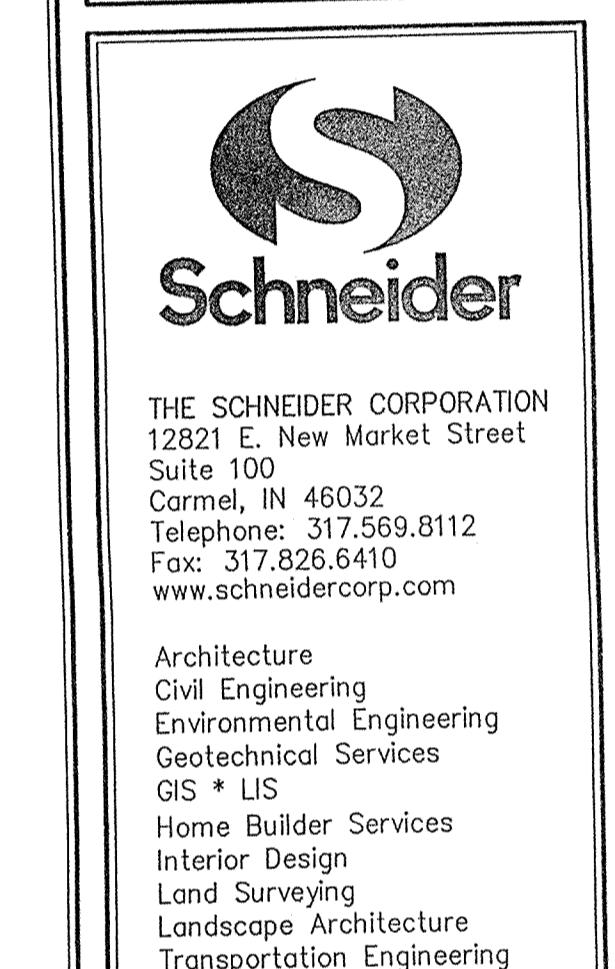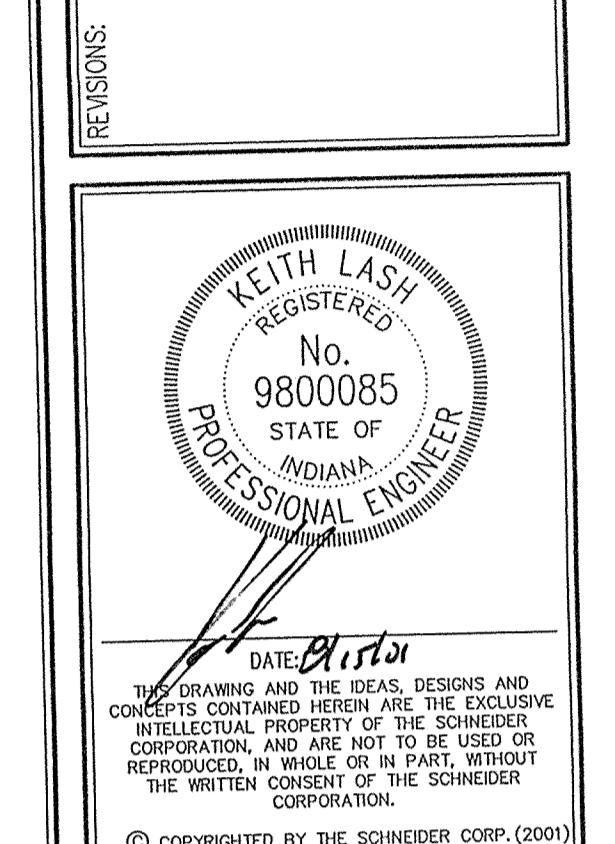


TYPICAL CONNECTION TYPE "A"

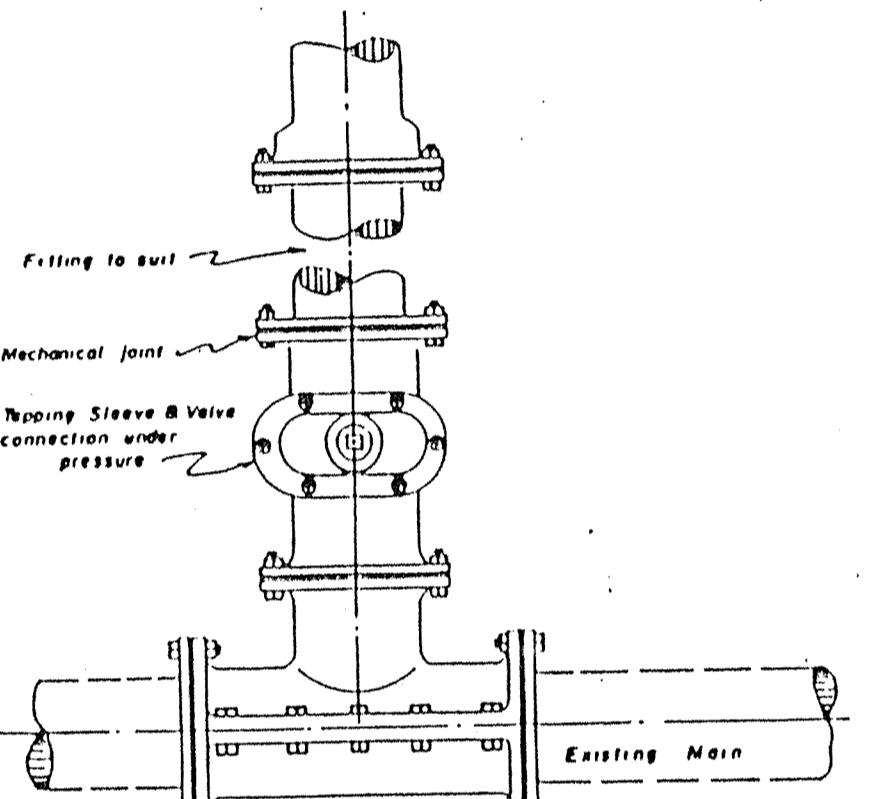


TYPICAL CONNECTION TYPE "B"

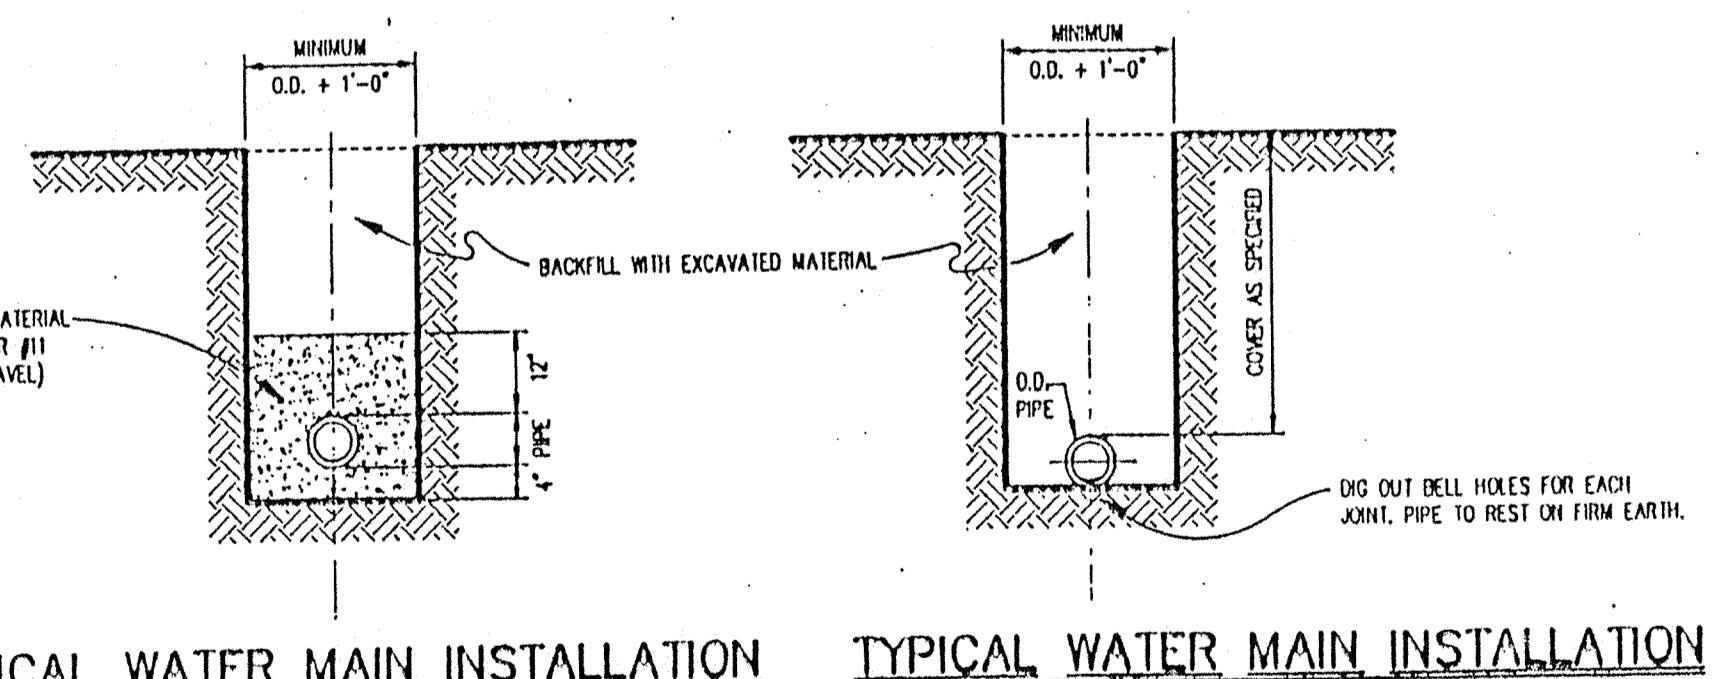

TYPICAL WATER MAIN INSTALLATION  
(FOR PVC PIPE)

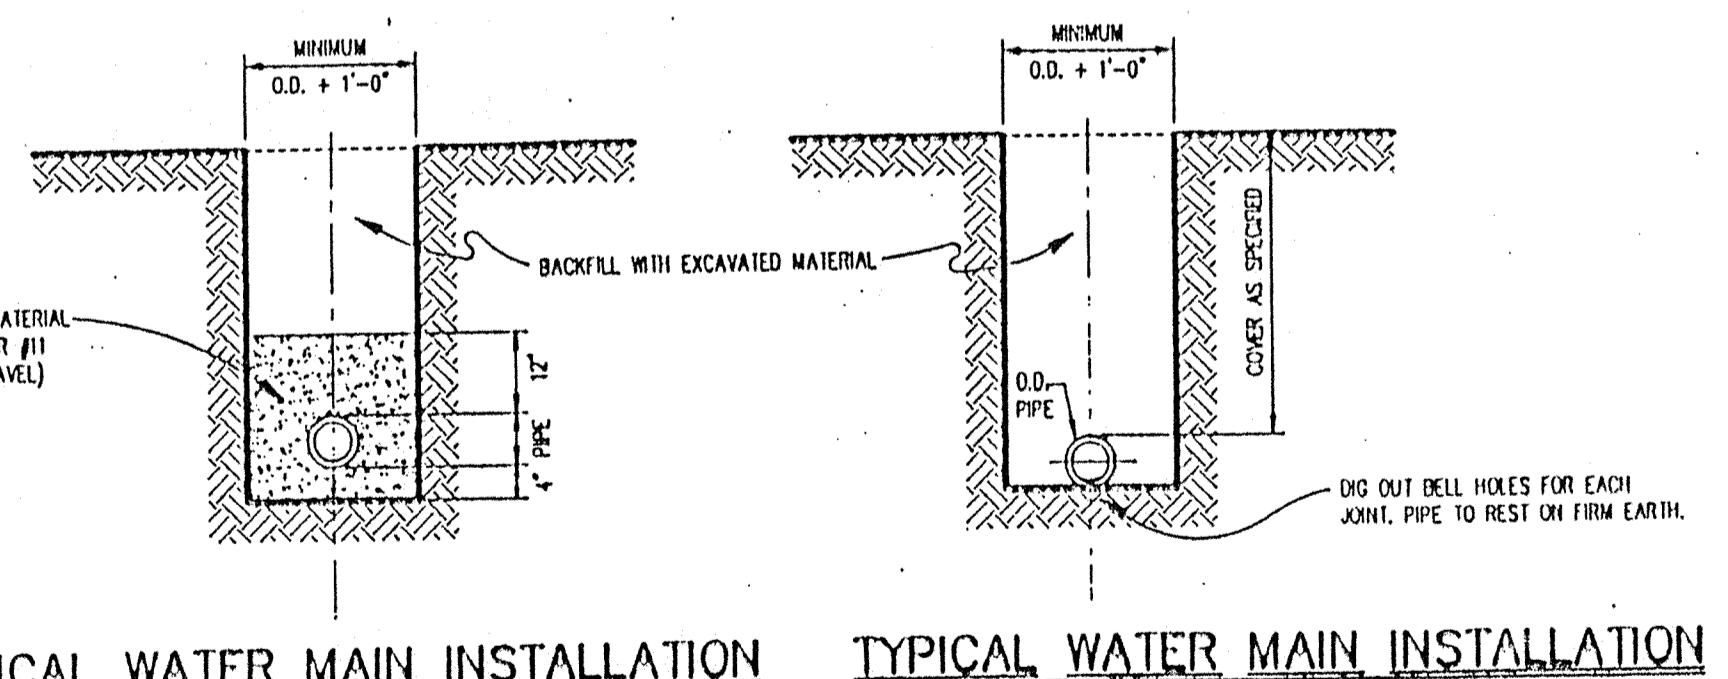

TYPICAL WATER MAIN INSTALLATION  
(FOR DUCTILE IRON PIPE)

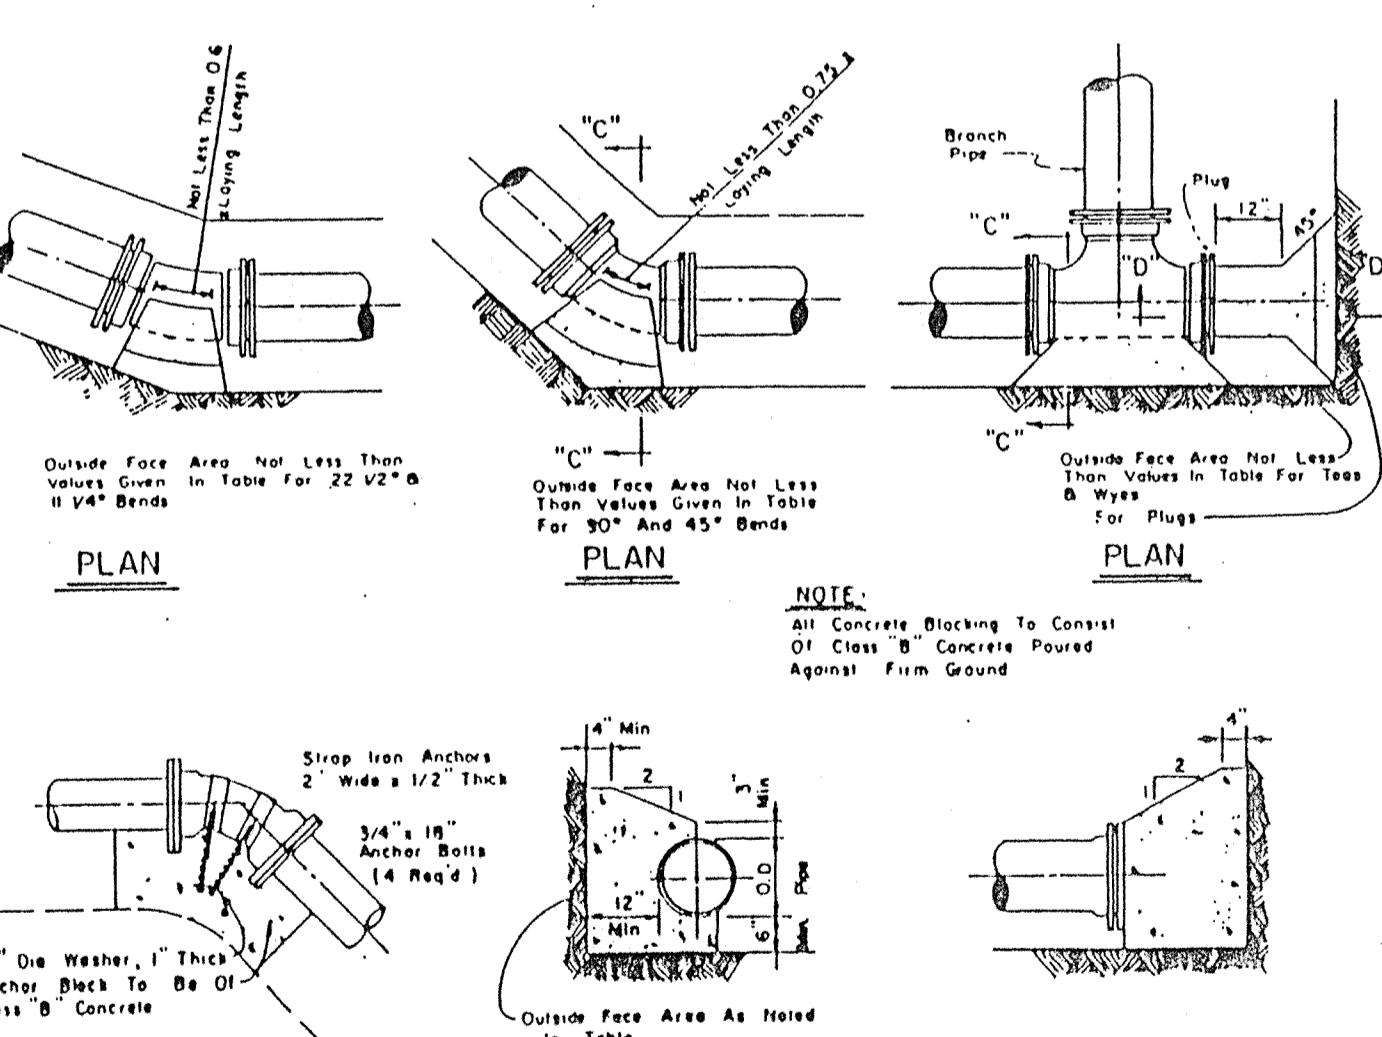

DETAIL - CONCRETE BLOCKING

PIPE SIZE	BLOCKING FOR PLUGS & BENDS		BLOCKING FOR TEES & WYES	
	OUTSIDE FACE AREA (SQ. FT.)	SIZE OF PLUG OR BEND	OUTSIDE FACE AREA (SQ. FT.)	SIZE OF BRANCH
20"	16	23	14	4
16"	12	16	9	3
12"	7	9	5	2
10"	4	7	4	1
8"	3	5	3	1
6"	2	3	2	1
4"	2	3	2	1

DETAIL - CONCRETE BLOCKING

DATE: 8/15/01	PROJECT NO.: 1045.004
DRAWN BY: MG	CHECKED BY:
SHEET TITLE: WATER DETAILS & SPECIFICATIONS	
DRAWING FILES: N:\1045\004\DWGS\1045.DWG	
SHEET NO.: C805	

MERRIMAC SECTION 6  
WESTFIELD, INDIANA  
MERRIMAC CORP.  
CARMEL, INDIANA

FILED  
SEP 12 2001  
OFFICE OF HAMILTON COUNTY SURVEYOR

**EARTHWORK****1. SCOPE OF WORK**

A. Extent: The work required under this section consists of all excavation, filling, rough grading and related items necessary to complete the work indicated on the drawings and described in the specifications. The Contractor shall notify in writing the owners and the Engineer of any changes, errors, or omissions found on the plans or in the field, before work is started or resumed.

1. In general, the items of work to be performed under this section shall include: clearing and grubbing, removal of trees and stumps (where required), protection of trees to remain, stripping and storage of topsoil, fill compaction and rough grading of entire site.
2. Excavated material that is suitable may be used for fills. All unsuitable material and all surplus excavated material not required shall be removed from the site. The location of dump and length of haul shall be the Contractor's responsibility.

3. Provide and place any additional fill material from off the site as may be necessary to produce the grades required. Fill obtained from off site shall be of kind and quality as specified for fills herein and the source approved by the Owner.
4. The Contractor shall accept the site as he finds it and shall remove all trash, rubbish and debris from the site prior to starting excavation.

**B. Work not included:** The following items of related work are specified and included in other sections of these specifications:

1. Excavation, grading and backfilling for utility lines
2. Storm drainage systems
3. Sanitary sewer systems
4. Streets and paving
5. Water supply system

**2. BENCH MARKS**

Maintain carefully all bench marks, monuments and other reference points; if disturbed or destroyed, contractor shall contact engineer.

**3. REMOVAL OF TREES**

- A. Remove all trees and stumps from area to be occupied by road and surfaced areas. Removal of trees outside these areas shall only be done as noted on drawings or approved by the Owner.
- B. All brush, stumps, wood and other refuse from the trees shall be buried onsite or removed to disposal areas off the site. Disposal by burning shall not be permitted unless proper permits are obtained (where applicable). The location of on site bury pits shall be designated by the owner or the Engineer.

**4. PROTECTION OF TREES**

- A. General Protection: The Contractor shall be responsible for the protection of tops, trunks and roots of existing trees on the project site that are to remain. Existing trees subject to construction damage shall be protected, or otherwise protected before any work is started; do not stockpile within branch spread. Remove interfering branches without injury to trunks and cover scars with tree paint.

**5. HANDLING OF TOPSOIL**

- A. Remove all organic material from the areas to be occupied by buildings, roads, walks and parking areas. Plow and store topsoil in areas where it will be re-preserved with construction operations. Topsoil shall be reasonably free from subsoil, debris, weeds, grass, stones, etc.
- B. After completion of site grading and subsurface utility installation, top soil shall be replaced in areas designated on the erosion control plan for seeding and/or sodding. Any remaining top soil shall be used for finished grading around structures and landscaping areas.

**6. DISPOSITION OF UTILITIES:**

- A. Rules and regulations governing the respective utilities shall be observed in executing all work under this section.
- B. If active utilities are encountered but not shown on the drawings, the Engineer shall be advised before work is continued.
- C. Inactive and abandoned utilities encountered in excavating and grading operations shall be reported to the Engineer. They shall be removed, plugged or otherwise protected by the Utility Company and the Engineer.
- D. It shall be the responsibility of each contractor to verify all existing utilities and conditions pertaining to his phase of the work. It shall also be the contractors responsibility to contact the owners and the engineer of any changes, errors, or omissions found on the plans or in the field before work is started.

**7. SITE GRADING:**

- A. Grades: Contractor shall perform all cutting, filling, compacting of fills and rough grading required to bring entire project area to grade as shown on the drawings.
- B. Rough Grading: the tolerance for paved areas shall not exceed 0.10 feet plus or minus above the established subgrade. All other areas shall not exceed 0.10 feet plus or minus the established grade. All cuts and joint breaks in grade shall be rounded at top and bottom.
- C. Compaction Requirements:
  1. All building pad areas shall be compacted to standards specified by local and/or state building codes.
  2. For compaction requirements of paved areas, see street specifications.

**8. EARTH WORK BALANCE**

The Contractor shall confirm all earthwork quantities prior to start of construction. If an excess or shortage of earth is encountered, the Contractor shall confirm with the Owner and Engineer the requirements for stockpiling, removal or importing of earth.

Minor adjustments to the grades may be required to earthwork balances when minor excess material or shortages are encountered. It is recognized by the parties hereto that the calculations of the Engineer in determining earthwork quantities shall be considered correct and shall be used as the Society of Civil Engineers Standards for such calculations.

Further, that these calculations are subject to the interpretations of soil borings as the physical limits of the various soil types, and the allowable variation in material and construction permitted the Contractor, and that all of these parameters may cause either an excess or shortage of actual earthwork materials to complete the project. If such an actual minor excess or shortage of materials occurs, the contractor shall contact the engineer to determine if adjustment can be made to correct the imbalance of earth.

**SANITARY SEWER SYSTEMS****1. SCOPE OF WORK**

The work under this section includes all sanitary sewers, manholes, cleanouts and related items including excavating and backfilling, necessary to complete the work shown in the drawings, starting five feet outside the building walls. The ends of sewer shall be tightly stopped, copper or tenon joints adjacent to buildings pending the connecting of all such lines to the building drain as specified in the plumbing specifications and architectural drawings.

**2. MATERIALS****A. Sanitary Sewers**

1. All gravity plastic sewer pipe and fittings shall conform to ASTM D3034, SDR-35 and meet a cell classification of 1245A B in accordance with ASTM 1784.

**B. Manholes**

1. Precast reinforced concrete manhole sections and steps shall conform to ASTM C-478 latest revision.
2. Copings shall be of uniform quality, free from blow holes, porosity, hard spots, shrinkage distortion or other defects. They shall be smooth and well-cleaned by shot-blasting or by some other approved method. They shall be coated with asphalt paint which shall result in a smooth coating, tough and tenacious when cold, not tacky or brittle. They shall be gray iron meeting ASTM A-48 latest revision. Manhole covers for sanitary sewer shall be Neelhead Type R-1772-A with "I" concealed pinhole.

3. Joints - manhole sections shall be joined with sealed "o" rings. The "o" rings shall meet ASTM C-443 latest revisions.
4. Bismuth coating shall be applied around each manhole joint from 6 inches above to 6 inches below each joint. Inside joints to be filled with precoat plug material.

**3. APPLICATION**

- A. Permits and Codes - The intent of this section of the specifications is that the contractor's bid on the work covered herein shall be based upon the drawings and specifications but that the work shall comply with all applicable codes and regulations as amended by any waivers. Contractor shall furnish all bonds necessary to get permits for cuts and connections to existing sewers.

- B. Local Standards - The term "local standards" as used herein means the standards of design and construction the respective municipal department of utility company.

- C. Existing Improvements - Maintain in operating condition all active utilities, sewers and other drains encountered in the sewer installation. Repair to the satisfaction of the owner any damage to existing active improvements.

- D. Workmanship - To conform to all local, state and national codes and to be approved by all local and state agencies having jurisdiction.

- E. Trenching - Lay all pipe in open trenches, except where the local authority gives written permission for tunneling. Open the trench sufficiently ahead of piping to allow for safe working safety and Health Administration Standards. Keep trenches free from water while construction is in progress. Under no circumstances shall pipe or appurtenances be laid in standing water. Conduct the discharge from trench dewatering to drains or natural drainage channels.

- F. Special Supports - Whenever, in the opinion of the Engineer, the soil or below the pipe grade is unsuitable for supporting sewers and appurtenances, as defined in these specifications, such special support, in addition to those shown or specified, shall be provided as the Engineer may direct, and the contract will be adjusted.

- G. Backfilling - for a depth of at least 12 inches above the top of the pipe, backfill with granular material free from large stones, rock fragments, roots or sod. Compact this backfill thoroughly, taking care not to disturb the pipe or trench walls. Backfill with earth or granular material containing stones or rocks not larger than 4 inches. Backfill under and within 5' of walks, parking areas, driveways and streets shall be granular material only - thoroughly compacted by approved methods.

- H. Flow Channels - The flow channels within manholes shall be an integral part of the precast base. The channels shall be shaped and formed for a clear trench with a precast concrete base, the smooth conveyance of flow through the manhole. The bench wall shall be formed to the crown of the inlet and outlet pipes to form a "U" shaped channel. The bench wall shall slope back from the crown at 1/2 inch per foot to the manhole wall.

- I. Infiltration - The contractor shall furnish necessary equipment to test sewer for infiltration. Infiltration rates shall not exceed the Local Standard. The contractor shall then upon completion be required to pass a low pressure air test, unless otherwise directed by the City of Carmel. Soil test shall be conducted according to NC-1 Standard. Soil test shall be conducted by a lab authorized by the City of Carmel. Infiltration under test shall not exceed 200 gallons per inch of inside diameter of sewer pipe per mile of sewer in 24 hours and inclusive of all appurtenances within the section being tested such as manholes, house connections, etc.

**J. Flushing Sewers**

Flush all sanitary sewers except building sewers with water to obtain free flow through each line. Remove all silt and trash from appurtenances just prior to acceptance of work.

K. Plastic Sewer Pipe Installation - Plastic sewer pipe shall be installed in a accordance with ASTM D2321 per latest revision and no plastic pipe shall exceed a deflection of 5%.

L. Storm Water Connections - No roof drains, footing drains and/or surface water drains may be connected to the sanitary sewer systems, including temporary connections during construction.

M. Waterline Crossing - Where water lines and sanitary sewers cross and water lines cannot be placed above the sewer with a minimum of 18 inches vertical clearance, the sewer shall be constructed of water works grade ductile iron pipe with mechanical joints within 10 feet of the water line.

N. Utilities - It shall be the responsibility of each contractor to verify all existing utilities and conditions pertaining to his phase of the work. It shall also be the contractors responsibility to contact the owners of the various utilities before work is started. The contractor shall notify in writing the owners of the various utilities of any changes, errors, or omissions found on these plans or in the field before work is started or resumed.

O. Service Laterals - Individual lot service lines shall be 6" in diameter and of material equal to that specified in 2A of this section. Service lines shall be connected to the main sewer by a tight fitting copper or tenon tenon joint. Adjacent to buildings pending the connecting of all such lines to the building drain as specified in the plumbing specifications and architectural drawings.

P. New Sanitary Sewer Main Construction - Contractor shall reconstruct the main of each service line stub from nearest downstream manhole measured along the sanitary sewer main. The locations of manholes and service lines along with any other construction changes are to be incorporated on the original construction drawings and "Record Drawing" shall be submitted to the City of Carmel and the engineer as soon after completion of construction as possible.

Q. Sanitary sewer manholes shall be tested in accordance with ASTM C 1244-93, "Standard Test Method for Concrete Sewer Manholes by Negative Air Pressure (Vacuum) Test."

**STORM SEWER SYSTEMS****1. SCOPE OF WORK**

The work required under this section includes all concrete and bituminous paving and related items necessary to complete the work indicated on drawings and described in the specifications, including but not limited to:

- All streets, parking areas in contract limits
- Curbs and gutters
- Sidewalks and concrete slabs, exterior steps

**2. MATERIALS**

- A. Concrete - Concrete shall be ready-mixed concrete and shall be a mix of proportion fine and coarse aggregate with Portland cement and water. Minimum cement content shall be 6 bags per cubic yard of concrete and maximum water content shall be 5.5 gallons per sack of cement, including moisture in the aggregate. Slump for normal weight concrete shall be a maximum of 4 inches and minimum of 2 inches. The slump of machine placed concrete shall be no less than 1-1/4 inches nor more than 3 inches. Standard test ASTM C-143 shall be used to measure slump. Compressive strength of concrete at 28 days shall be 4000 psi. Portland cement concrete with air entrainment of 5% to 8% by volume per ASTM C-260. Retempering of delivered concrete will not be allowed. Concrete shall be composed of:

1. Portland cement - Conforming to ASTM C-150, Type IA or Type IIIA.
2. Aggregates: Conforming to ASTM C-33
3. Water - Shall be clear and free from injurious amounts of oils, acids, alkalies, organic materials or other deleterious substances.

- B. Welded Steel Wire Fabric - Where required for concrete reinforcement shall conform to ASTM A185.
- C. Premoulded Joint Filler - Shall be of non-extruding type meeting ASTM D-544 except that premoulded joint filler used in concrete walk construction may be either non-extruding or resilient.

- D. Bituminous Pavement Materials - All materials proposed for the construction of bituminous pavements shall comply with the Indiana Department of Transportation specifications, per latest revision.

- E. Compacted Aggregate Subbase: Shall be crushed stone or gravel. Crushed gravel shall be a minimum of 35% crushed material. Chert shall be limited to a maximum of 8% of the total. Material shall be free from an excess of flat, elongated, thinly laminated, soft or disintegrated pieces; and shall be free from fragments coated with dirt. Compacted aggregate shall be graded as follows:

SIZE	% PASSING
1-1/2"	100
1"	80-100
3/4"	70-90
1/2"	55-80
#4	35-60
#8	25-50
#16	12-30
#20	5-10

**3. APPLICATION**

- A. Permits and Codes - The intent of this section of the specifications is that the contractor's bid on the work covered herein shall be based upon the drawings and specifications but that the work shall comply with all applicable codes and regulations as amended by any waivers. Contractor shall furnish all bonds necessary to get permits for cuts and connections to existing sewers.

- B. Local Standards - the term "Local Standards" as used herein means the standards of design and construction the respective municipal department of utility company.

- C. Existing Improvements - Maintain in operating condition all active utilities, sewers and other drains encountered in the sewer installation. Repair to the satisfaction of the owner any damage to existing active improvements.

- D. Workmanship - To conform to all local, state and national codes and to be approved by all local and state agencies having jurisdiction.

- E. Trenching - Lay all pipe in open trenches, except where the local authority gives written permission for tunneling. Open the trench sufficiently ahead of piping to allow for safe working safety and Health Administration Standards. Keep trenches free from water while construction is in progress. Under no circumstances shall pipe or appurtenances be laid in standing water. Conduct the discharge from trench dewatering to drains or natural drainage channels.

- F. Special Supports - Whenever, in the opinion of the Engineer, the soil or below the pipe grade is unsuitable for supporting sewers and appurtenances, as defined in these specifications, such special support, in addition to those shown or specified, shall be provided as the Engineer may direct, and the contract will be adjusted.

- G. Backfilling - for a depth of at least 12 inches above the top of the pipe, backfill with granular material free from large stones, rock fragments, roots or sod. Compact this backfill thoroughly, taking care not to disturb the pipe or trench walls. Backfill with earth or granular material containing stones or rocks not larger than 4 inches. Backfill under and within 5' of walks, parking areas, driveways and streets shall be granular material only - thoroughly compacted by approved methods.

- H. Flow Channels - The flow channels within manholes shall be an integral part of the precast base. The channels shall be shaped and formed for a clear trench with a precast concrete base, the smooth conveyance of flow through the manhole. The bench wall shall be formed to the crown of the inlet and outlet pipes to form a "U" shaped channel. The bench wall shall slope back from the crown at 1/2 inch per foot to the manhole wall.

- I. Infiltration - The contractor shall furnish necessary equipment to test sewer for infiltration. Infiltration rates shall not exceed the Local Standard. The contractor shall then upon completion be required to pass a low pressure air test, unless otherwise directed by the City of Carmel. Soil test shall be conducted according to NC-1 Standard. Soil test shall be conducted by a lab authorized by the City of Carmel. Infiltration under test shall not exceed 200 gallons per inch of inside diameter of sewer pipe per mile of sewer in 24 hours and inclusive of all appurtenances within the section being tested such as manholes, house connections, etc.

- J. Flushing Sewers - Flush all sanitary sewers except building sewers with water to obtain free flow through each line. Remove all silt and trash from appurtenances just prior to acceptance of work.

- K. Plastic Sewer Pipe Installation - Plastic sewer pipe shall be installed in a accordance with ASTM D2321 per latest revision and no plastic pipe shall exceed a deflection of 5%.

- L. Storm Water Connections - No roof drains, footing drains and/or surface water drains may be connected to the sanitary sewer systems, including temporary connections during construction.

- M. Waterline Crossing - Where water lines and sanitary sewers cross and water lines cannot be placed above the sewer with a minimum of 18 inches vertical clearance, the sewer shall be constructed of water works grade ductile iron pipe with mechanical joints within 10 feet of the water line.

- N. Utilities - It shall be the responsibility of each contractor to verify all existing utilities and conditions pertaining to his phase of the work. It shall also be the contractors responsibility to contact the owners of the various utilities before work is started. The contractor shall notify in writing the owners of the various utilities of any changes, errors, or omissions found on these plans or in the field before work is started or resumed.

- O. Service Laterals - Individual lot service lines shall be 6" in diameter and of material equal to that specified in 2A of this section. Service lines shall be connected to the main sewer by a tight fitting copper or tenon tenon joint. Adjacent to buildings pending the connecting of