

Drain: LONG BRANCH DRAIN **Drain #:** 331
Improvement/Arm: LONG BRANCH ESTATES - SECTION 1
Operator: JDH **Date:** 3-17-04
Drain Classification: Urban/Rural **Year Installed:** 2001

GIS Drain Input Checklist

- Pull Source Documents for Scanning JDH 3-17
- Digitize & Attribute Tile Drains N/A
- Digitize & Attribute Storm Drains JA 3-17
- Digitize & Attribute SSD JDH 3-22
- Digitize & Attribute Open Ditch JDH 3-20
- Stamp Plans JDH 3-22
- Sum drain lengths & Validate JDH 3-22
- Enter Improvements into Posse JA 3-22
- Enter Drain Age into Posse JDH 3-20
- Sum drain length for Watershed in Posse JDH 3-20
- Check Database entries for errors JDH 3-22

Gasb 34 Footages for Historical Cost
Drain Length Log

Drain-Improvement: Long Branch Drain - Long Branch Est. Sec. 1

Drain Type:	Size:	Length	Length (DB Query)	Length Reconcile	Price:	Cost:
SSD	6"	7072	7072	∅		
RCP	12"	1508	1508	∅		
	15"	795	795	∅		
	18"	485	485	∅		
	21"	879	879	∅		
	24"	1587	1587	∅		
open ditch		240'	240'	∅		

Sum: 12,566 12,564 _____

Final Report: 12,566

Comments:



SURVEYOR'S OFFICE

Hamilton County

Kenton C. Ward, Surveyor

Phone (317) 776-8495

Fax (317) 776-9628

Suite 188

*One Hamilton County Square
Noblesville, Indiana 46060-2230*

December 20, 2001

TO: Hamilton County Drainage Board

RE: Long Branch Drain, Long Branch Estates Section 1 Arm

Attached is a petition, non-enforcement request, plans, calculation, quantity summary and assessment roll for the Long Branch Estates Section 1 Arm, Long Branch Drain. I have reviewed the submittals and petition and have found each to be in proper form.

I have made a personal inspection of the land described in the petition. Upon doing so, I believe that the drain is practicable; will improve the public health; benefit a public highway and be of public utility; and that the costs, damages and expenses of the proposed drain will probably be less than the benefits accruing to the owners of land likely to be benefited. The drain will consist of the following:

6" SSD	7072 ft	21" RCP	866 ft
12" RCP	1512 ft	24" RCP	1696 ft
15" RCP	720 ft	Open Ditch	240 ft
18" RCP	473 ft		

The total length of the drain will be 12,579 feet.

The portion of open ditch listed above is that portion of Long Branch across the North end of the Common Area "A".

The retention ponds (lakes) located in Common Areas "A" and "C: are not to be considered part of the regulated drain. Only the inlet and outlet will be maintained as part of the regulated drain. The maintenance of the ponds (lakes) will be the responsibility of the Homeowners Association. The Board will however, retain jurisdiction for ensuring the storage volume for which the lake was designed will be retained. Therefore, allowing no fill or easement encroachments.

The subsurface drains (SSD) to be part of the regulated drain are those located under the curbs. Only the main SSD lines which are located within the right of way are to be maintained as regulated drain. Laterals for individual lots will not be considered part of the regulated drain.

I have reviewed the plans and believe the drain will benefit each lot equally. Therefore, I recommend each lot be assessed equally. I also believe that no damages will result to landowners by the construction of this drain. I recommend a maintenance assessment of \$10.00 per acre for common areas, \$10.00 per acre for roadways, with a \$65.00 minimum. With this assessment the total annual assessment for this drain/ this section will be \$4,123.20.

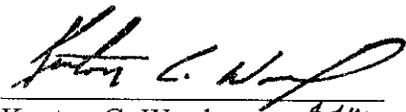
Parcels assessed for this drain may be assessed for the J.W. Brendel Drain at sometime in the future.

I believe this proposed drain meets the requirements for Urban Drain Classification as set out in IC 36-9-27-67 to 69. Therefore, this drain shall be designated as an Urban Drain.

I recommend that upon approval of the above proposed drain that the Board also approve the attached non-enforcement request. This request is for the reduction of the regulated drain easement to those easement widths as shown on the secondary plat for Long Branch Estates Section 1 as recorded in the office of the Hamilton County Recorder.

Offsite easements are to be obtained by the developer from Rene R. and Karen S. Lewin, tract 17-13-06-00-00-011.000 and Mark L. and Tracy A. Shriver, tract 17-13-06-00-00-010.000. These are to be recorded in proper form prior to release of the Performance Bonds for Storm Sewer.

I recommend the Board set a hearing for this proposed drain for January 28, 2002



Kenton C. Ward
Hamilton County Surveyor

KCW/mkh

STATE OF INDIANA)
)
COUNTY OF HAMILTON)

TO: HAMILTON COUNTY DRAINAGE BOARD
% Hamilton County Surveyor, Courthouse, Noblesville, IN 46060

In the matter of Long Branch Estates Subdivision,
Section One Drain Petition.

Petitioner is the owner of all lots in the land affected by the proposed new regulated drain. The drainage will affect various lots in Long Branch Estates, a subdivision in Hamilton County, Indiana. The general route of such drainage shall be in existing easements and along public roads as shown in the plans on file in the Surveyor's Office.

Petitioner believes that the cost, damages and expenses of the proposed improvement will be less than the benefits which will result to the owners of the land likely to be benefited thereby. Petitioner believes the proposed improvements will:

- (a) improve public health
- (b) benefit a public street
- (c) be of public utility

Petitioner agrees to pay the cost of construction of the drainage system and requests periodic maintenance assessments by the Board thereafter.

The Petitioner also agrees to the following:

1. To provide the Drainage Board a Performance Bond for the portion of the drainage system which will be made a regulated drain. The bond will be in the amount of 100% of the Engineers estimate. The bond will be in effect until construction of 100% of the system is completed and so certified by the Engineer.
2. The Petitioner shall retain an Engineer throughout the construction phase. At completion of the project the Petitioner's Engineer shall certify that the drainage system which is to be maintained as a regulated drain has been constructed as per construction plans.

3. The Petitioner agrees to request in writing to the County Surveyor any changes from the approved plan and must receive written authorization from the County Surveyor prior to implementation of the change. All changes shall be documented and given to the Surveyor to be placed in the Drain File.

4. The Petitioner shall instruct his Engineer to provide a reproducible print on a 24" x 36" mylar of the final design of the Drainage System. This shall be submitted to the County Surveyor prior to the release of the Performance Bond.

5. The Petitioner shall comply with the Erosion Control Plan as as specified on the construction plans. Failure to comply with the Erosion Control Plan shall be determined by the Board as being an obstruction to the drainage system. The County Surveyor shall immediately install or repair the needed measures at Petitioners cost as per IC 36-9-27-46.

The Petitioner further requests that the Drain be classified as an Urban Drain.



 Signed

Tim Walter

 Printed Name

 Signed

 Printed Name

RECORDED OWNER(S) OF LAND INVOLVED

Platinum Properties

DATE _____



461

FINDINGS AND ORDER

CONCERNING THE MAINTENANCE OF THE

Long Branch Drain, Long Branch Estates Section 1 Arm

On this *28th day of January 2002*, the Hamilton County Drainage Board has held a hearing on the Maintenance Report and Schedule of Assessments of the *Long Branch Drain, Long Branch Estates Section 1 Arm*.

Evidence has been heard. Objections were presented and considered. The Board then adopted the original/amended Schedule of Assessments. The Board now finds that the annual maintenance assessment will be less than the benefits to the landowners and issues this order declaring that this Maintenance Fund be established.

HAMILTON COUNTY DRAINAGE BOARD

President

A. C. Dilligan

Member

Harold Clark

Member

Attest: *Janette Mastaney*



SUBDIVISION BOND

Bond No.: B21844768

Principal Amount: \$267,500.00

KNOW ALL MEN BY THESE PRESENTS, that we Northside Investments, L.L.C.
as Principal, and Gulf Insurance Company a MO
Corporation, as Surety, are held and firmly bound unto Hamilton County Board of Commissioners,
as Obligee, in the penal sum of Two Hundred Sixty Seven Thousand Five Hundred Dollars
(Dollars) (\$ 267,500.00), lawful money of the
United States of America, for the payment of which well and truly to be made, we bind ourselves, our
heirs, executors, administrators, successors and assigns, jointly and severally, firmly by these presents.

WHEREAS, Northside Investments, L.L.C. has agreed to construct in Long Branch Estates, Section 1
Subdivision, in Indiana the following improvements:

Storm sewers, SSD, Erosion Control and Monumentation at Long Branch Estates, Section 1

NOW, THEREFORE, THE CONDITION OF THIS OBLIGATION IS SUCH, that if the said Principal
shall construct, or have constructed, the improvements herein described, and shall save the Obligee
harmless from any loss, cost or damage by reason of its failure to complete said work, then this obligation
shall be null and void, otherwise to remain in full force and effect, and the Surety, upon receipt of a
resolution of the Obligee indicating that the improvements have not been installed or completed, will
complete the improvements or pay to the Obligee such amount up to the Principal amount of this bond
which will allow the Obligee to complete the improvements.

Upon approval by the Obligee, this instrument may be proportionately reduced as the public
improvements are completed.

Signed, sealed and dated, this 25 day of September, 2001

Northside Investments, L.L.C.
Principal

Gulf Insurance Company
Surety

By: [Signature]

By: [Signature]
Bonnie Kruse Attorney-in-Fact

CERTIFICATE OF COMPLETION AND COMPLIANCE

To: Hamilton County Surveyor

Re: Longbranch Estates Sec. 1 & Sec. 2

I hereby certify that:

1. I am a Registered Land Surveyor or Engineer in the State of Indiana .
2. I am familiar with the plans and specifications for the above referenced subdivision .
3. I have personally observed and supervised the completion of the drainage facilities for the above referenced subdivision .
4. The drainage facilities within the above referenced subdivision to the best of my knowledge , information and belief have been installed and completed in conformity with all plans and specifications .

Signature:  Date: 1/28/03

Type or Print Name: David A. Lach

Business Address: Paul I. Cripe, Inc.

7172 Graham Road, Indianapolis, IN 46250

Telephone Number: (317) 842-6777

SEAL



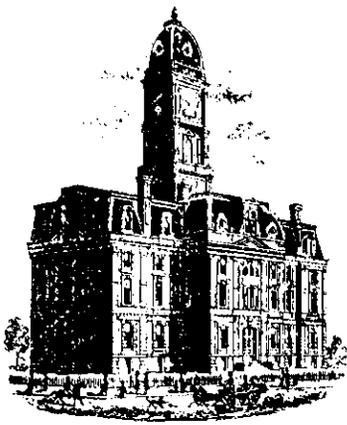
INDIANA REGISTRATION NUMBER

10000126

FILED

JAN 29 2003

OFFICE OF HAMILTON COUNTY SURVEYOR



SURVEYOR'S OFFICE

Hamilton County

Kenton C. Ward, Surveyor

Phone (317) 776-8495

Fax (317) 776-9628

Suite 188

One Hamilton County Square

Noblesville, Indiana 46060-2230

To: Hamilton County Drainage Board

May 10, 2003

Re: Long Branch Estates: Sec. 1 Arm

Attached are as-builts, certificate of completion & compliance, and other information for Long Branch Estates Sec. 1. An inspection of the drainage facilities for this section has been made and the facilities were found to be complete and acceptable.

During construction, changes were made to the drain, which will alter the plans submitted with my report for this drain-dated December 20, 2001. The report was approved by the Board at the hearing held January 28, 2002. (See Drainage Board Minutes Book 6, Pages 252-253)

The changes are as follows:

Structure:	T.C.:	I.E.:	Pipe:	Length:	Grade:	Original:	Difference:
722	899.49	895.64					
721	892.7	889.32	12	211	3	209	2
721	892.7	889.06					
720	893.67	887.72	18	131	1.36		
720	893.67	887.65					
719	893.67	886.99	21	57	1.16	40	17
719	893.67	886.71					
718	893.77	886.44	21	30	0.9		
718	893.77	886.33					
717	884.74	881.34	21	180	2.77		
717	884.74	881.25					
716		880.98	24	92	0.29	93	-1
723	898.2	892.4					
719	893.67	889.05	12	233	1.44		
739	905.38	901.73					
738	905.1	901.14	12	78	0.76		
738	905.1	901.08					
737		899.67	12	161	0.87		
745	904.8	902.11					
744	905.07	901.86	12	33	0.75		
744	905.07	901.86					
743	905.81	901.58	15	40	0.7	38	2
743	905.81	901.54					

742	904.1	899.63	15	122	1.57	126	-4
742	904.1	900.81					
741	904.27	899.63	18	234	0.5	233	1
710	903.17	899.71					
709	903.85	899.57	15	80	0.18	86	-6
709	903.85	8993.45					
708	903.08	897.43	18	90	2.24	79	11
708	903.08	897.28					
708A	902.49	896.89	21	17	2.47	26	-9
708A	902.49	896.74					
707	901.2	895.28	21	86	1.7		
707	901.2	895.17					
706	901.2	894.5	24	279	0.24	278	1
706	901.2	894.5					
705	898.51	892.31	24	193	1.13	195	-2
705	898.51	888.79					
704		880.81	24	207	3.85		
703		879.6					
702	877.58	873.94	15	104	5.44	106	-2
702	877.58	873.94					
701	875.81	872.4	21	106	1.45		
701	875.81	872.3					
700		871.49	24	173	0.46	193	-20
746	903.85	899.99					
709	903.85	898.63	12	87	1.56	93	-6
725		881.7					
*717	884.74	881.45	12	15	1.67	19	-4
741	904.27	899.56					
740		898.95	21	114	0.54	111	3
736	900.66	896.81					
735	900.5	896.32	12	30	1.63		
735	900.5	896.26					
734	901.33	894.93	12	66	2.02	64	2
734	901.33	894.69					
733		893.76	15	168	0.55	163	5
731		893.72					
730	888.18	885.03	24	128	6.79	138	-10
730	888.18	884.93					
729	895.64	884.72	24	56	0.38	55	1
729	895.64	884.6					
728	895.62	884.51	24	30	0.3		
728	895.62	884.39					
727	886.22	881.12	24	171	1.91	166	5
727	886.22	881.06					
726	879.93	876.33	24	211	2.24		
726	879.93	876.28					
726A		875.67	24	47	0.8	80	-33
732	882.21	882.21					

727	886.22	881.67	15	47	1.15	44	3
747	905.11						
748	904.51		12	200			
748	904.51	901.69					
749	906.79	901.24	15	137	0.33		
749	906.79	901.21					
750	907.09	901.08	15	20	0.65		
750	907.09	901.06					
751	907.06	900.9	18	30	0.53		
751	907.06	900.88					
752	905.53	900.45	21	152	0.28		
752	905.53	900.5					
753	903.99	900.27	21	137	0.9	135	2
724	898.04	893.74					
723	898.2	892.5	12	31	4		
713	903.09	898.71					
712	903.08	898.31	12	30	1.33		
712	903.08	898.22					
706	901.2	894.55	12	151	2.43	150	1
715	903.09	895.98					
714	903.09	895.23	12	30	2.5		
714	903.09	898.71					
705	898.51	893.81	12	152	3.22	151	1
748A		902.63					
748	904.51	901.69	15	77	1.22		77

The length of the drain due to the changes described above is now **12566 feet**.

The non-enforcement was approved by the Board at its meeting on January 28, 2002 and recorded under instrument #200200027370.

The following sureties were guaranteed by Gulf Insurance Company and released by the Board on its January 27, 2003 meeting.

Bond-LC No: B21844768

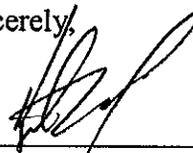
Insured For: Storm Sewers, Erosion Control, Monuments

Amount: \$267,500

Issue Date: September 25, 2001

I recommend the Board approve the drain's construction as complete and acceptable.

Sincerely,



Kenton C. Ward,
Hamilton County Surveyor

GRADING NOTES

1. ALL GRADES AT BOUNDARY SHALL MEET EXISTING GRADES.
2. ALL TOPSOIL SHALL BE PLACED IN NONSTRUCTURAL FILL AREAS. UPON COMPLETION OF MASS EARTHWORK, TOPSOIL SHALL BE SPREAD TO A DEPTH OF FOUR TO SIX (4 TO 6) INCHES IN AREAS TO BE SEEDS SUCH AS LAKE SLOPES, MOUND AREAS, AREAS BETWEEN CURBS AND CLEARING LIMITS, AND ALL DISTURBED AREAS OUTSIDE OF BUILDING AND PARKING AREAS. TOPSOIL MATERIAL SHALL BE ROCK-PICKED TO REMOVE ALL FOREIGN MATERIAL LARGER THAN 1 1/2" IN ANY DIRECTION.
3. STRAW BALE DAMS, SEDIMENT PITS AND SILT FENCES SHALL BE UTILIZED TO CONTROL EROSION. SEE EROSION CONTROL PLAN FOR ADDITIONAL INFORMATION.
4. EXISTING UTILITY LOCATIONS ARE APPROXIMATE. CONTRACTOR TO FIELD VERIFY HORIZONTAL AND VERTICAL LOCATIONS PRIOR TO MAJOR EARTHWORK, WITHIN THE PROPOSED CONSTRUCTION LIMITS.
5. SEE STREET PLAN & PROFILE SHEETS FOR ADDITIONAL GRADES ON STREET.
6. THE INTENT OF THESE PLANS IS TO USE ALL EXCESS FILL MATERIAL ON-SITE. BORROW PITS IN NONSTRUCTURAL FILL AREAS MAY BE UTILIZED TO OBTAIN SUITABLE FILL MATERIAL AND TO DISPOSE OF TOPSOIL.
7. BUILDING PAD AREAS AND STREETS DESIGNATED FOR FILL SHALL BE CONSTRUCTED OF SUITABLE FILL MATERIAL AND COMPACTED PER SPECIFICATIONS. ALL FILL AREAS FOR BUILDING AREAS AND STREETS ARE TO BE STRIPPED OF TOPSOIL PRIOR TO PLACEMENT OF FILL.
8. CONTRACTOR SHALL PRESERVE EXISTING TREES WHEREVER POSSIBLE. OWNER AND OWNER'S REPRESENTATIVE SHALL BE CONSULTED FOR CLEARING LIMITS. CLEARING LIMITS SHALL CONSIST OF ALL TREES WITHIN STREET AREAS, UTILITY INSTALLATION LIMITS AND CUT FILL AREAS.
9. EARTHWORK BALANCE - THE CONTRACTOR SHALL CONFIRM ALL EARTHWORK QUANTITIES PRIOR TO START OF CONSTRUCTION. IF AN EXCESS OR SHORTAGE OF EARTH IS ENCOUNTERED, THE CONTRACTOR SHALL CONFIRM WITH THE OWNER AND THE ENGINEER THE REQUIREMENTS FOR STOCKPILING, REMOVAL OR IMPORTING OF EARTH.
10. MINOR ADJUSTMENTS TO THE GRADES MAY BE REQUIRED TO OBTAIN EARTHWORK BALANCES WHEN MINOR EXCESS MATERIAL OR SHORTAGES ARE ENCOUNTERED. IT IS RECOGNIZED BY THE PARTIES HERETO THAT THE CALCULATIONS OF THE ENGINEER IN DETERMINING EARTHWORK QUANTITIES SHALL BE ACCOMPLISHED IN ACCORDANCE WITH THE AMERICAN SOCIETY OF CIVIL ENGINEERS STANDARDS FOR SUCH CALCULATIONS. FURTHER, THAT THESE CALCULATIONS ARE SUBJECT TO THE INTERPRETATIONS OF SOIL BORINGS AS THE PHYSICAL LIMITS OF THE VARIOUS SOIL TYPES ALSO ALLOWABLE VARIATION IN FINISH GRADE AND PARAMETERS MAY CAUSE EITHER AN EXCESS OR SHORTAGE OF ACTUAL EARTHWORK MATERIALS TO COMPLETE THE PROJECT. IF SUCH AN ACTUAL MINOR EXCESS OR SHORTAGE OF MATERIALS OCCURS, THE CONTRACTOR SHALL CONTACT THE ENGINEER TO DETERMINE IF ADJUSTMENTS CAN BE MADE TO CORRECT THE IMBALANCE OF EARTH.

12. SPOT ELEVATIONS - IF DURING THE CONSTRUCTION OR SURVEY LAYOUT PROCESS IT IS DETERMINED THAT THERE ARE INSUFFICIENT SPOT ELEVATIONS TO PROPERLY CONSTRUCT THE PROJECT OR THE DESIGN GRADES APPEAR TO BE TOO STEEP OR FLAT FOR ON-SITE CONDITIONS, THE CONTRACTOR SHALL CONTACT THE ENGINEER IMMEDIATELY TO ADJUST OR ADD ADDITIONAL ELEVATIONS AS REQUIRED.
13. THE FINISHED GRADE ELEVATION ADJACENT TO THE BUILDING, TEN (10) FEET AWAY FROM THE BUILDING SHALL BE SIX (6) INCHES LESS THAN THE MPE TO INSURE PROPER DRAINAGE AWAY FROM THE BUILDING. ELEVATIONS AT THE SIDE WALKS PROXIES FOR PROPER DRAINAGE TO THE STREET OR YARD SWALES. IT IS IMPORTANT THAT THESE ELEVATIONS BE PROPERLY CONSTRUCTED AND MAINTAINED FOR PROPER DRAINAGE. PAUL I. CRPE, INC. WILL NOT BE RESPONSIBLE FOR INADEQUATE CONSTRUCTION OR MAINTENANCE OF GRADES AS SHOWN ON THESE PLANS.
14. ALL DEBRIS AND OBSTRUCTIONS MUST BE REMOVED FROM TOP OF BANK TO TOP OF BANK ALONG LONG BRANCH CREEK DURING CONSTRUCTION OF SECTION THREE. FINAL DETERMINATION OF CLEARING LIMITS TO BE MADE IN THE FIELD BY THE INSPECTOR.

THIS ENGINEERED SITE PLAN DOES DISCLOSE THE REQUIRED 100 YEAR FLOOD ELEVATION OR NEILAND RESTRICTIONS IN COMPLIANCE WITH REQUIREMENTS OF THE INDIANA DEPARTMENT OF NATURAL RESOURCES (DNR), THE U.S. ARMY CORPS OF ENGINEERS OR THE FLOOD INSURANCE RATE MAPS (FIRM). THE LOT OWNER OR HIS ENGINEER SHOULD CONSULT THESE SOURCES BEFORE PREPARING SPECIFIC SITE PLANS RELATING TO BUILDING IMPROVEMENTS.

THE HOMEOWNER, BUILDER OR HIS REPRESENTATIVE MUST HAVE A FLOOD HAZARD ZONE MAP AND SEALED BY A PROFESSIONAL ENGINEER THAT MEETS ALL THE REQUIREMENTS OF THE PLANNING JURISDICTIONS, FEDERAL AND STATE REQUIREMENTS, LOCAL UTILITIES, COVENANTS AND ANY OTHER ENCUMBRANCES. THIS PLAN, AMONG OTHER ITEMS, SHALL CONSIDER FLOOR LEVELS, STORM ROUTINGS, AND MINIMUM FLOOR ELEVATIONS. GRAVITY SEWER SHALL NOT BE CONSIDERED FOR LOWER LEVELS. PAUL I. CRPE, INC. SHALL BE HELD HARMLESS IF THESE REQUIREMENTS ARE NOT MET.

ANY CONSTRUCTION BELOW THE 100 YEAR FLOOD ZONE "A" REQUIRES PERMIT FROM FEDERAL EMERGENCY MANAGEMENT AGENCY (FEMA). ANY CONSTRUCTION IN FLOODWAY REQUIRES PERMIT FROM INDIANA DEPARTMENT OF NATURAL RESOURCES (DNR). IT SHALL BE THE RESPONSIBILITY OF THE CONTRACTOR TO COMPLY WITH THE ABOVE STATED REQUIREMENTS

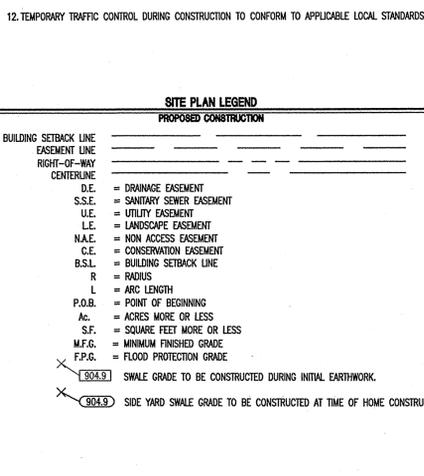
BENCHMARK
PROJECT BENCHMARK
 U.S.C.G.S. standard disk (stamped "R78 1946") set in the top of the center of the northeast headwall of a three foot concrete box culvert located 0.25 miles northwest of the intersection of U.S. 421 and 116th Street and twenty-six feet northwest of the center of U.S. 421. ELEVATION = 885.18 (NGVD 1929)
TEMPORARY BENCHMARK
 Large hinge nail in the east side of PWP#78-250 located on the west side of Shelburne Road just south of a large culvert and 1000 feet north of the intersection of 116th Street and Shelburne Road. ELEVATION = 891.18

- UTILITY PLAN NOTES**
1. WATER LINES THROUGHOUT THE PROJECT SHALL BE INSTALLED WITH AT LEAST 54 INCHES OF COVER TO PROVIDE PROTECTION FROM FREEZING.
 2. LOCATIONS OF EXISTING UNDERGROUND UTILITY LOCATIONS ARE APPROXIMATE. THE CONTRACTOR IS TO FIELD VERIFY ALL HORIZONTAL AND VERTICAL LOCATIONS PRIOR TO CONSTRUCTION.
 3. PLASTIC WATER LINES ARE TO BEAR THE NSF SEAL OF APPROVAL AND MEET COMMERCIAL STANDARD NO. 256-3, PRODUCT STANDARD 22-70, OR ASTM D 2441.
 4. SEE SHEET C707 FOR STORM SEWER DETAILS, SEE SHEET C708 FOR STORM STRUCTURE AND PIPE DATA TABLES.
 5. SEE SHEET C508 FOR SANITARY SEWER DETAILS.
 6. SEE SHEETS C901 AND C902 FOR ALL OTHER DETAILS.
 7. WATER AND SEWER CROSSINGS SHALL BE IN ACCORDANCE WITH "TEN STATE STANDARDS" AND LOCAL CODES.
 8. BEARINGS, DIMENSIONS AND EASEMENTS ARE SHOWN FOR REFERENCE ONLY. SEE RECORD SURVEYS AND PLATS FOR EXACT INFORMATION.



SITE WORK GENERAL NOTES AND SPECIFICATIONS
NOTICES AND PERMITS

1. THE CONTRACTOR SHALL BE RESPONSIBLE FOR OBTAINING, OR VERIFYING, THAT ALL PERMITS AND APPROVALS ARE OBTAINED FROM THE RESPECTIVE CITY, COUNTY AND STATE AGENCIES PRIOR TO STARTING CONSTRUCTION.
2. IT SHALL BE THE CONTRACTORS RESPONSIBILITY TO DETERMINE THE EXACT LOCATION OF ALL EXISTING UTILITIES IN THE VICINITY OF THE CONSTRUCTION AREA PRIOR TO STARTING CONSTRUCTION.
3. IT SHALL BE THE CONTRACTORS RESPONSIBILITY FOR NOTIFICATION AND COORDINATION OF ALL CONSTRUCTION WITH RESPECTIVE UTILITY COMPANIES.
4. IT SHALL BE THE RESPONSIBILITY OF THE DEVELOPER AND CONTRACTOR TO MAINTAIN QUALITY CONTROL THROUGHOUT THE PROJECT, FAILURE TO DO SO MAY RESULT IN REMOVAL AND REPLACEMENT OF THE DEFECTIVE WORK. IT IS RECOMMENDED THAT THE DEVELOPER HAVE A QUALIFIED INSPECTOR ON THE JOB SITE AT ALL TIMES DURING CONSTRUCTION.
5. IT IS ESSENTIAL THAT THE WORK TO BE DONE IN CONJUNCTION WITH THIS PROJECT SHALL BE INSTALLED ACCORDING TO THESE SPECIFICATIONS. THE ENGINEER WILL BE REQUIRED TO CERTIFY TO CERTAIN PORTIONS OF THIS PROJECT UPON COMPLETION. THEREFORE, IT IS NECESSARY TO OBTAIN APPROVAL AND ACCEPTANCE BY THE CITY THAT CONSTRUCTION WAS DONE IN COMPLIANCE WITH THESE PLANS AND SPECIFICATIONS.
6. ALL QUANTITIES GIVEN ON THE PRINTS, VERBALLY OR IN THE SCOPE OF WORK SECTION ARE ESTIMATES AND SHALL BE CONFIRMED BY THE BIDDING CONTRACTOR.
7. OCCUPATIONAL SAFETY AND HEALTH ADMINISTRATION (OSHA) STANDARDS FOR EXCAVATIONS, FINAL RULE 29 CFR 1926, SUBPART "P" APPLIES TO ALL EXCAVATIONS EXCEEDING FIVE (5) FEET IN DEPTH.
8. EXCAVATIONS EXCEEDING TWENTY (20) FEET IN DEPTH REQUIRE THE DESIGN OF A TRENCH SAFETY SYSTEM BY A REGISTERED PROFESSIONAL ENGINEER.
9. LOCATIONS & ELEVATIONS OF "FLOODWAY LIMITS" AND "100 YEAR FLOOD LIMITS" ARE SHOWN FOR REFERENCE ONLY. DEVELOPER/BUILDER/INDIVIDUAL LOT OWNER TO REFER TO NATIONAL FLOOD HAZARD INSURANCE MAP (F.E.M.A.) TO DETERMINE FLOOD HAZARD POTENTIAL PRIOR TO INDIVIDUAL LOT/PROJECT CONSTRUCTION.
10. ALL RADIUS AND STREET DIMENSIONS SHALL BE MEASURED TO BACK OF CURB OR FACE OF INTEGRAL CURB AND WALK.
11. BEARINGS, DIMENSIONS AND EASEMENTS ARE SHOWN FOR REFERENCE ONLY. SEE RECORD SURVEYS AND PLATS FOR EXACT INFORMATION.

UTILITY PLAN LEGEND



UTILITY PLAN LEGEND

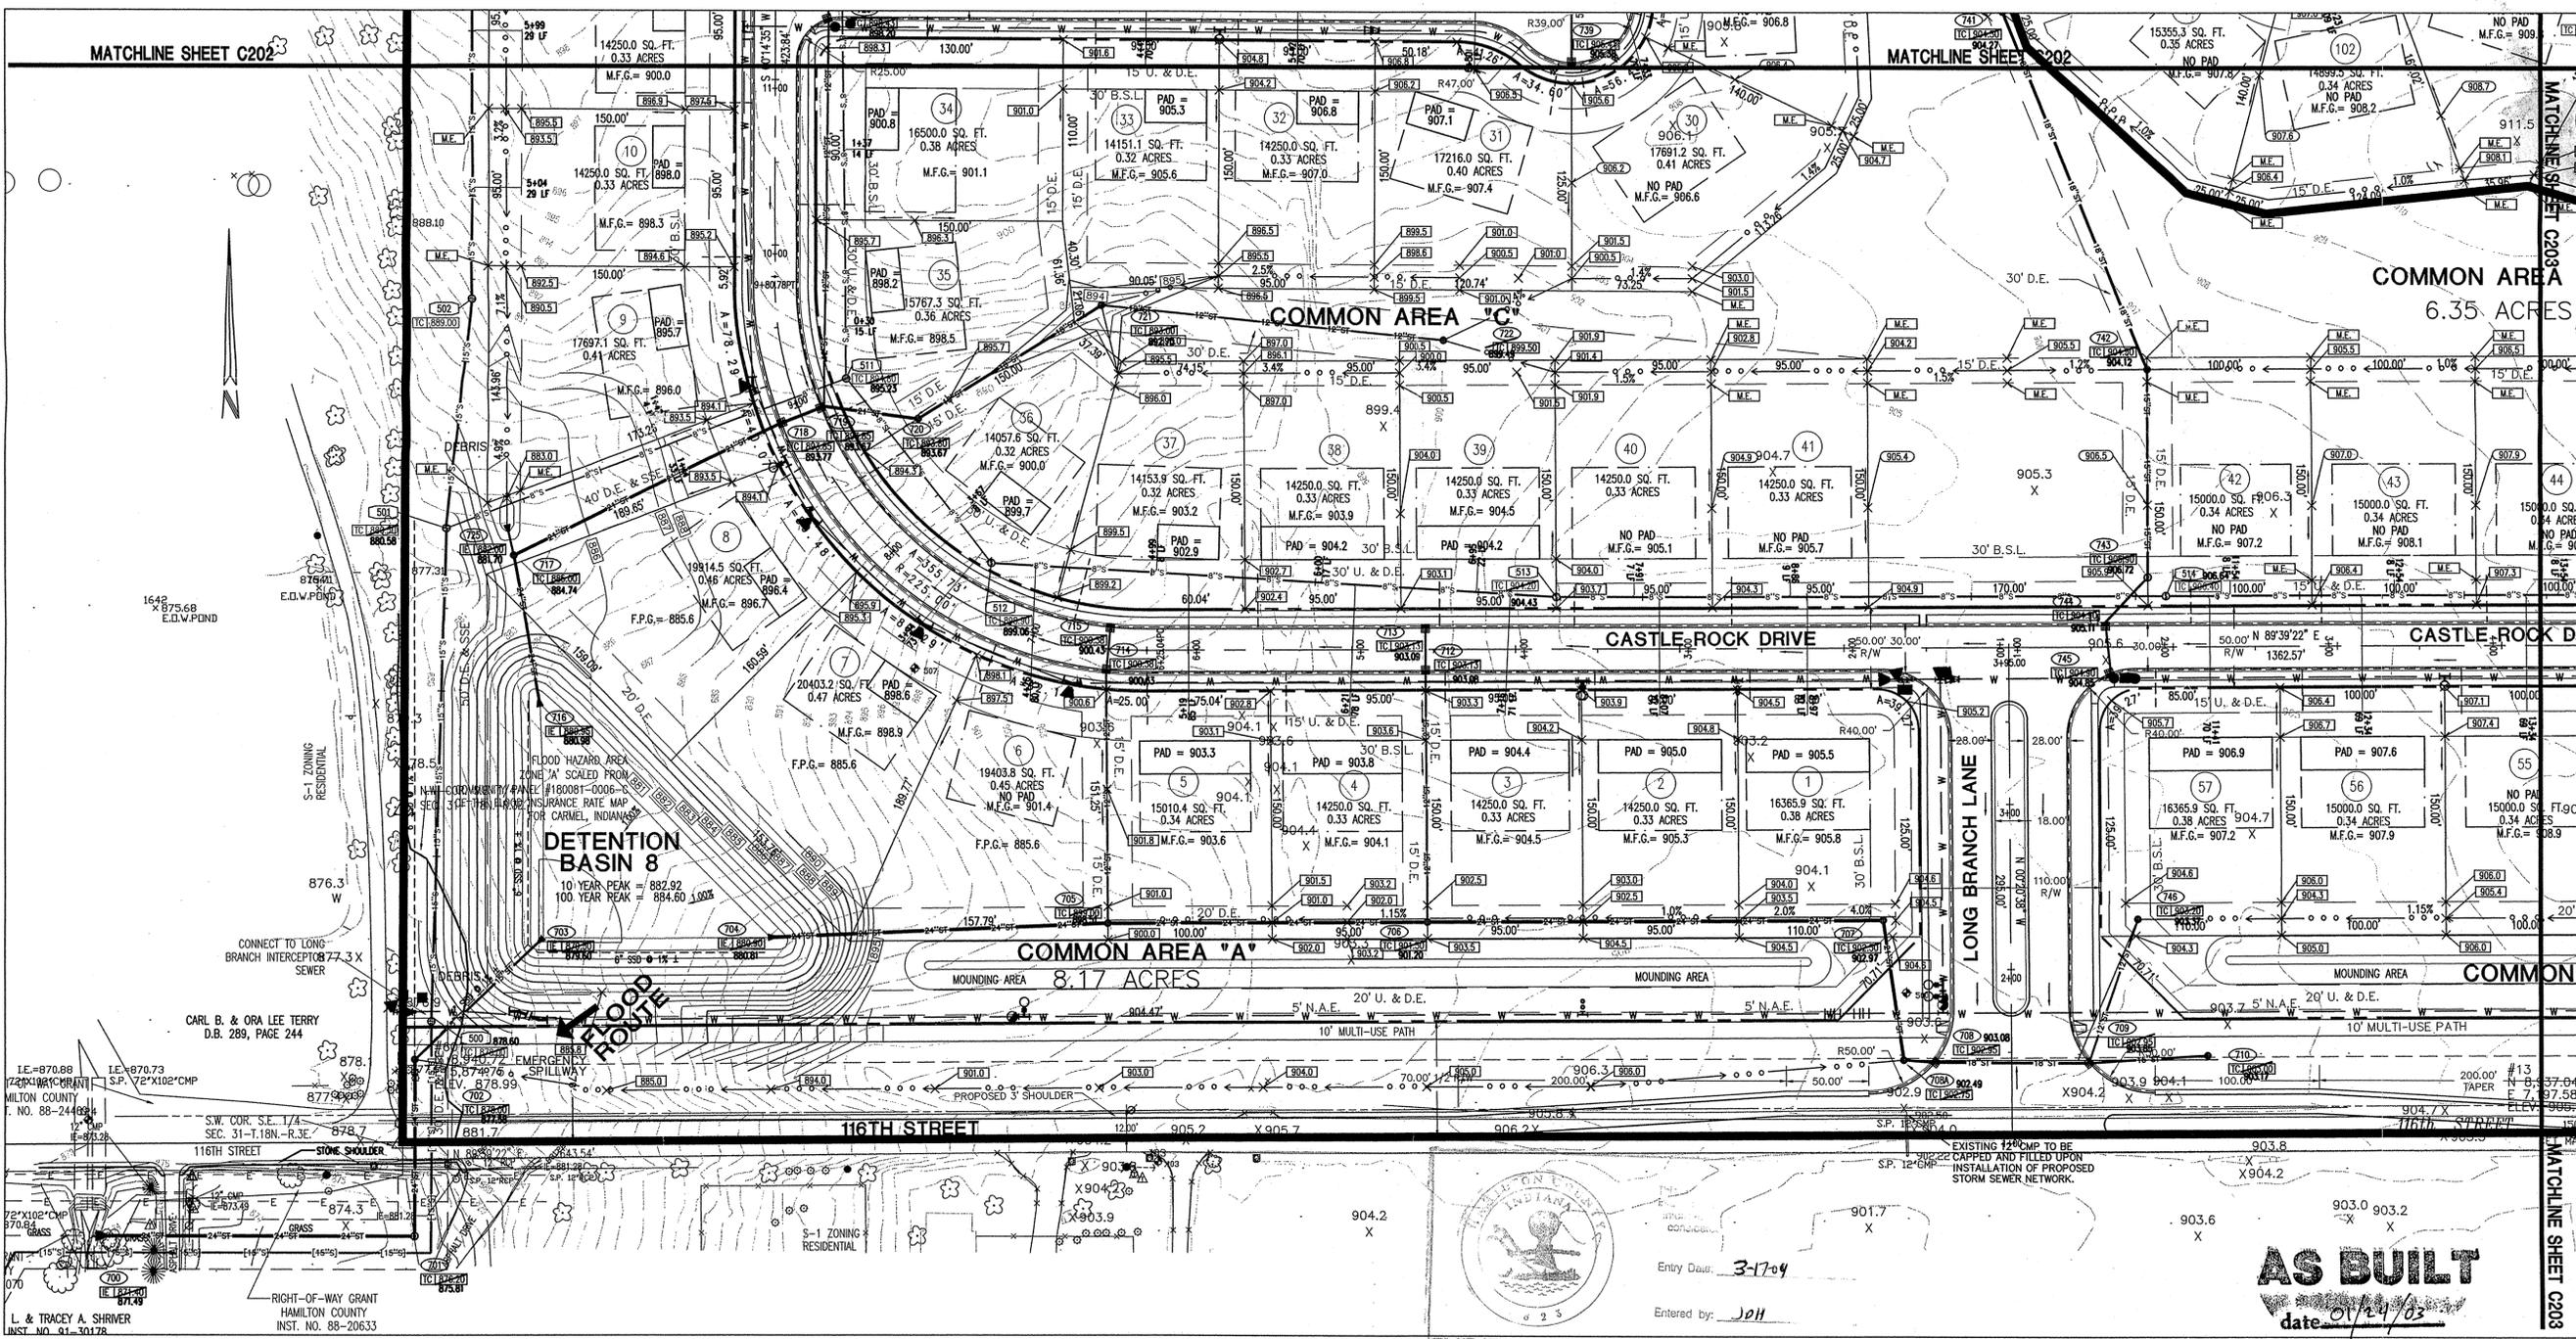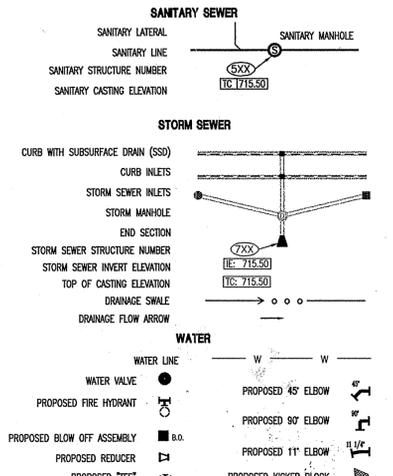

Revision	Date	Description
1	09/24/01	REVISIONS PER TIC AND OWNER COMMENTS.
2	09/24/01	REVISIONS PER TIC COMMENTS.
3	10/17/01	REVISIONS PER TIC COMMENTS.
4	10/19/01	REVISIONS PER HAM CO. SURVEYOR COMMENTS.
5	12/04/01	REVISIONS PER HAM CO. SURVEYOR COMMENTS.

7172 GRAHAM ROAD
 INDIANAPOLIS, INDIANA 46250
 842-6777 FAX (317) 841-4798
 E-Mail: picrpe@picrpe.com

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ARCHITECTURE
 CIVIL ENGINEERS
 LANDSCAPE ARCHITECTURE
 LAND SURVEYORS
 ENVIRONMENTAL CONSULTANTS
 PROFESSIONAL ENGINEERS
 GIS

SITE DEVELOPMENT PLAN
LONG BRANCH ESTATES SECTIONS I AND II
PLATINUM PROPERTIES, LLC.
 9551 DELEGATES ROW
 INDIANAPOLIS, INDIANA 46240

PE 10000126
 STATE OF INDIANA
 REGISTERED PROFESSIONAL ENGINEER

Drawn by: CH/FR
 Checked by: GM
 Quality Assurance: DL

Scale: $1" = 50'$
 Sheet: **C201**
 Date: 11/28/01
 Project Number: 980401-20200

AS BUILT
 date 01/24/03

SEE SHEET C201 FOR ALL SITE AND UTILITY PLAN NOTES
 SEE SHEET C207 FOR STORM SEWER DETAILS
 SEE SHEET C208 FOR STORM STRUCTURE AND PIPE DATA TABLES.

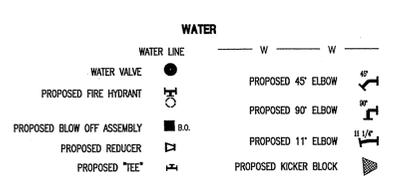
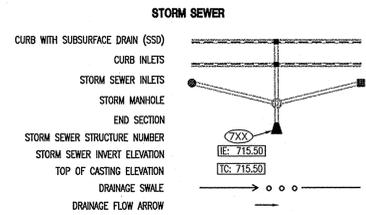
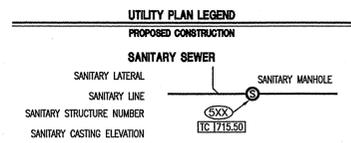
SITE PLAN LEGEND

PROPOSED CONSTRUCTION

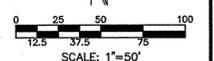
BUILDING SETBACK LINE
 EASEMENT LINE
 RIGHT-OF-WAY
 CENTERLINE

D.E. = DRAINAGE EASEMENT
 S.S.E. = SANITARY SEWER EASEMENT
 U.E. = UTILITY EASEMENT
 L.E. = LANDSCAPE EASEMENT
 N.A.E. = NON ACCESS EASEMENT
 C.E. = CONSERVATION EASEMENT
 B.S.L. = BUILDING SETBACK LINE
 R = RADIUS
 L = ARC LENGTH
 P.O.B. = POINT OF BEGINNING
 Ac. = ACRES MORE OR LESS
 S.F. = SQUARE FEET MORE OR LESS
 M.F.G. = MINIMUM FINISHED GRADE
 F.P.G. = FLOOD PROTECTION GRADE

SWALE GRADE TO BE CONSTRUCTED DURING INITIAL EARTHWORK.
 SIDE YARD SWALE GRADE TO BE CONSTRUCTED AT TIME OF HOME CONSTRUCTION.



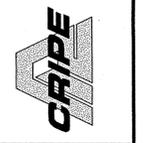
AS BUILT
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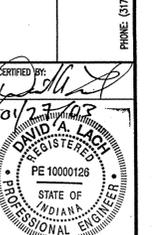
Date	Description
08/04/01	REVISIONS PER TAC AND OWNER COMMENTS.
08/24/01	REVISIONS PER TAC COMMENTS.
10/17/01	REVISIONS PER TAC COMMENTS.
10/19/01	REVISIONS PER TAC COMMENTS.
12/04/01	REVISIONS PER TAC COMMENTS.

ARCHITECTURE
 CIVIL ENGINEERS
 LANDSCAPE ARCHITECTURE
 LAND SURVEYORS
 ENVIRONMENTAL CONSULTANTS
 PROFESSIONAL ENGINEERS

7172 GRAHAM ROAD
 INDIANAPOLIS, IN 46250
 (317) 842-6777 FAX (317) 841-4798
 E-Mail: pc@pcipe.com



SITE DEVELOPMENT PLAN
LONG BRANCH ESTATES SECTIONS I AND II
PLATINUM PROPERTIES, LLC.
 9551 DELEGATES ROW
 INDIANAPOLIS, INDIANA 46240
 PHONE (317) 816-2900
 FAX (317) 816-2910

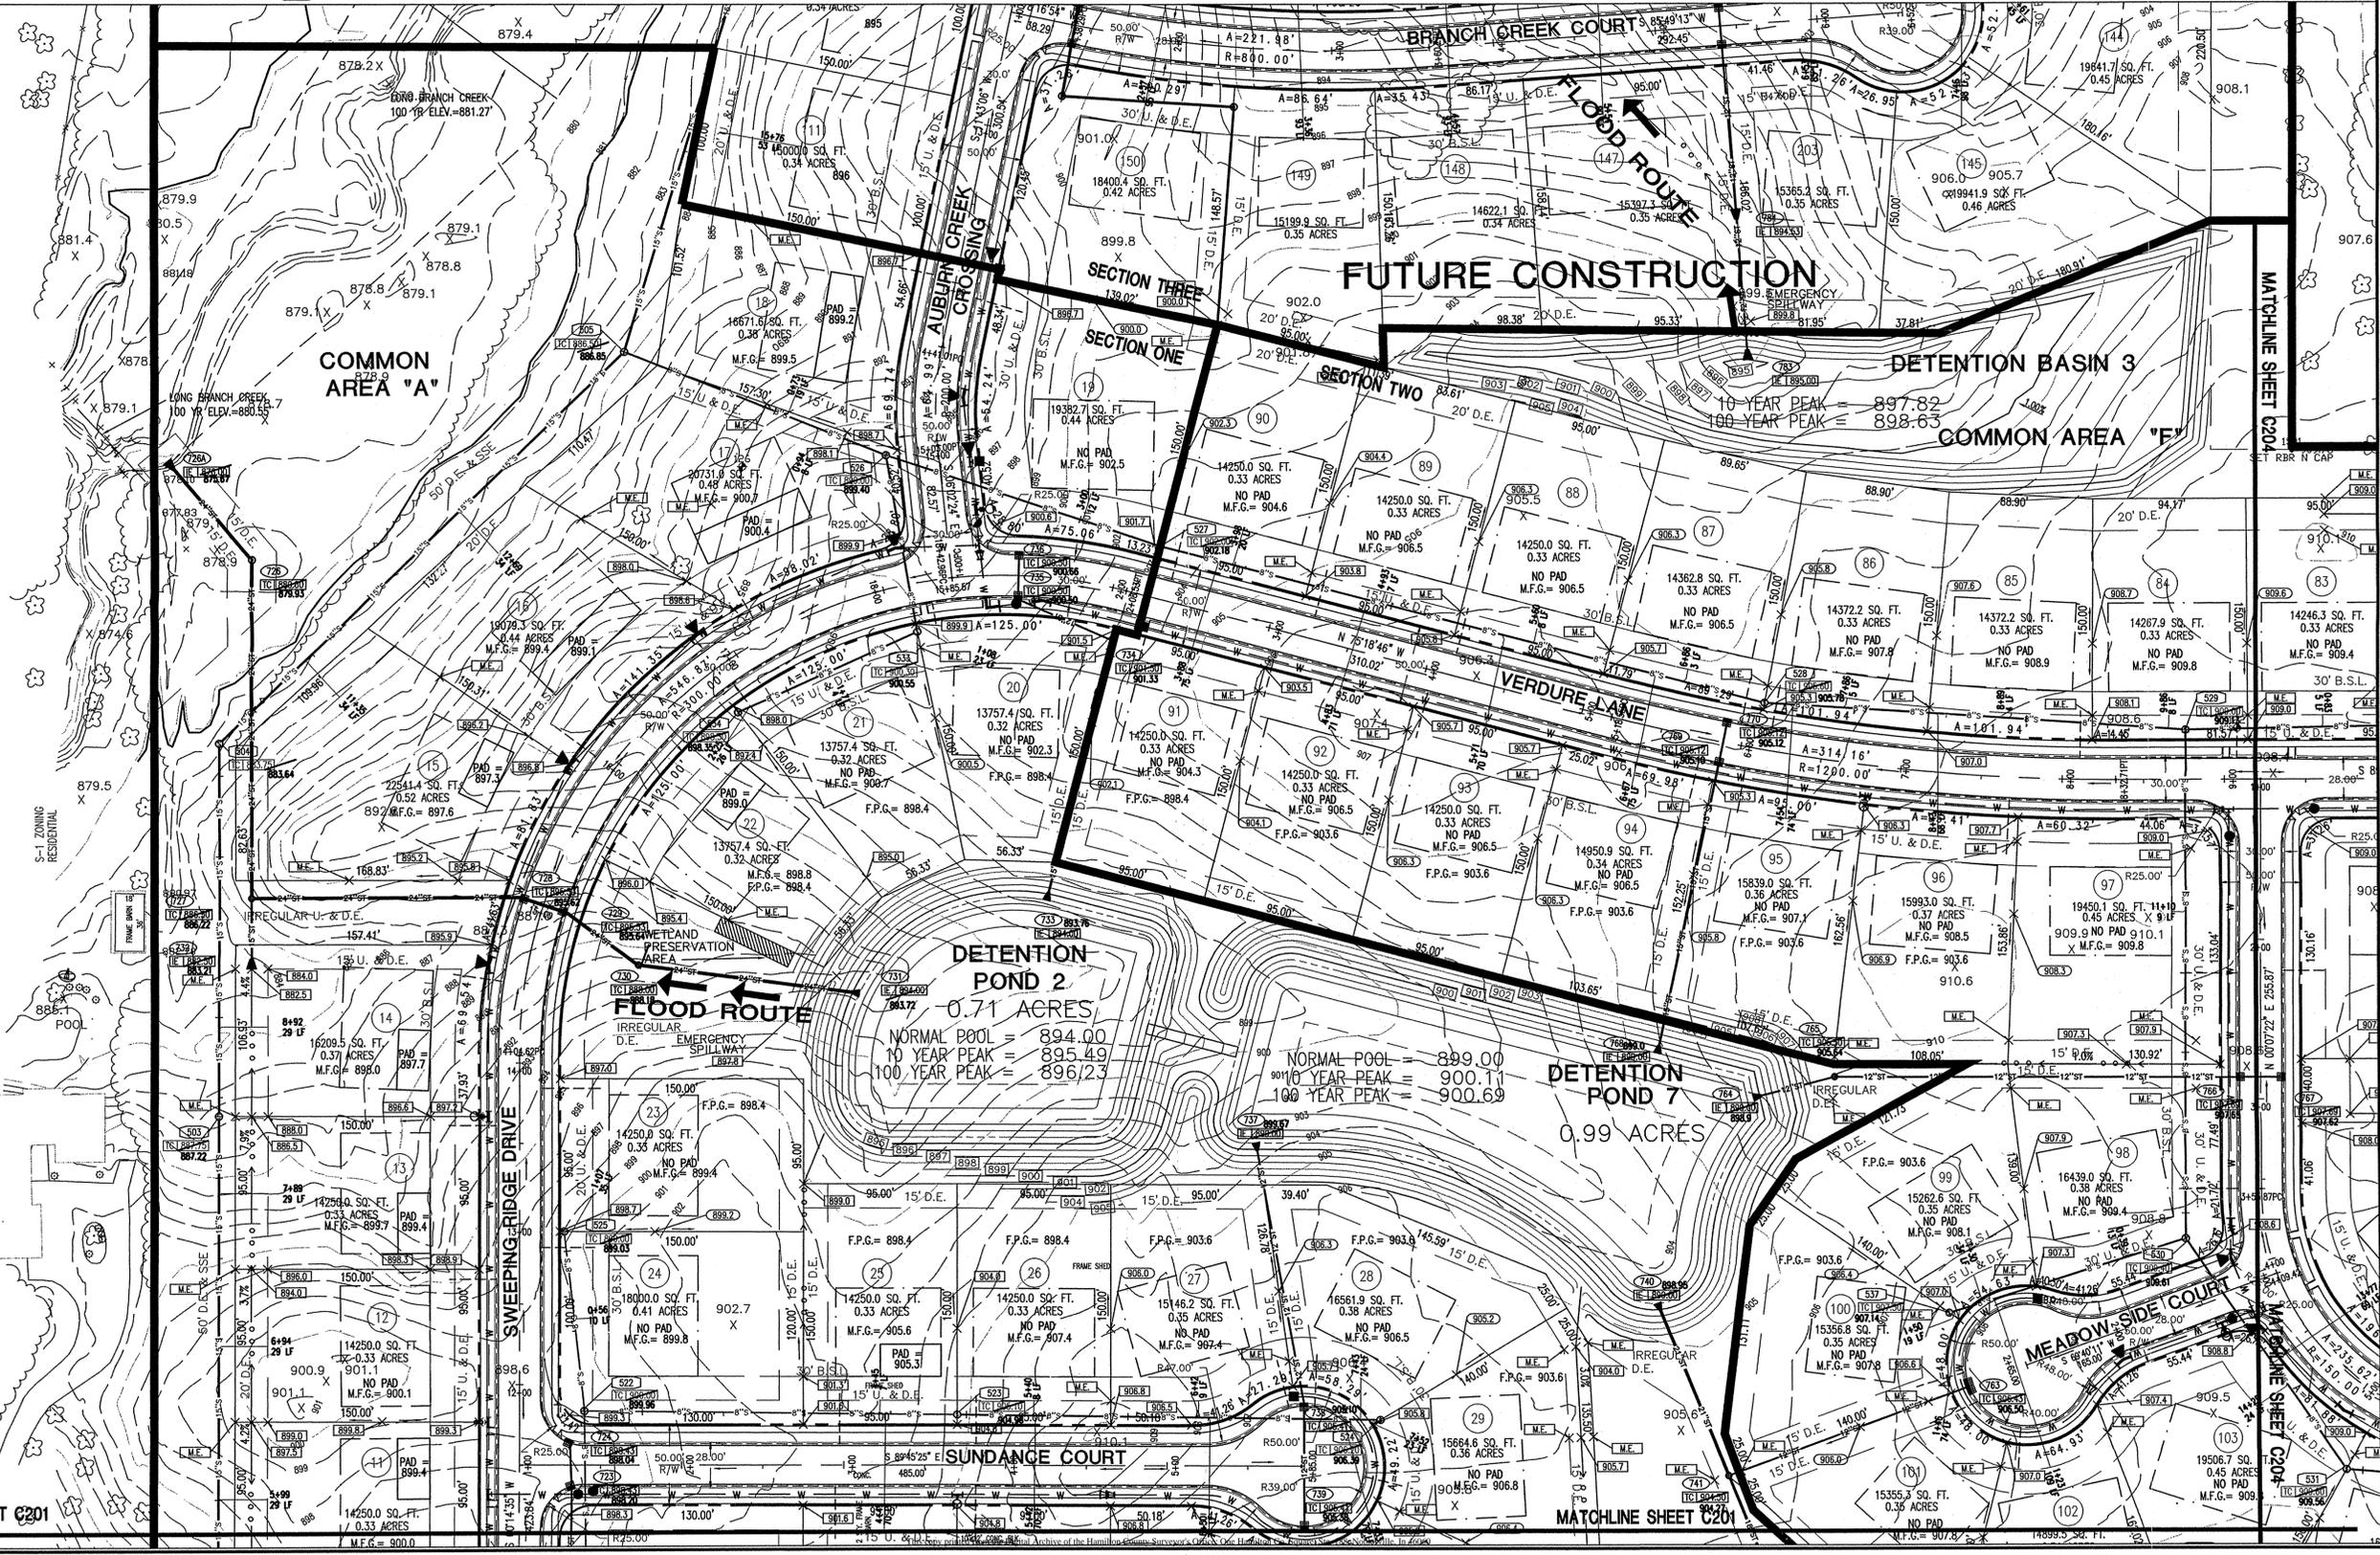


Drawn By: CH/FR
 Checked By: GM
 Quality Assurance: DL

Scale: 1" = 50'

Sheet: **C202**

Date: 11/28/01
 Project Number: 980401-20200



MATCHLINE SHEET C201

MATCHLINE SHEET C201

MATCHLINE SHEET C204

SEE SHEET C201 FOR ALL SITE AND UTILITY PLAN NOTES
 SEE SHEET C707 FOR STORM SEWER DETAILS.
 SEE SHEET C706 FOR STORM STRUCTURE AND PIPE DATA TABLES.

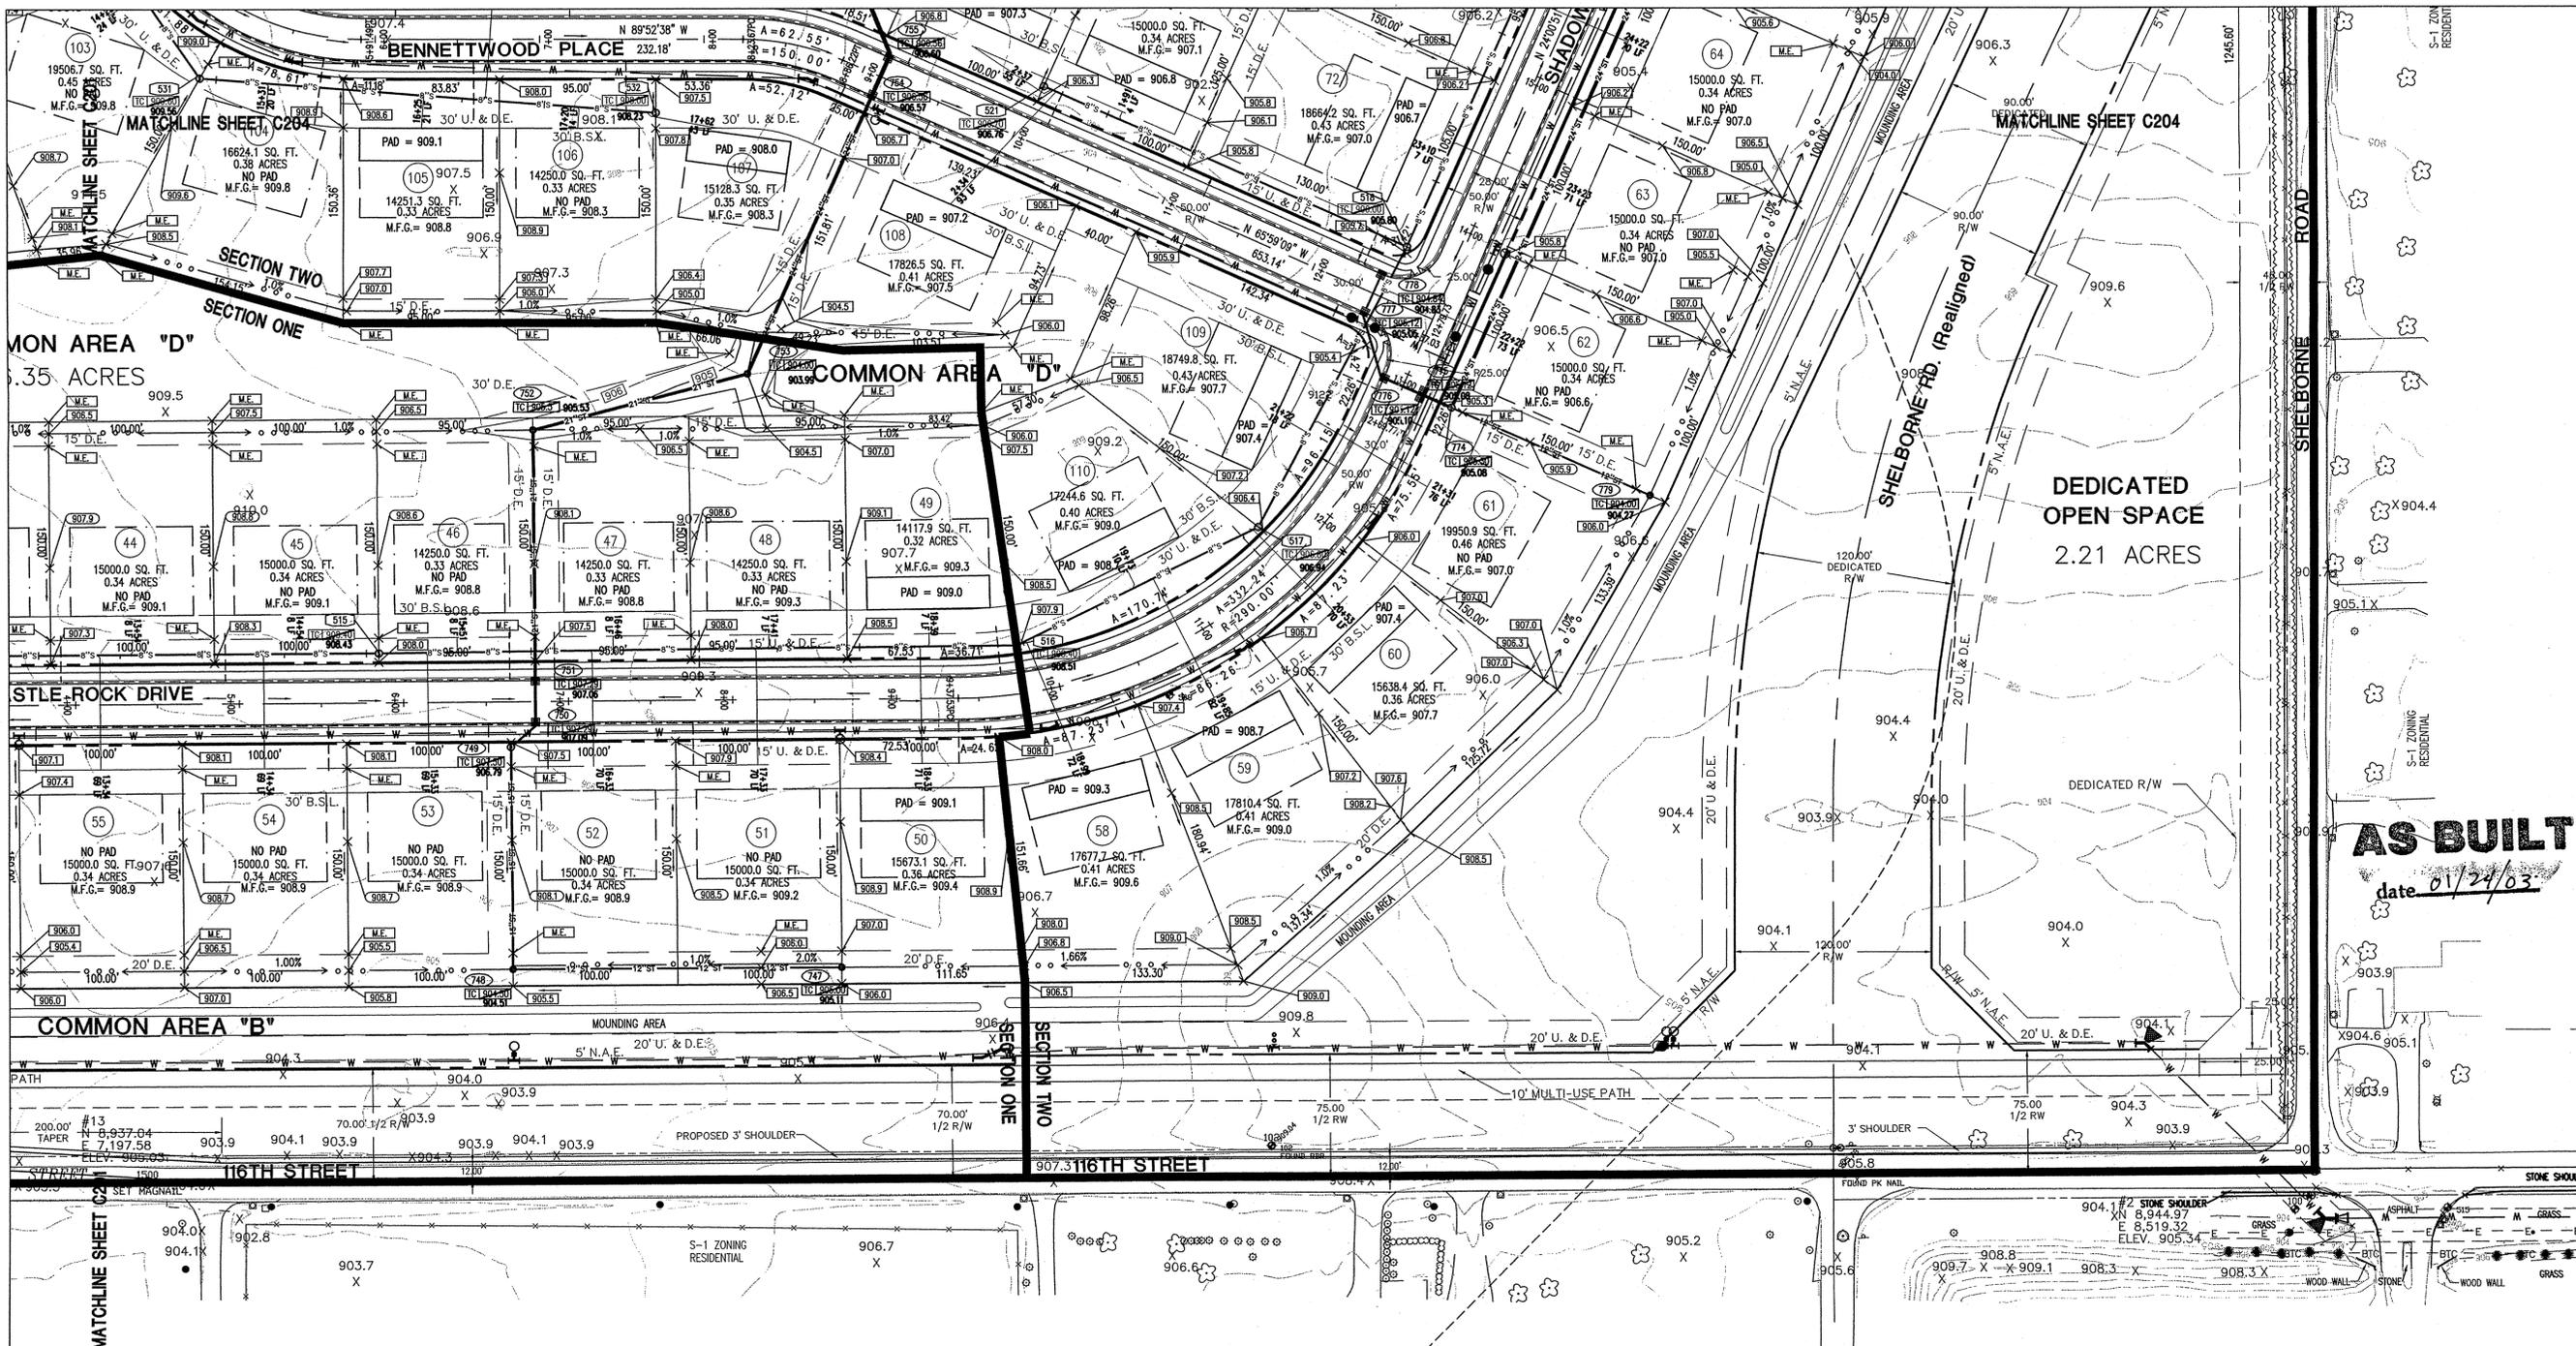
SITE PLAN LEGEND

- PROPOSED CONSTRUCTION**
- BUILDING SETBACK LINE
 - EASEMENT LINE
 - RIGHT-OF-WAY CENTERLINE
 - D.E. = DRAINAGE EASEMENT
 - S.S.E. = SANITARY SEWER EASEMENT
 - U.E. = UTILITY EASEMENT
 - L.E. = LANDSCAPE EASEMENT
 - N.A.E. = NON ACCESS EASEMENT
 - C.E. = CONSERVATION EASEMENT
 - B.S.L. = BUILDING SETBACK LINE
 - R = RADIUS
 - L = ARC LENGTH
 - P.O.B. = POINT OF BEGINNING
 - Ac. = ACRES MORE OR LESS
 - S.F. = SQUARE FEET MORE OR LESS
 - M.F.G. = MINIMUM FINISHED GRADE
 - F.P.G. = FLOOD PROTECTION GRADE
 - X 904.3 SWALE GRADE TO BE CONSTRUCTED DURING INITIAL EARTHWORK.
 - X 904.9 SIDE YARD SWALE GRADE TO BE CONSTRUCTED AT TIME OF HOME CONSTRUCTION.

UTILITY PLAN LEGEND

- PROPOSED CONSTRUCTION**
- SANITARY SEWER**
- SANITARY LATERAL
 - SANITARY LINE
 - SANITARY STRUCTURE NUMBER
 - SANITARY CASTING ELEVATION
- STORM SEWER**
- CURB WITH SUBSURFACE DRAIN (SSD)
 - CURB INLETS
 - STORM SEWER INLETS
 - STORM MANHOLE
 - END SECTION
 - STORM SEWER STRUCTURE NUMBER
 - STORM SEWER INVERT ELEVATION
 - TOP OF CASTING ELEVATION
 - DRAINAGE SWALE
 - DRAINAGE FLOW ARROW


- WATER**
- WATER LINE
 - WATER VALVE
 - PROPOSED FIRE HYDRANT
 - PROPOSED BLOW OFF ASSEMBLY
 - PROPOSED REDUCER
 - PROPOSED "TEE"
 - PROPOSED 45° ELBOW
 - PROPOSED 90° ELBOW
 - PROPOSED 11° ELBOW
 - PROPOSED KICKER BLOCK



SEE SHEET C201 FOR ALL SITE AND UTILITY PLAN NOTES
 SEE SHEET C707 FOR STORM SEWER DETAILS.
 SEE SHEET C708 FOR STORM STRUCTURE AND PIPE DATA TABLES.

SITE PLAN LEGEND	
PROPOSED CONSTRUCTION	
BUILDING SETBACK LINE	---
EASEMENT LINE	---
RIGHT-OF-WAY CENTERLINE	---
D.E.	= DRAINAGE EASEMENT
S.S.E.	= SANITARY SEWER EASEMENT
U.E.	= UTILITY EASEMENT
L.E.	= LANDSCAPE EASEMENT
N.A.E.	= NON ACCESS EASEMENT
C.E.	= CONSERVATION EASEMENT
B.S.L.	= BUILDING SETBACK LINE
R	= RADIUS
L	= ARC LENGTH
P.O.B.	= POINT OF BEGINNING
Ac.	= ACRES MORE OR LESS
S.F.	= SQUARE FEET MORE OR LESS
M.F.G.	= MINIMUM FINISHED GRADE
F.P.G.	= FLOOD PROTECTION GRADE
X [904.9]	= SWALE GRADE TO BE CONSTRUCTED DURING INITIAL EARTHWORK.
X [904.9]	= SIDE YARD SWALE GRADE TO BE CONSTRUCTED AT TIME OF HOME CONSTRUCTION.

UTILITY PLAN LEGEND	
PROPOSED CONSTRUCTION	
SANITARY SEWER	
SANITARY LATERAL	---
SANITARY LINE	---
SANITARY STRUCTURE NUMBER	---
SANITARY CASTING ELEVATION	---
STORM SEWER	
CURB WITH SUBSURFACE DRAIN (SSD)	---
CURB INLETS	---
STORM SEWER INLETS	---
STORM MANHOLE	---
END SECTION	---
STORM SEWER STRUCTURE NUMBER	---
STORM SEWER INVERT ELEVATION	---
TOP OF CASTING ELEVATION	---
DRAINAGE SWALE	---
DRAINAGE FLOW ARROW	---
WATER	
WATER LINE	---
WATER VALVE	---
PROPOSED FIRE HYDRANT	---
PROPOSED BLOW OFF ASSEMBLY	---
PROPOSED REDUCER	---
PROPOSED TEE	---
PROPOSED 45° ELBOW	---
PROPOSED 90° ELBOW	---
PROPOSED 11° ELBOW	---
PROPOSED KICKER BLOCK	---

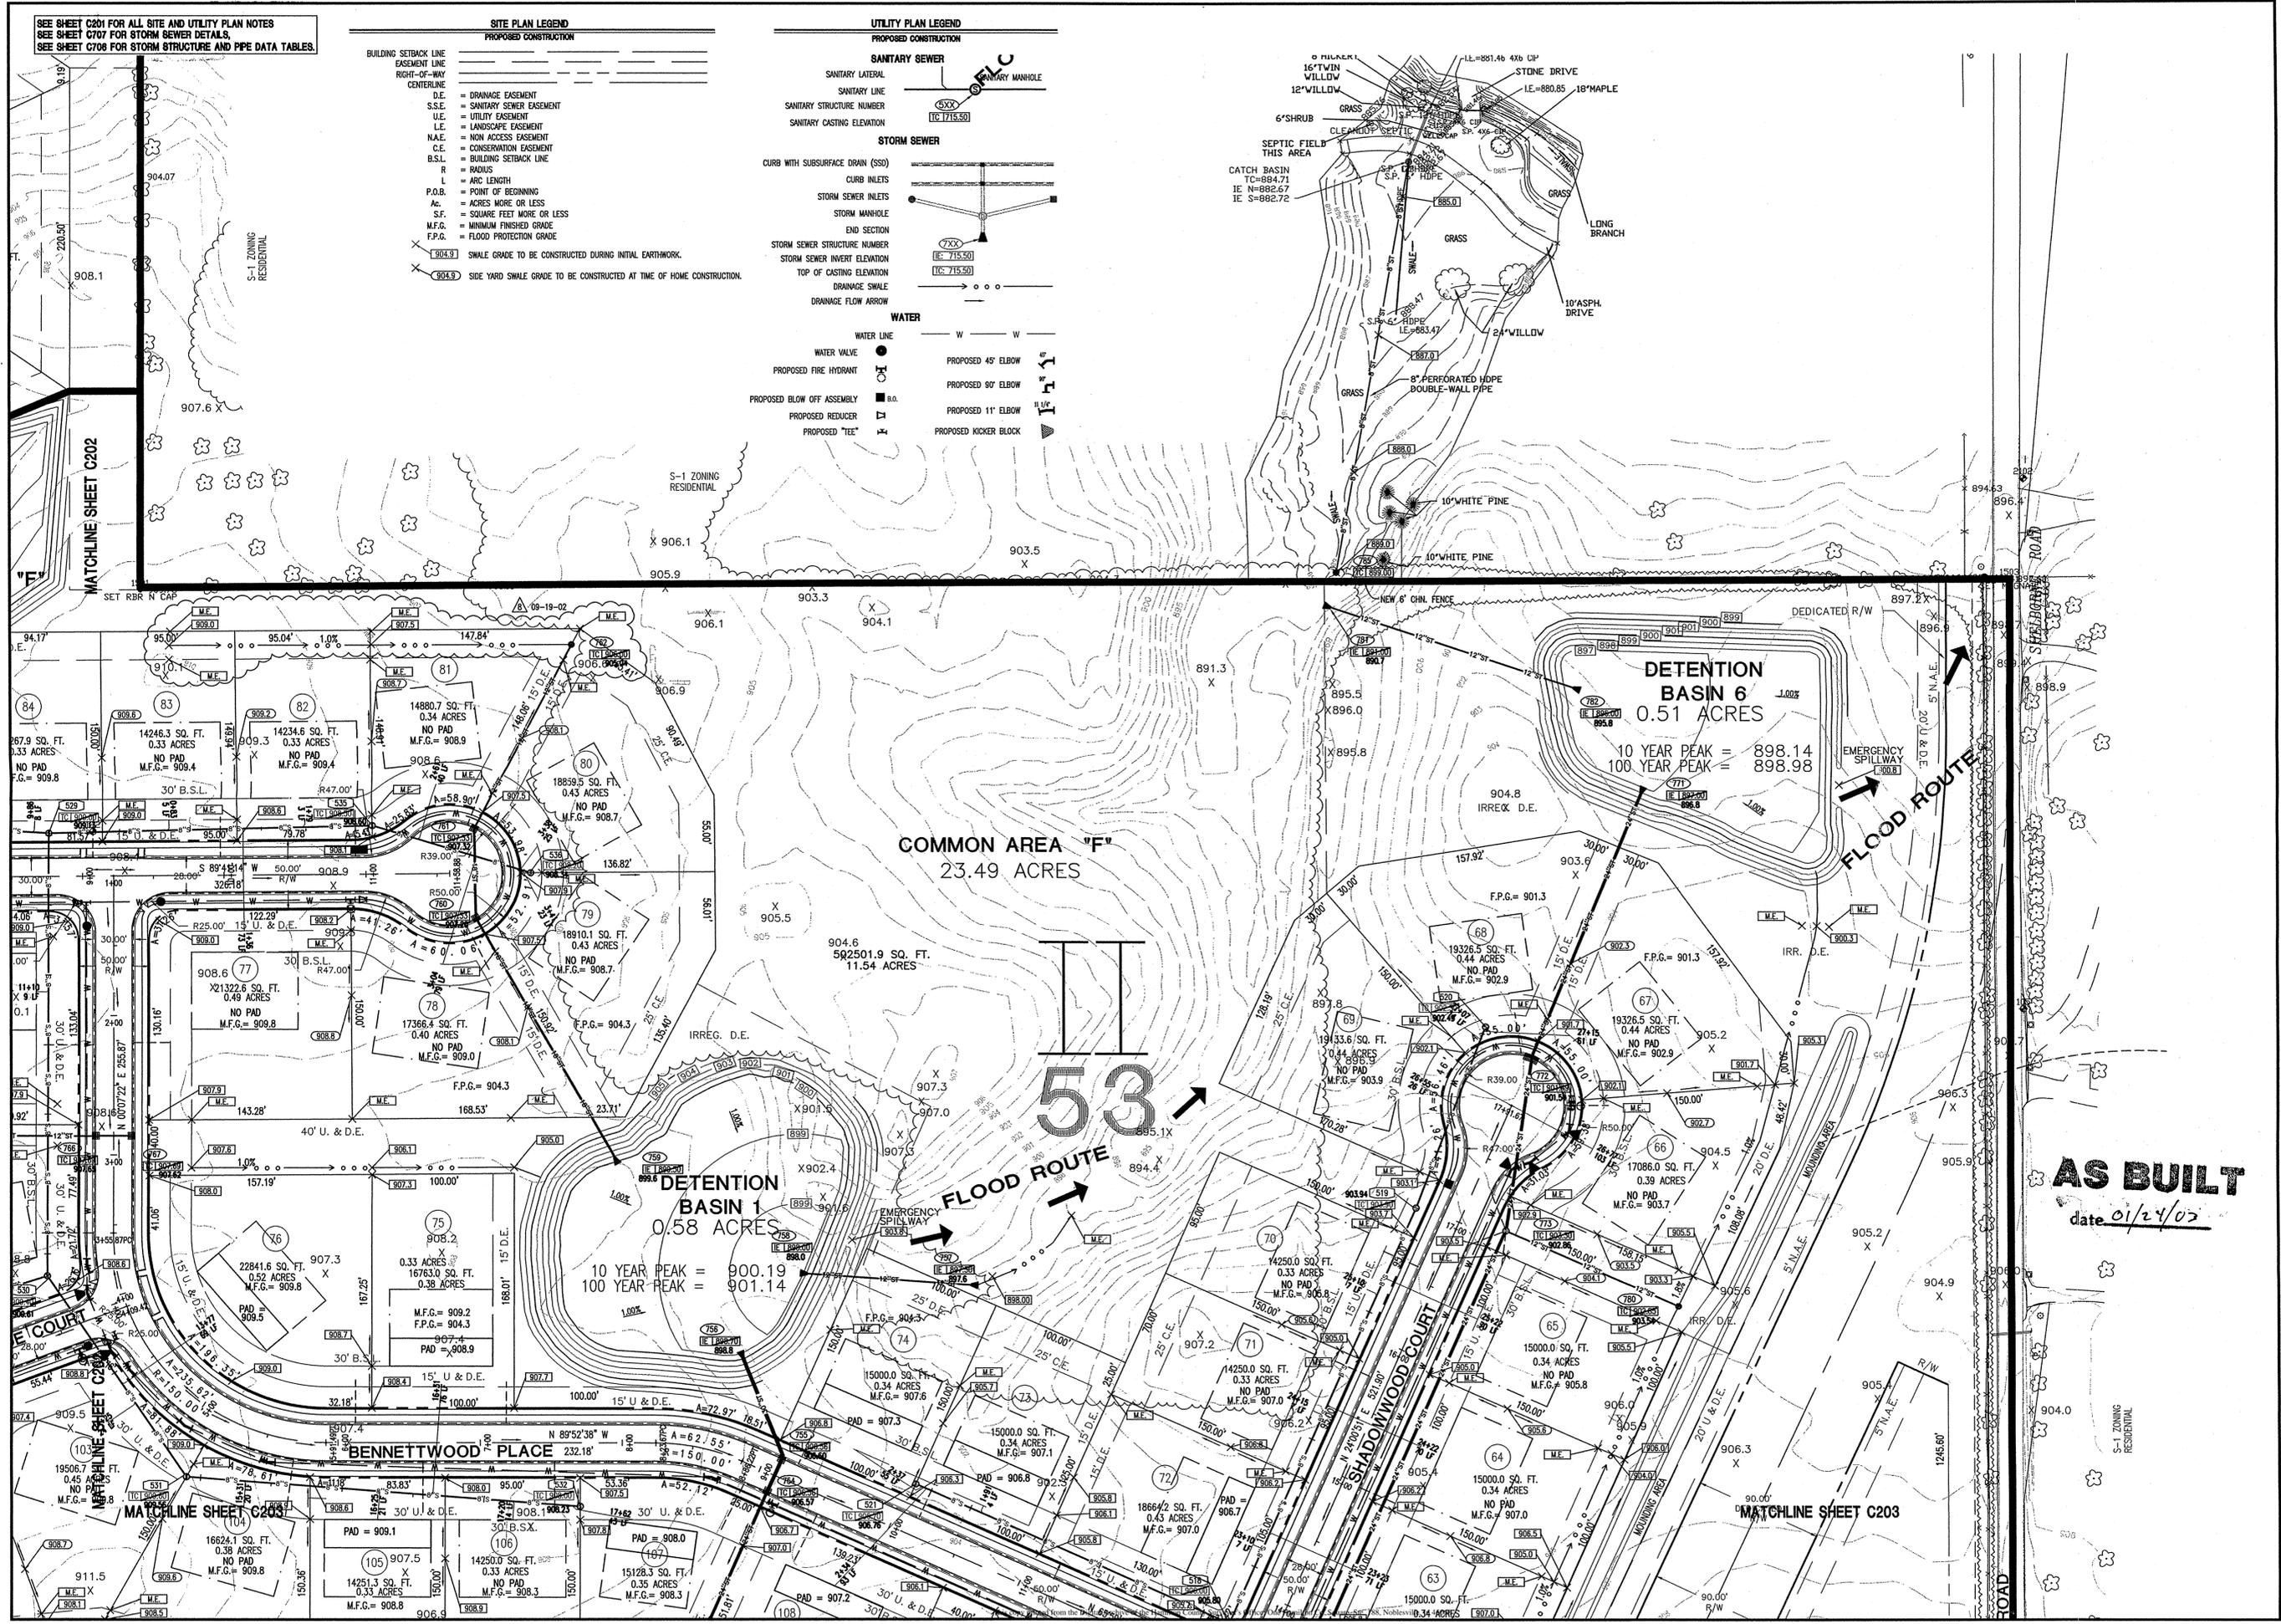

AS BUILT
 date 01/24/03


Revision	Date	Description
1	09/04/01	REVISIONS PER IAC AND OWNER COMMENTS.
2	09/24/01	REVISIONS PER IAC COMMENTS.
3	10/17/01	REVISIONS PER IAC COMMENTS.
4	10/17/01	REVISIONS PER IAC, CO. SURVEYOR COMMENTS.
5	12/04/01	REVISIONS PER IAC, CO. SURVEYOR COMMENTS.
6	09/19/02	GRADE REVISIONS PER CONVERSION WITH CONTRACTOR.

- ARCHITECTURE
- CIVIL ENGINEERS
- LANDSCAPE ARCHITECTURE
- LAND SURVEYORS
- ENVIRONMENTAL CONSULTANTS
- TRANSPORTATION ENGINEERS
- GIS


7172 GRAHAM ROAD
 INDIANAPOLIS, INDIANA 46250
 (317) 842-6777 FAX (317) 841-4798
 E-Mail: picpipe@picpipe.com



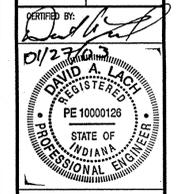SITE DEVELOPMENT PLAN
LONG BRANCH ESTATES SECTIONS I AND II
PLATINUM PROPERTIES, LLC.
 9551 DELEGATES ROW
 INDIANAPOLIS, INDIANA 46240
 PHONE: (317) 818-2900 FAX: (317) 818-2910




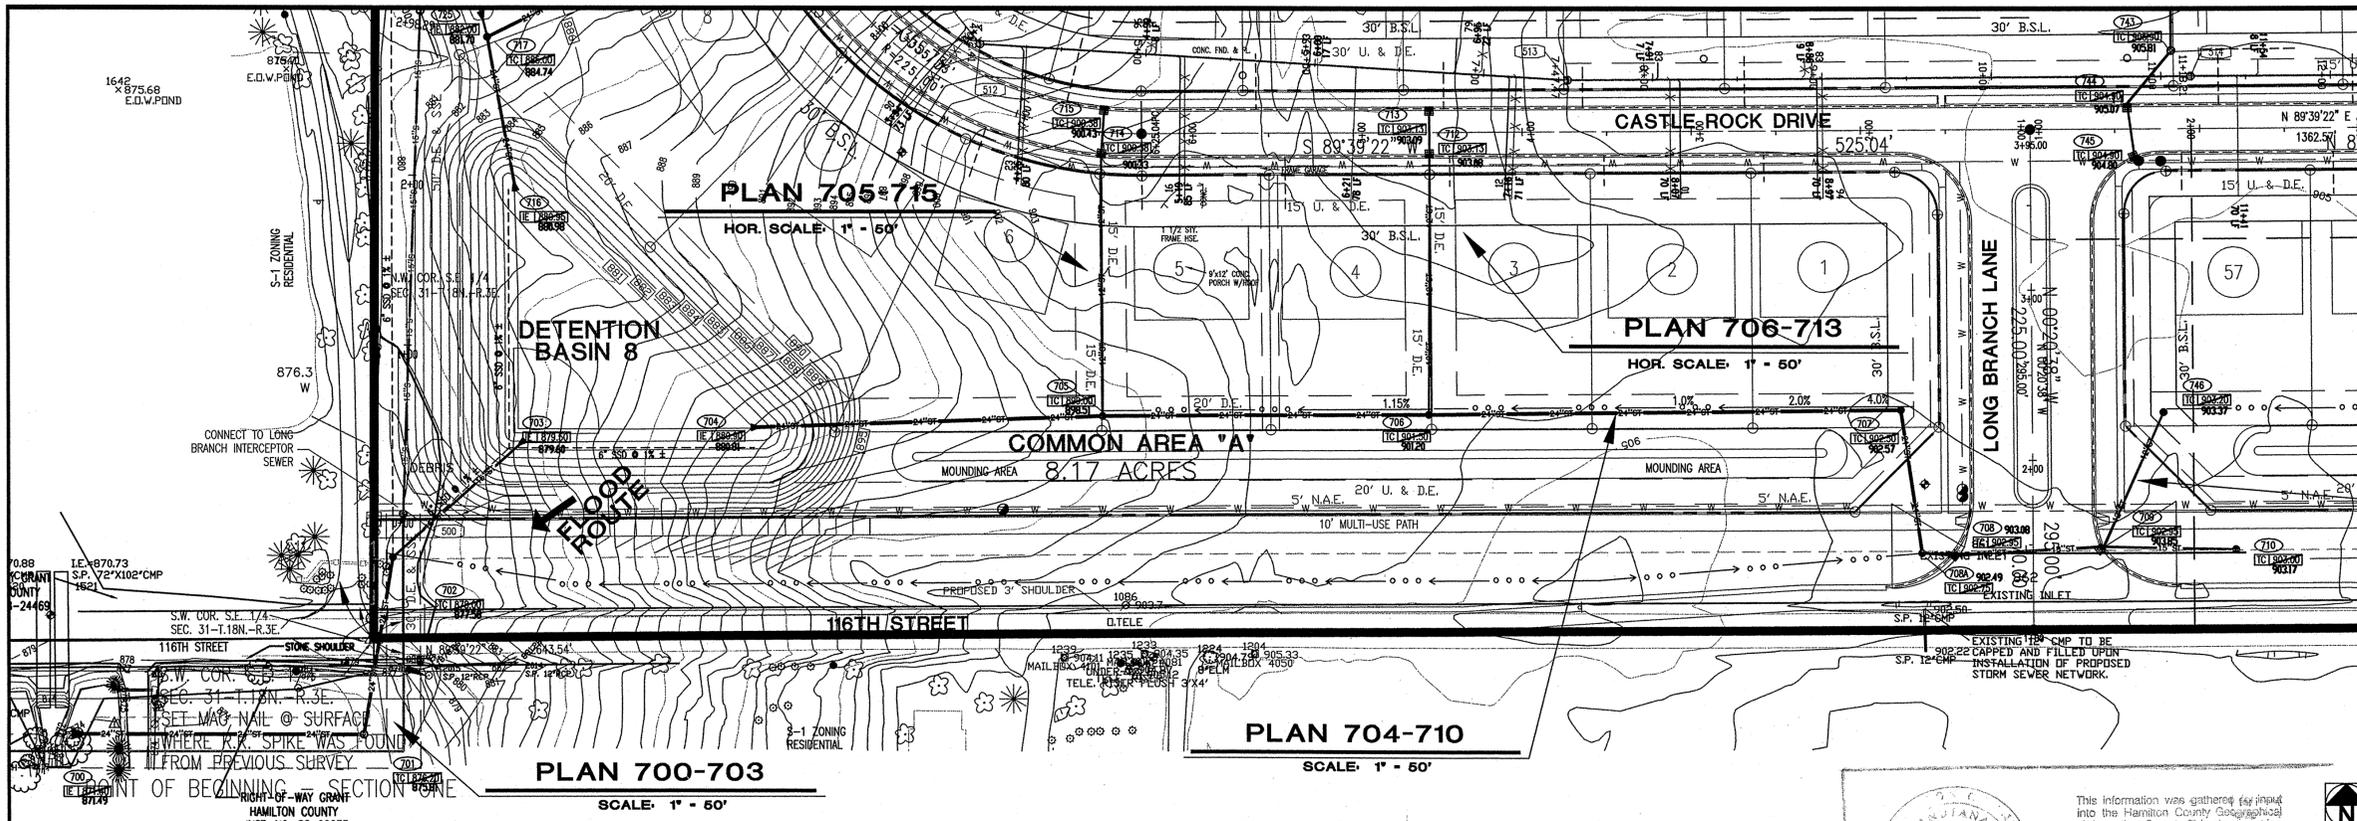Drawn By: CH/RR
 Checked By: GM
 Quality Assurance: DL
 Scale: 1" = 50'
 Sheet: **C204**
 Date: 11/28/01
 Project Number: 980401-20200




PLAN 704-710
SCALE: 1" = 50'

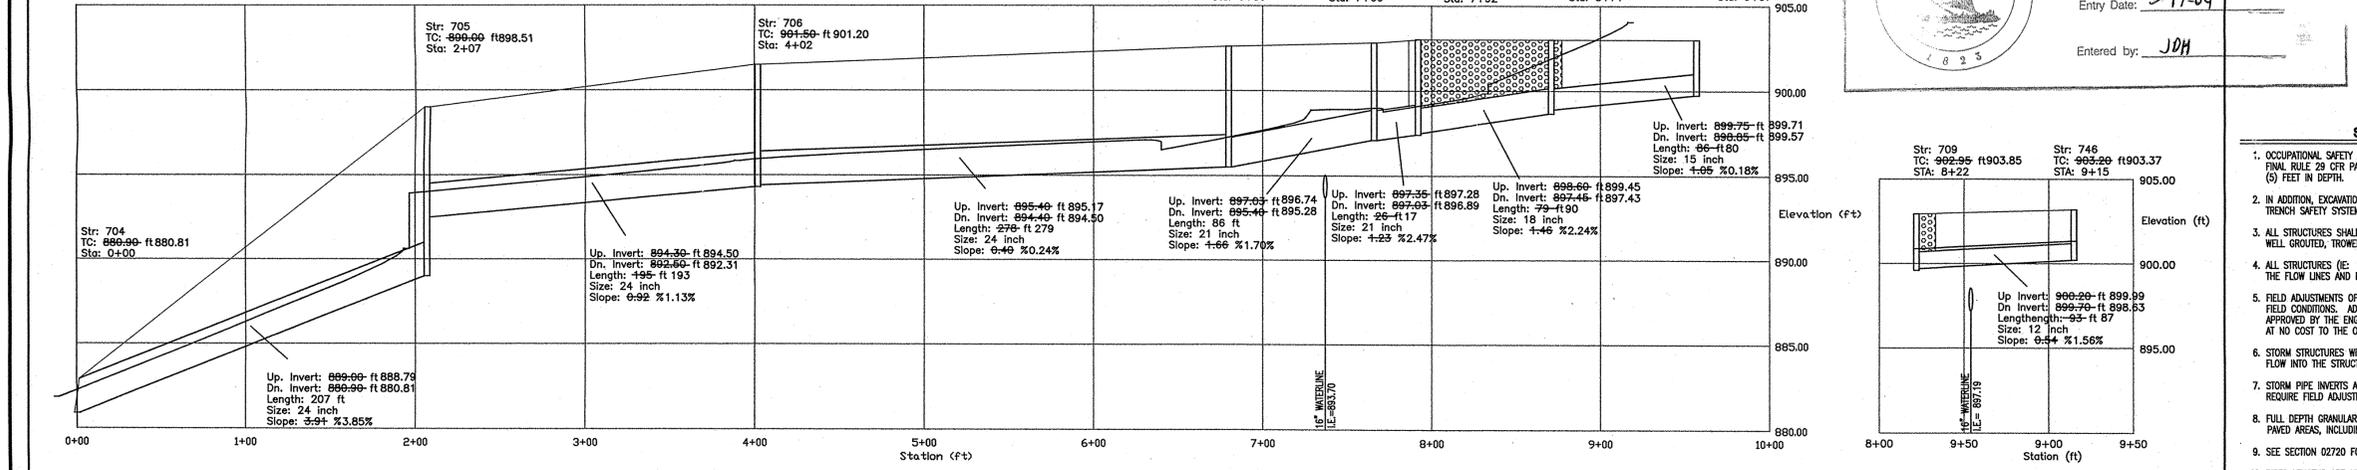This information was gathered for input into the Hamilton County Geographic Information System (GIS).
Entry Date: 3-17-04
Entered by: JDH




PROFILE 704-710
HOR. SCALE: 1" = 50'
VER. SCALE: 1" = 5'


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HOR. SCALE: 1" = 50'
VER. SCALE: 1" = 5'

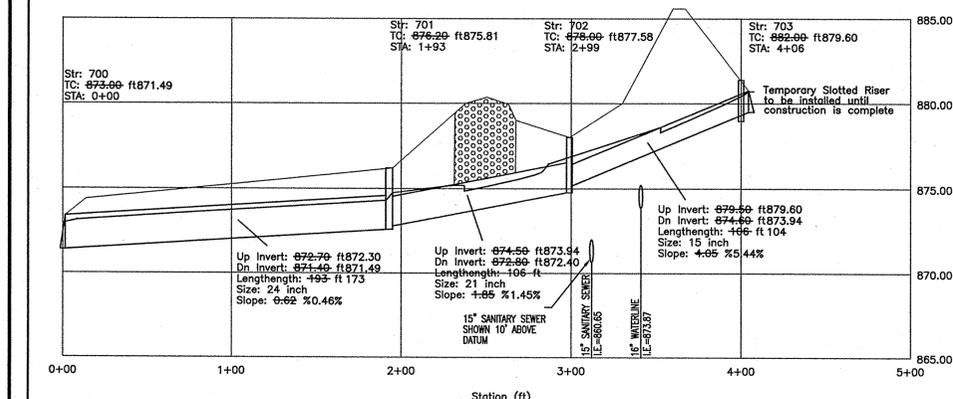

PROFILE 700-703
HOR. SCALE: 1" = 50'
VER. SCALE: 1" = 5'

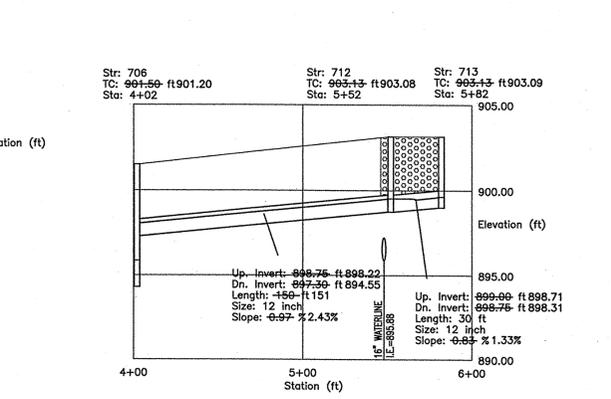


PROFILE 706-713
HOR. SCALE: 1" = 50'
VER. SCALE: 1" = 5'

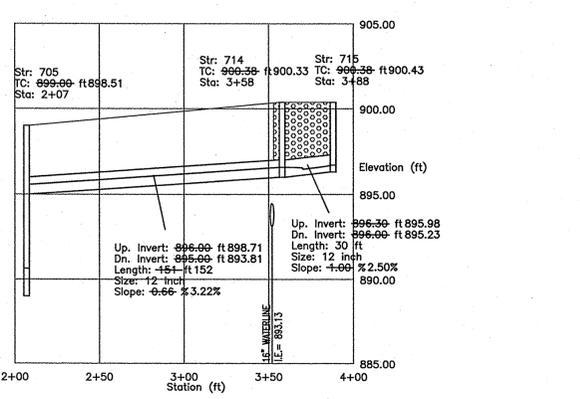

PROFILE 705-715
HOR. SCALE: 1" = 50'
VER. SCALE: 1" = 5'

AS BUILT
date 01/07/04
REVISED

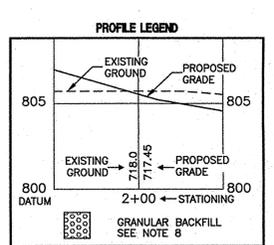- STORM SEWER PLAN AND PROFILE NOTES:**
- OCCUPATIONAL SAFETY AND HEALTH ADMINISTRATION (OSHA) STANDARDS FOR EXCAVATIONS, FINAL RULE 29 CFR PART 1926, SUBPART "I" APPLIES TO ALL EXCAVATIONS EXCEEDING FIVE (5) FEET IN DEPTH.
 - IN ADDITION, EXCAVATIONS EXCEEDING TWENTY (20) FEET IN DEPTH REQUIRE THE DESIGN OF A TRENCH SAFETY SYSTEM BY A REGISTERED PROFESSIONAL ENGINEER.
 - ALL STRUCTURES SHALL HAVE CASTINGS, JOINTS, LIFT RINGS, STEPS AND PIPE CONNECTIONS WELL GROUTED, TROWELED SMOOTH AND BRUSH FINISHED.
 - ALL STRUCTURES (IE: MANHOLES, INLETS) SHALL HAVE POURED FLOW LINES AND BENCH WALLS. THE FLOW LINES AND BENCH WALLS SHALL BE TROWELED SMOOTH AND BRUSH FINISHED.
 - FIELD ADJUSTMENTS OF TOP OF CASTING (T.O.C.) OF STRUCTURES MAY BE REQUIRED TO MEET FIELD CONDITIONS. ADJUSTMENTS EXCEEDING FIVE TENTHS (0.5) OF A FOOT MUST BE APPROVED BY THE ENGINEER TO DETERMINE THE INTEGRITY OF THE STRUCTURE. AT NO COST TO THE OWNER.
 - STORM STRUCTURES WITH INLET CASTINGS SHALL BE SET TO MAINTAIN A POSITIVE DRAINAGE FLOW INTO THE STRUCTURE.
 - STORM PIPE INVERTS AT OUTLET STRUCTURES (E: END SECTIONS), AND PIPE LENGTHS MAY REQUIRE FIELD ADJUSTMENTS TO MEET ACTUAL FIELD CONDITIONS.
 - FULL DEPTH GRANULAR BACKFILL SHALL BE REQUIRED UNDER AND WITHIN (5) FEET OF ALL PAVED AREAS, INCLUDING CURBS, EDGE OF PAVEMENT, AND SIDEWALKS.
 - SEE SECTION 0220 FOR STORM SEWERAGE SPECIFICATIONS IN THE PROJECT MANUAL.
 - PIPE LENGTHS ARE MEASURED FROM CENTER OF STRUCTURE TO CENTER OF STRUCTURE AND INCLUDE END SECTIONS.
 - ALL STORM SEWER PIPES ARE TO BE REINFORCED CONCRETE PIPE UNLESS OTHERWISE NOTED.
 - DEBRIS GUARDS TO BE INSTALLED ON ALL OPEN ENDED INLETS AND AT ALL POND OUTFALL PIPES.



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TRANSPORTATION ENGINEERS
GIS

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INDIANAPOLIS, IN 46250
(317) 842-6777
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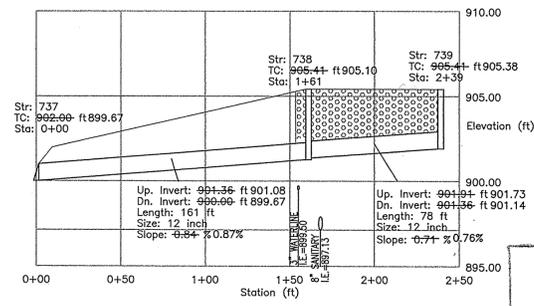
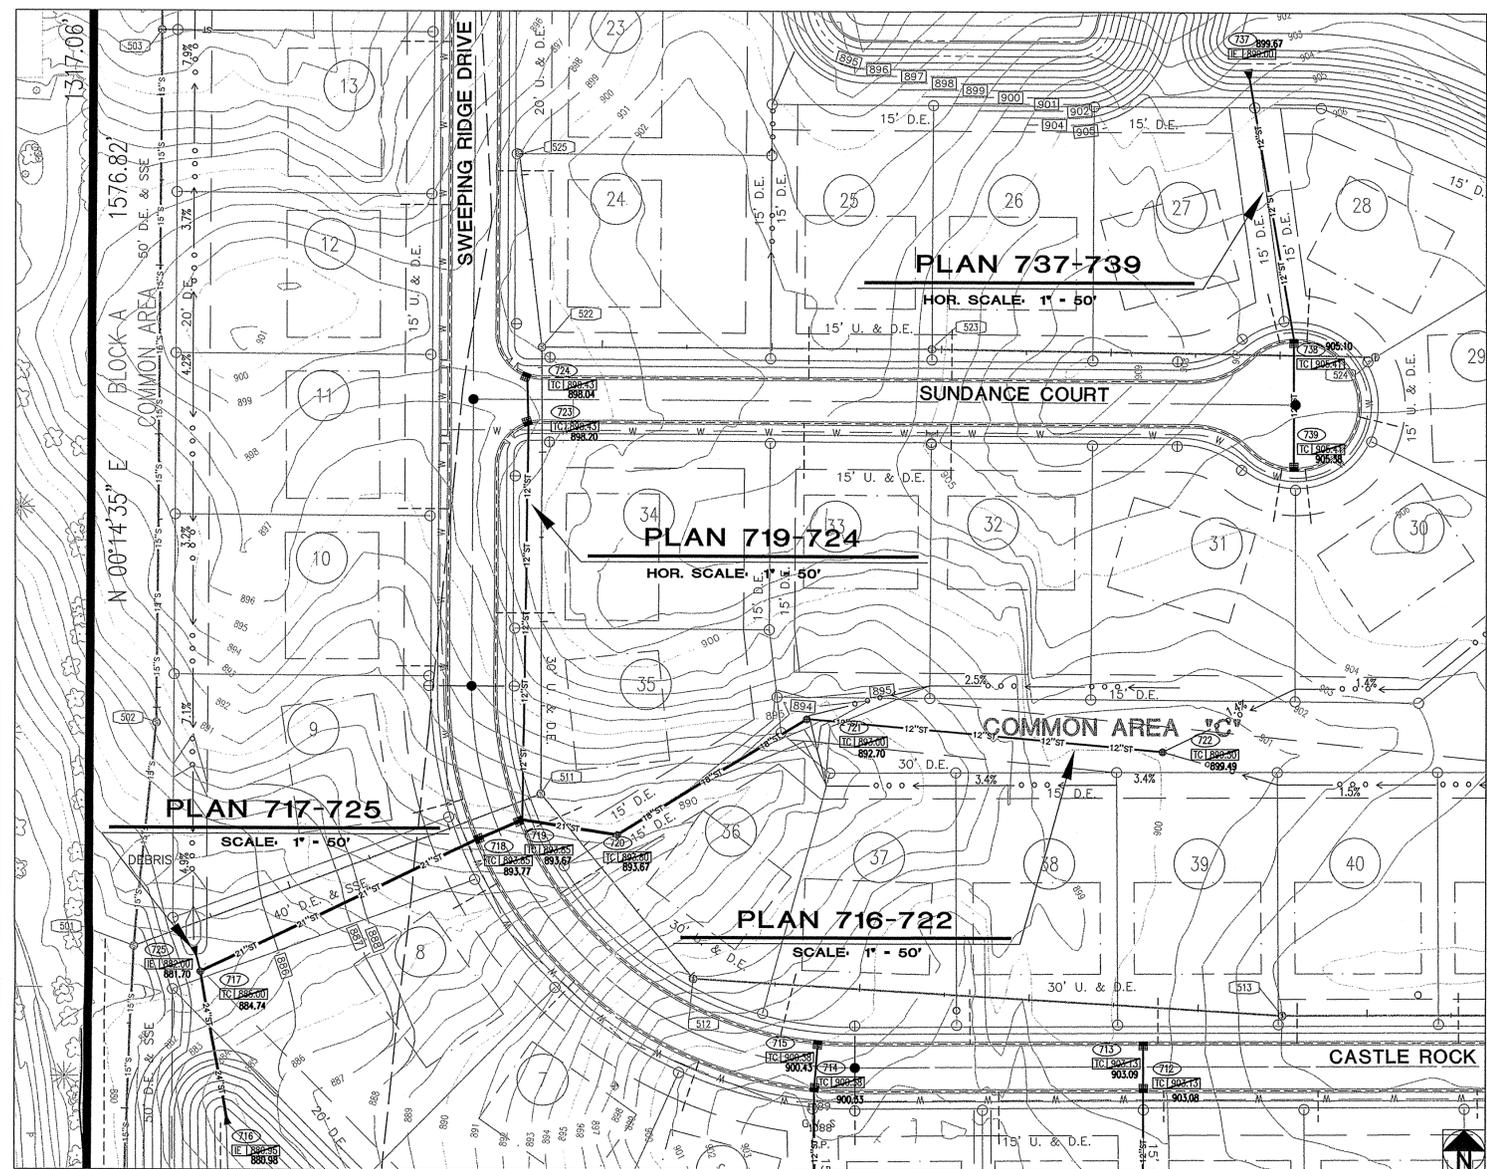
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STORM SEWER PLAN AND PROFILES
LONG BRANCH ESTATES SECTIONS I AND II
PLATINUM PROPERTIES, LLC.
9551 DELEGATES ROW
INDIANAPOLIS, INDIANA 46240
PHONE: (317) 818-2900 FAX: (317) 818-2910

CERTIFIED BY: *[Signature]*
DAVID A. LACH
REGISTERED PROFESSIONAL ENGINEER
PE 10000126
STATE OF INDIANA

Drawn by: CH/FR
Checked by: GM
Quality Assurance: DL

Scale: 0 Scale: 1" = 50'
C701
Date: 11/28/01
Project Number: 980401-20200




PROFILE 737-739
 HOR. SCALE: 1" = 50'
 VER. SCALE: 1" = 5'



This information was gathered for input into the Hamilton County Geographical Information System. This document is considered an official record of the G.I.S.

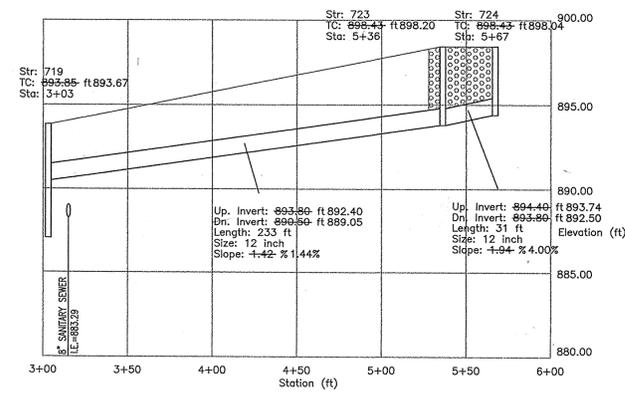Entry Date: 3-17-04
 Entered by: JHH




PROFILE 719-724
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 VER. SCALE: 1" = 5'


AS BUILT
 date 11/18/02

STORM SEWER PLAN AND PROFILE NOTES:


- OCCUPATIONAL SAFETY AND HEALTH ADMINISTRATION (OSHA) STANDARDS FOR EXCAVATIONS, FINAL RULE 29 CFR PART 1926, SUBPART "F" APPLIES TO ALL EXCAVATIONS EXCEEDING FIVE (5) FEET IN DEPTH.
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- ALL STRUCTURES (IE: MANHOLES, INLETS) SHALL HAVE POURED FLOW LINES AND BENCH WALLS. THE FLOW LINES AND BENCH WALLS SHALL BE TROWELED SMOOTH AND BRUSH FINISHED.
- FIELD ADJUSTMENTS OF TOP OF CASTING (I.C.) OF STRUCTURES MAY BE REQUIRED TO MEET FIELD CONDITIONS. ADJUSTMENTS EXCEEDING FIVE TENTHS (0.5) OF A FOOT MUST BE APPROVED BY THE ENGINEER TO DETERMINE THE INTEGRITY OF THE STRUCTURE AT NO COST TO THE OWNER.
- STORM STRUCTURES WITH INLET CASTINGS SHALL BE SET TO MAINTAIN A POSITIVE DRAINAGE FLOW INTO THE STRUCTURE.
- STORM PIPE INVERTS AT OUTLET STRUCTURES (IE: END SECTIONS), AND PIPE LENGTHS MAY REQUIRE FIELD ADJUSTMENTS TO MEET ACTUAL FIELD CONDITIONS.
- FULL DEPTH GRANULAR BACKFILL SHALL BE REQUIRED UNDER AND WITHIN (5) FEET OF ALL PAVED AREAS, INCLUDING CURBS, EDGE OF PAVEMENT, AND SIDEWALKS.
- SEE SECTION 02720 FOR STORM SEWERAGE SPECIFICATIONS IN THE PROJECT MANUAL OR INCLUDE END SECTIONS.
- PIPE LENGTHS ARE MEASURED FROM CENTER OF STRUCTURE TO CENTER OF STRUCTURE AND INCLUDE END SECTIONS.
- ALL STORM SEWER PIPES ARE TO BE REINFORCED CONCRETE PIPE UNLESS OTHERWISE NOTED.
- DEBRIS GUARDS TO BE INSTALLED ON ALL OPEN ENDED INLETS AND AT ALL POND OUTFALL PIPES.

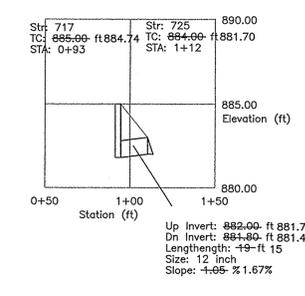

PROFILE 717-725
 HOR. SCALE: 1" = 50'
 VER. SCALE: 1" = 5'

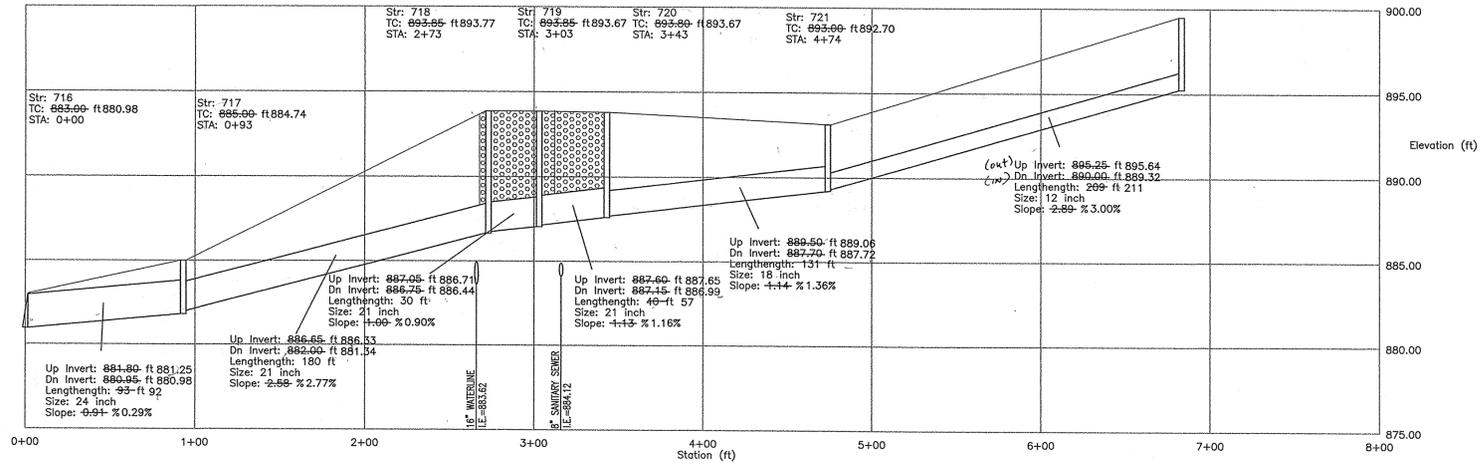

PROFILE 716-722
 HOR. SCALE: 1" = 50'
 VER. SCALE: 1" = 5'

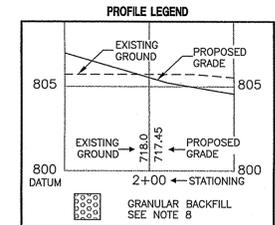

FILED
 NOV 19 2002

OFFICE OF HAMILTON COUNTY SURVEYOR
DON'T DIG BLIND
 CAUTION: LOCATIONS OF ALL EXISTING UNDERGROUND UTILITIES SHOWN ON THIS PLAN ARE BASED UPON ABOVE GROUND EVIDENCE (ie: holes, but not limited to, manholes, pits, valves, and marks made upon the ground by others) AND ARE SPECULATIVE IN NATURE. THERE MAY ALSO BE OTHER EXISTING UNDERGROUND UTILITIES FOR WHICH THERE IS NO ABOVE GROUND EVIDENCE OR FOR WHICH NO ABOVE GROUND EVIDENCE WAS OBSERVED. THE EXACT LOCATIONS OF SAID EXISTING UNDERGROUND UTILITIES SHOULD BE VERIFIED BY THE CONTRACTOR PRIOR TO ANY AND ALL CONSTRUCTION.
 1-800-382-5444
 1-800-428-5200
 FOR CALLS OUTSIDE OF INDIANA

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 GIS

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 INDIANAPOLIS, INDIANA 46250
 842-5777 FAX (317) 841-4798
 E-Mail: picrpe@picrpe.com

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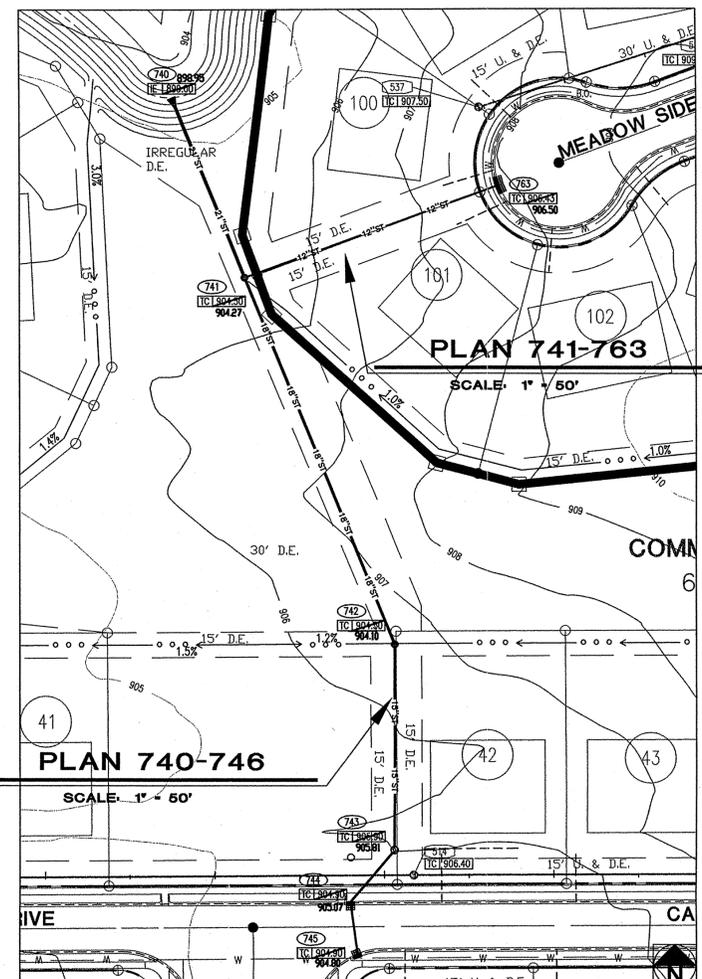
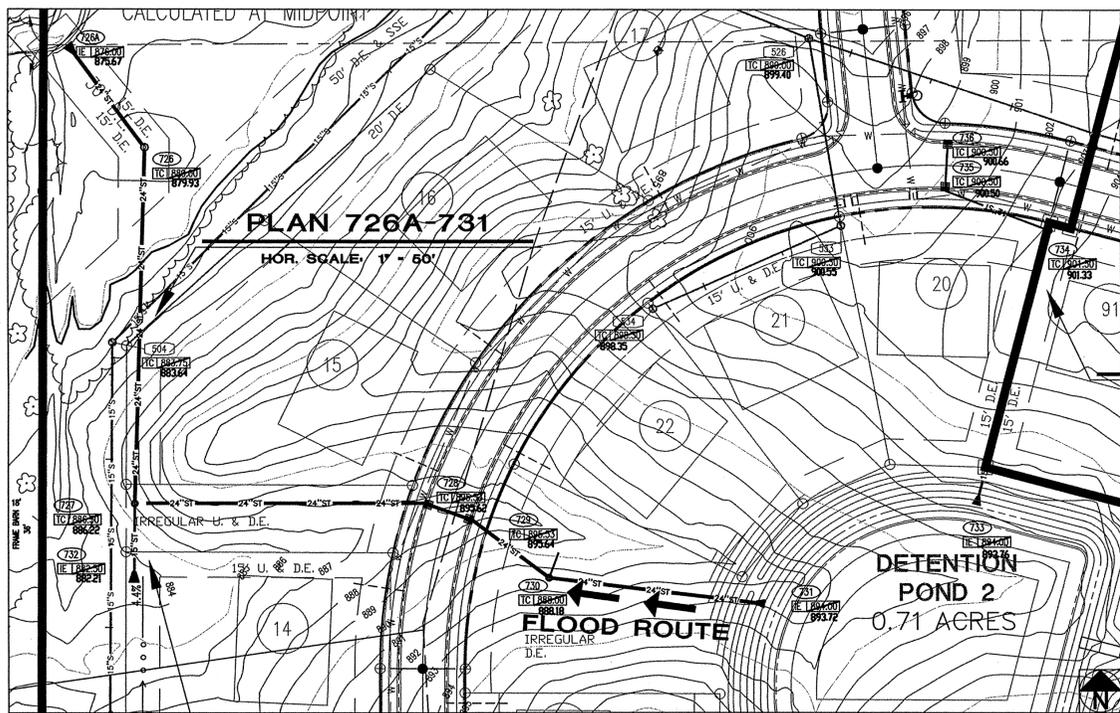
STORM SEWER PLAN AND PROFILES
LONG BRANCH ESTATES SECTIONS I AND II
PLATINUM PROPERTIES, LLC.
 9551 DELEGATES ROW
 INDIANAPOLIS, INDIANA 46240

PHONE: (317) 818-2900
 FAX: (317) 818-2910


CERTIFIED BY: [Signature]
 DAVID A. LAGI
 REGISTERED PROFESSIONAL ENGINEER
 PE 10000126
 STATE OF INDIANA

Drawn by: CH/R
 Checked by: GM
 Quality Assurance: DL

Scale: 1" = 50'
C702
 Date: 11/28/01
 Project Number: 980401-20200






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CAUTION: LOCATIONS OF ALL EXISTING UNDERGROUND UTILITIES SHOWN ON THIS PLAN ARE BASED UPON ABOVE GROUND EVIDENCE (including, but not limited to, manholes, inlets, valves, and marks made upon the ground by others) AND ARE SPECULATIVE IN NATURE. THERE MAY ALSO BE OTHER EXISTING UNDERGROUND UTILITIES FOR WHICH THERE IS NO ABOVE GROUND EVIDENCE OR FOR WHICH NO ABOVE GROUND EVIDENCE WAS OBSERVED. THE EXACT LOCATIONS OF SUCH EXISTING UNDERGROUND UTILITIES SHOULD BE VERIFIED BY THE CONTRACTOR PRIOR TO ANY AND ALL CONSTRUCTION.

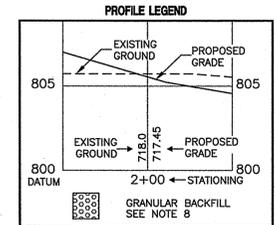1-800-382-5544
1-800-428-5200
FOR CALLS OUTSIDE OF INDIANA





AMILTON COUNTY INDIANA

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Entry Date: 3-17-04
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date 01/24/03

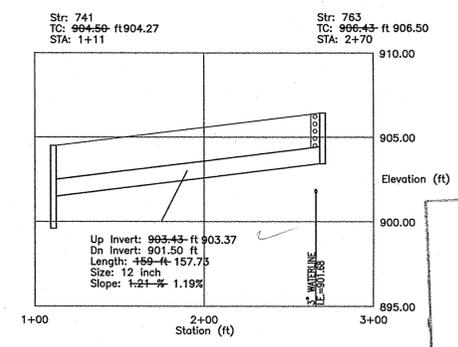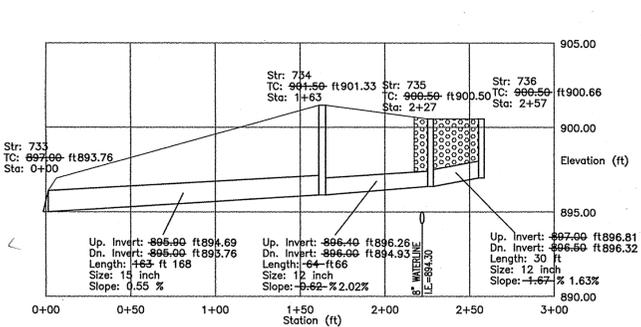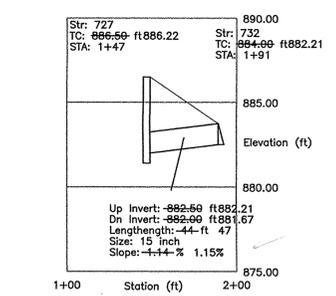

ARCHITECTURE
CIVIL ENGINEERS
LAND PLANNING
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GIS

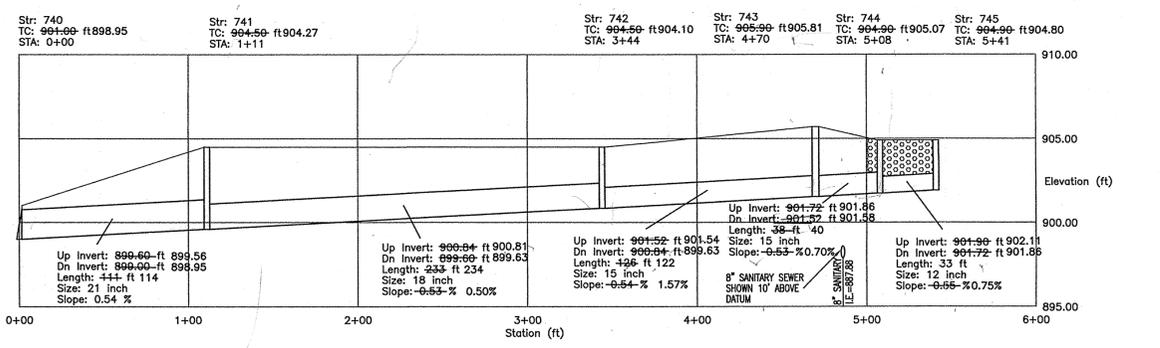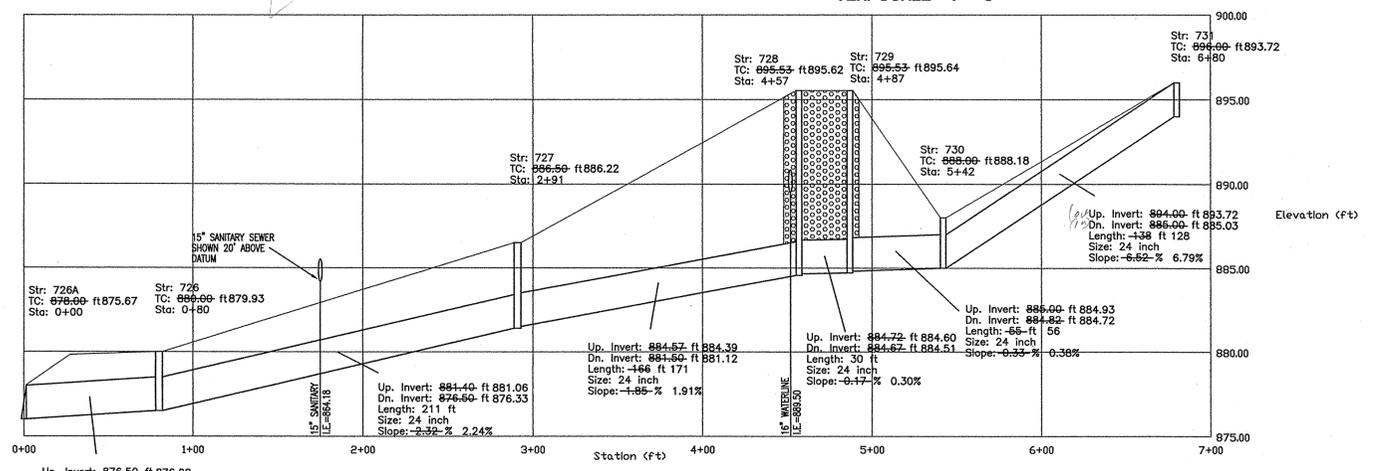7172 GRAHAM ROAD
INDIANAPOLIS, INDIANA 46250
(317) 842-6777 FAX (317) 841-4798
E-Mail: picrpie@picrpie.com




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STORM SEWER PLAN AND PROFILES
LONG BRANCH ESTATES SECTIONS I AND II
PLATINUM PROPERTIES, LLC.
9551 DELEGATES ROW
INDIANAPOLIS, INDIANA 46240
PHONE (317) 816-2600 FAX (317) 816-2910


CERTIFIED BY:
01/27/03
DAVID A. LICI
REGISTERED
PE 10000128
STATE OF INDIANA
PROFESSIONAL ENGINEER

Drawn by: CH/FR
Checked by: GM
Quality Assurance: DL


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Date: 11/28/01
Project Number: 980401-20200

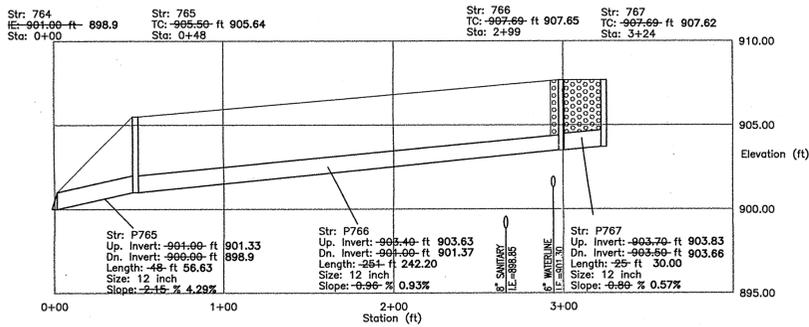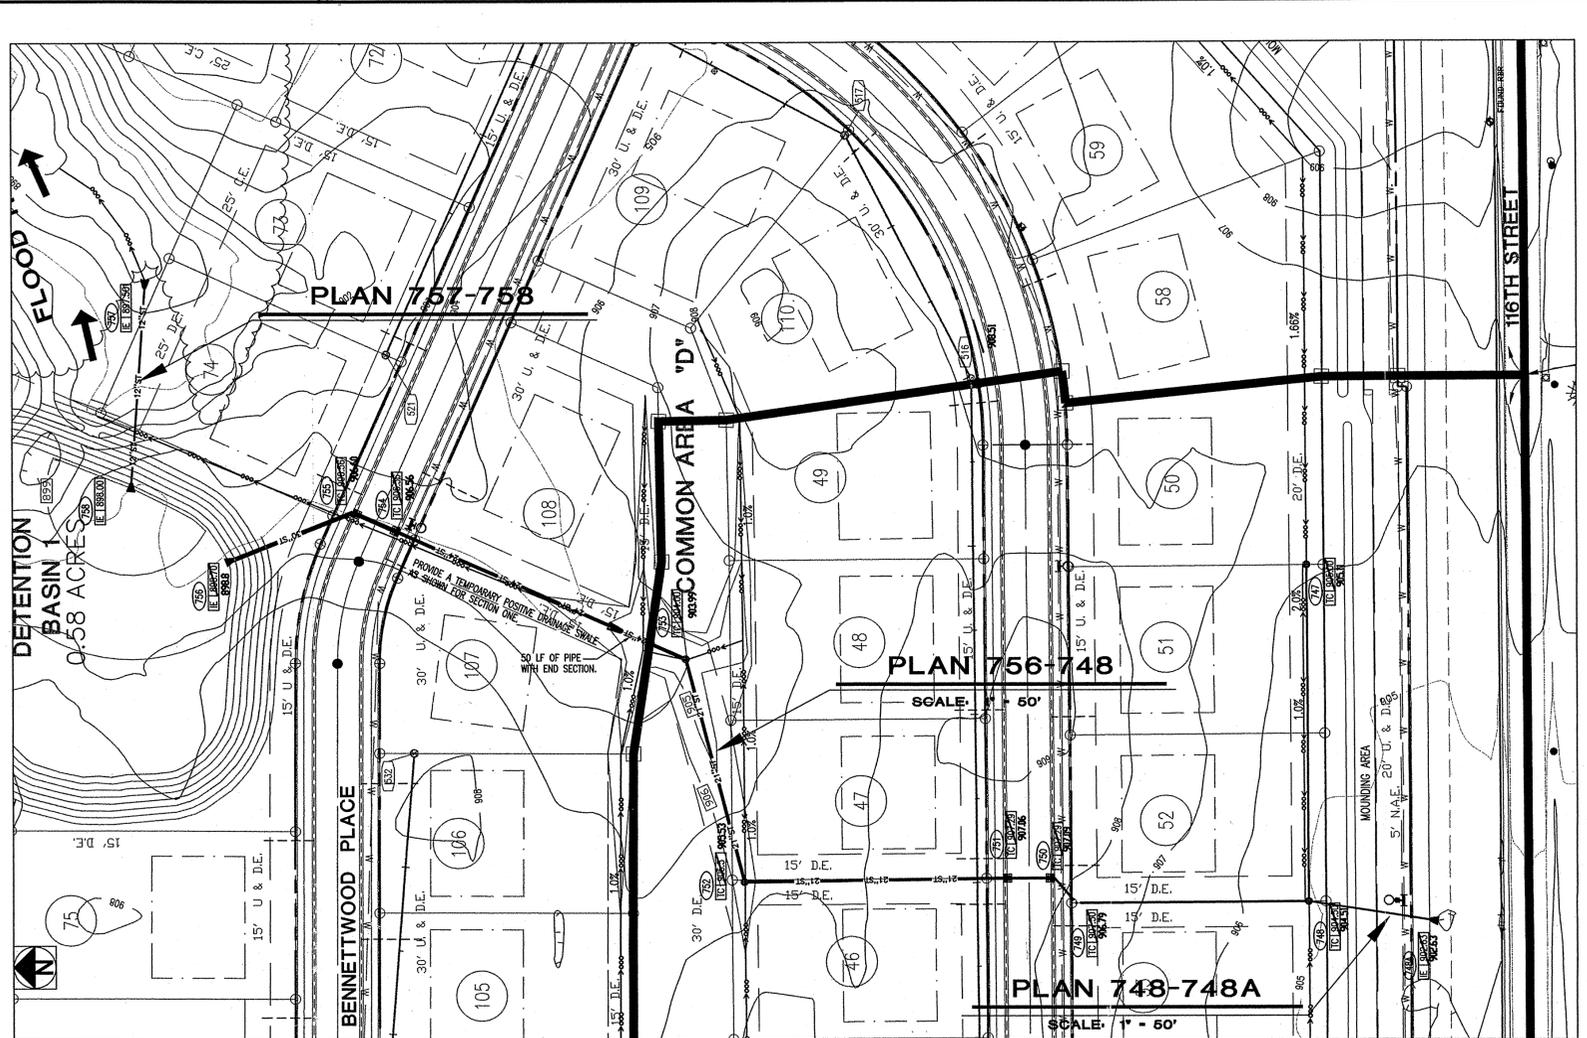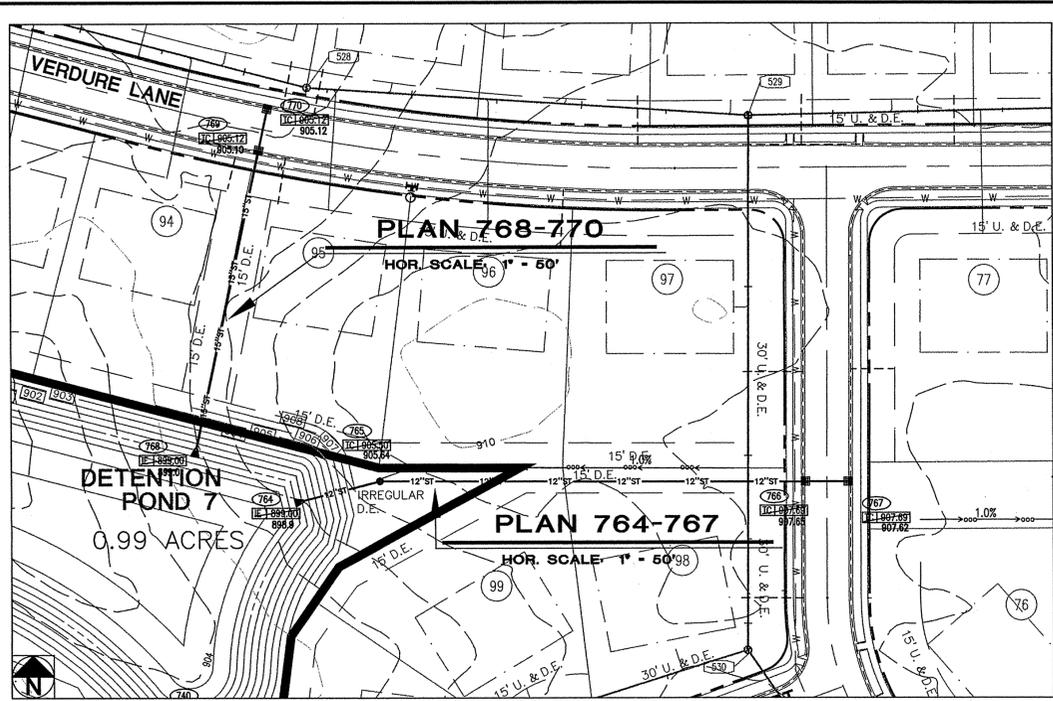


PROFILE 764-767
HOR. SCALE: 1" = 50'
VER. SCALE: 1" = 5'

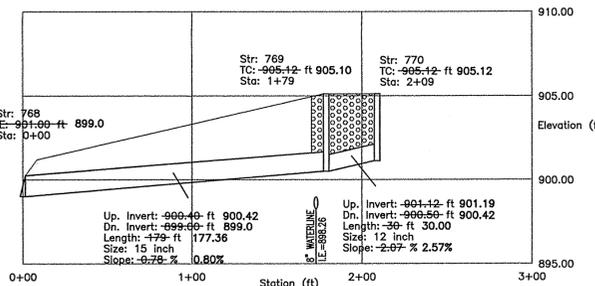


PROFILE 768-770
HOR. SCALE: 1" = 50'
VER. SCALE: 1" = 5'

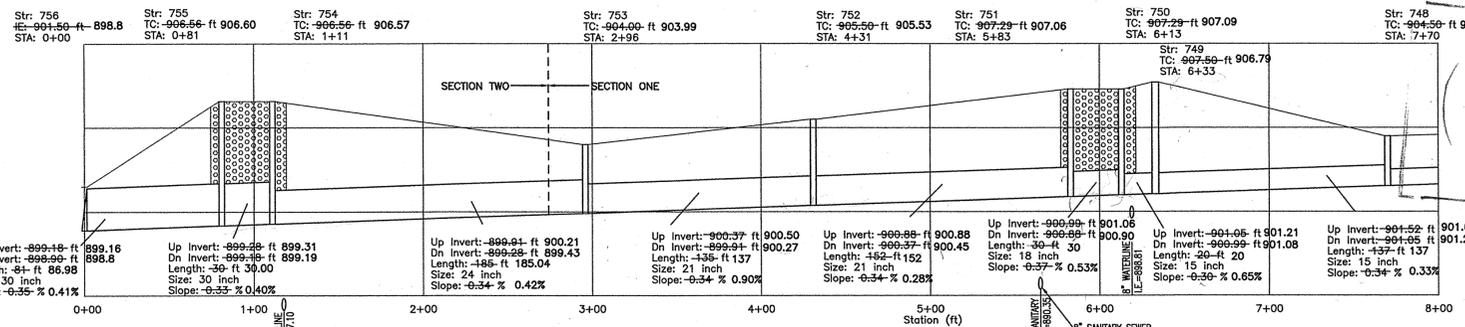

PROFILE 756-748
HOR. SCALE: 1" = 50'
VER. SCALE: 1" = 5'

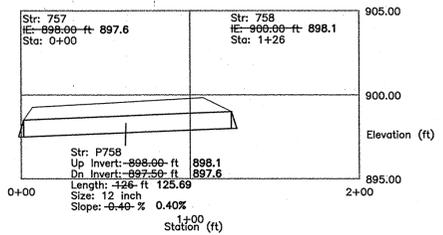

PROFILE 757-758
HOR. SCALE: 1" = 50'
VER. SCALE: 1" = 5'

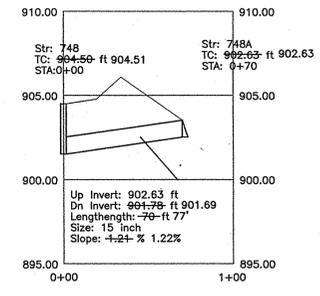


PROFILE 748-748A
HOR. SCALE: 1" = 50'
VER. SCALE: 1" = 5'



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date 01/24/03

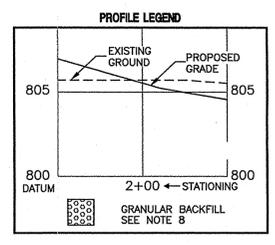

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FOR CALLS OUTSIDE OF INDIANA

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9551 DELEGATES ROW
INDIANAPOLIS, INDIANA 46240
PHONE (317) 818-2800
FAX (317) 818-2810

ARCHITECTURE: CIVIL ENGINEERS, LAND PLANNING, LAND SURVEYORS, CONSULTANTS, TRANSPORTATION ENGINEERS, GIS


7172 GRAHAM ROAD
INDIANAPOLIS, INDIANA 46250
(317) 842-6777 FAX (317) 841-4798
E-Mail: picrpie@picrpie.com

CRPIE

CERTIFIED BY: [Signature]
01/27/03
REGISTERED PROFESSIONAL ENGINEER
PE 10000126
STATE OF INDIANA
DISCIPLINARY ENGINEER


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Checked by: GM
Quality Assurance: DL

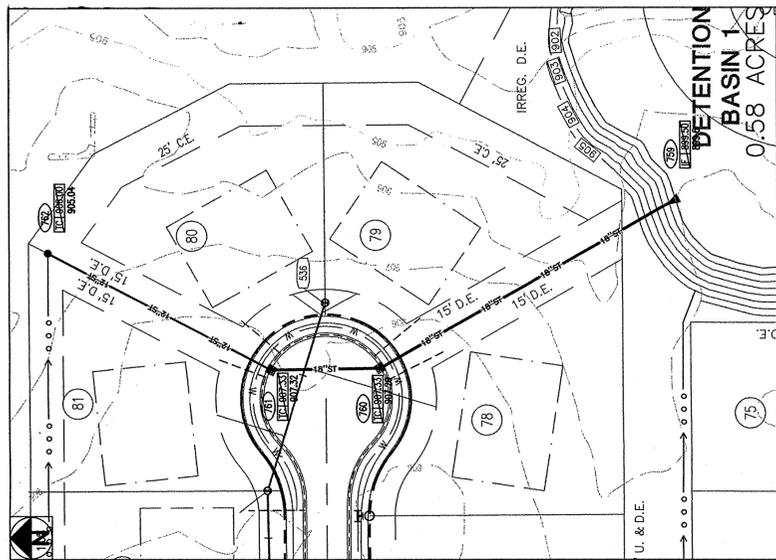Scale: 1" = 50'
Sheet: **C704**
Date: 11/28/01
Project Number: 980401-20200



PLAN 759-762

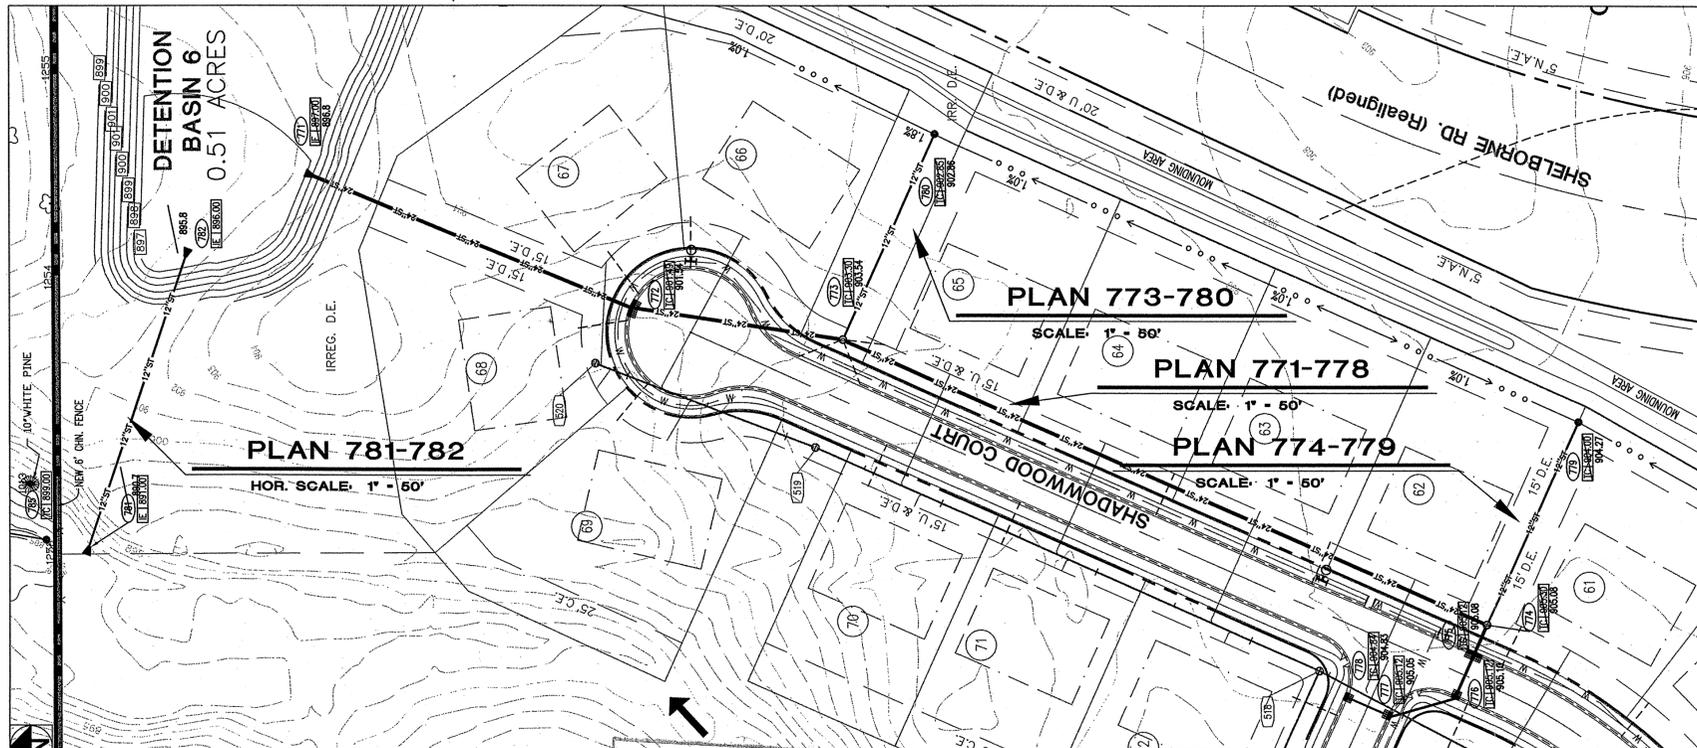HOR. SCALE: 1" = 60'



**DETENTION BASIN 6
0.51 ACRES**

PLAN 781-782

HOR. SCALE: 1" = 50'

PLAN 773-780


SCALE: 1" = 50'

PLAN 771-778

SCALE: 1" = 50'

PLAN 774-779

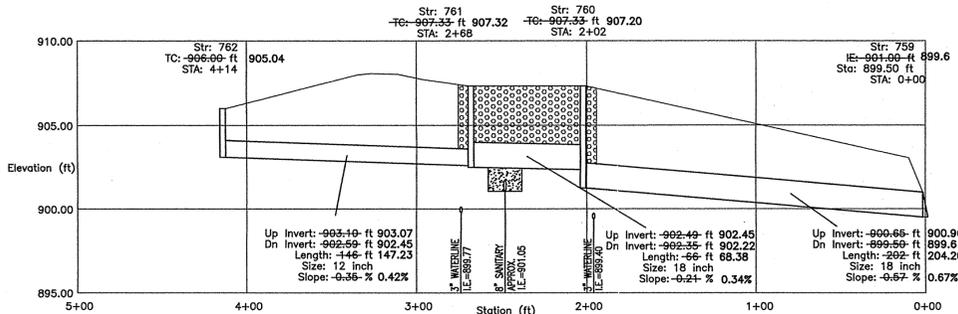SCALE: 1" = 50'




PROFILE 759-762

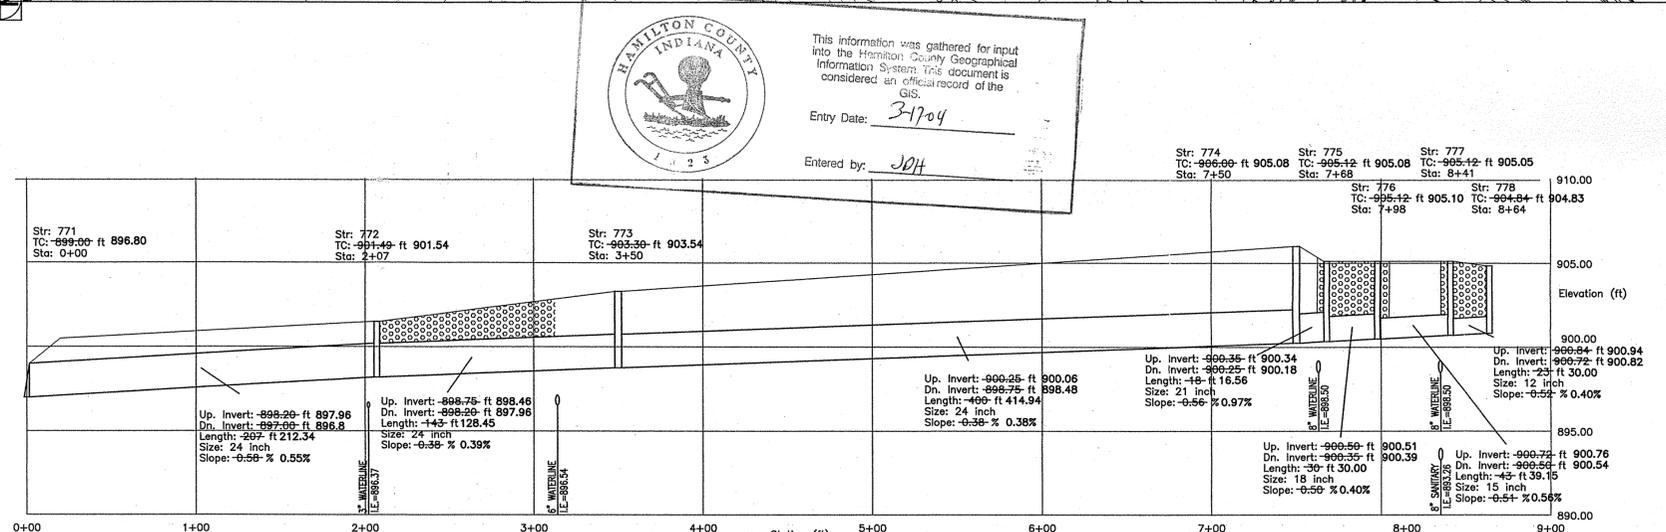HOR. SCALE: 1" = 50'
VER. SCALE: 1" = 5'

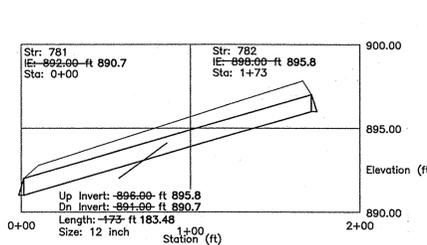
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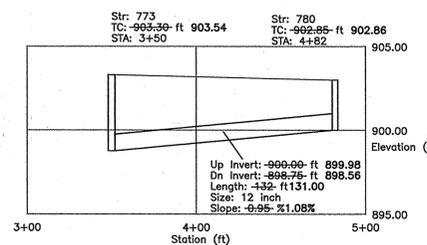
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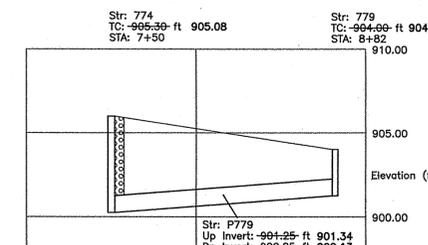
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HOR. SCALE: 1" = 50'
VER. SCALE: 1" = 5'



PROFILE 773-780

HOR. SCALE: 1" = 50'
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PROFILE 774-779


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Quality Assurance: DL
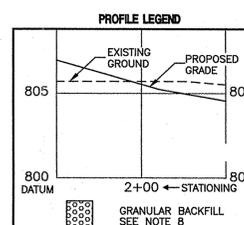
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