



Kenton C. Ward, CFM Surveyor of Hamilton County Phone (317) 776-8495 Fax (317) 776-9628

Suite 188 One Hamilton County Square Noblesville, Indiana 46060-2230

November 1, 2019

To: Hamilton County Drainage Board

Re: William Lehr Drain, Joseph & Brooks Arm, Campus Center Relocation.

Attached are plans for the proposed relocation of a portion of the William Lehr Drain, Joseph & Brooks Arm. The proposal is to reconstruct and relocate the existing tile drain currently on parcels 10-11-16-00-00-023.003 and 10-11-16-00-00-023.000 (proposed Campus Center site) owned by Campus Center, LLC, and Promise Road right-of-way owned by the City of Noblesville. The relocated drain will also affect parcel 10-11-16-00-00-020.101 owned by Noblesville Airport Inc., parcel 10-11-16-00-00-021.101 owned by Larry D & Marianne Jacobi & Janet Sue Roberts, and parcel 10-11-16-00-04-069.000 (Common Area) owned by Waterman Farms Homeowners Association, Inc., per the 'Campus Center' project plans by Kimley-Horn and Associates, Inc., Job No. 170072000.3.700, dated August 19, 2019. The Campus Center site is located at the northeast corner of 146th & Promise Road. The upstream end of this relocation will begin near the northeast corner of the Campus Center site. The downstream end of this relocation will end at an existing regulated drain manhole in Waterman Farms, Sec. 3, Common Area 9, which was previously reconstructed as part of the 2005 Waterman Farms Relocation.

This project will consist of the following:

797' of 24" RCP

Per the project plans by Kimley-Horn, this relocation project involves the following structures: D2, D1A, D1, and EX1. The other storm facilities on this site will remain private.

The newly installed drain will have a length of 797'. On the Joseph & Brooks Arm, the existing 1010' of tile drain between existing stations 3+25 and 13+35 on the Campus Center site will be vacated. Existing Sta. 3+25 is located near the east right-of-

way line of Promise Road, approximately 420' north of the centerline of 146th street. The existing 10" tile across the Noblesville Airport (Sta 13+35 to 21+48; Str 509 in Waterman Farms Subdivision) will remain. A new pipe will drain the Campus Center site north across the east end of the airport and Jacobi parcels to connect to Str. EX1, which is an existing regulated drain manhole located in Waterman Farms, Sec. 3 (per Waterman Farms Relocation - Str 506).

This proposal will subtract 213' of footage from the drain's total length.

The Eli Brooks Drain was established in 1893 (See Reviewers Report, December 7, 1893) and combined with the William Lehr Drain, Booth-White and Joseph Drains in 1967. The drains are currently on a maintenance program which was approved at hearing on December 4, 1967 (See Minutes Book 1, Page 23). For information regarding the 2005 Waterman Farms Relocation referenced above, see Minutes Book 8, Page 568-569. To avoid confusion, it should be noted that another reconstruction of this drain has also been petitioned downstream of this location and is called the Brooks Farm, Sec. 1 Reconstruction.

In 2008, the Wm Lehr Drain, LN Joseph & Eli Brooks Arm from Station 0 to Station 0+38 was vacated by the Board on behalf of the Hamilton County Highway Department's construction of 146th street. This was done as per my report dated October 16, 2007 and approved on January 28, 2008. For more information see Minutes Book 11 pages 12-13. Per Map Correction-Field Verification report dated November 28, 2011, it was determined that the 146th Street and Promise Road intersection widening actually removed the old tile (installed 1898) from Station 0 to Station 3+25, where an inlet was set on the existing tile. (Station 3+25 is the upstream end of the tile being vacated with this petition).

The cost of the project is to be paid by the developer. The petitioner has submitted surety in the form of a Site Improvement Performance Bond as follows:

Bonding Company: Platte River Insurance Company

Date: October 8, 2019 Expiration Date: N/A Number: 41403303

For: Stormwater Legal Drain at NEC (northeast corner) of Promise and 146th Street,

(Campus Center – Lehr Drain)

Amount: \$92,000.00 HCDB-2019-00041

A portion of this project site is located within the William Lehr, Joseph & Brooks Arm Summer Road deferred assessment area. Parcel 10-11-16-00-023.003 owes \$13,462.46 for 17.08 acres and 10-11-16-00-00-023.000 owes \$2,380.36 for 3.02 acres. Because the site is being developed, the assessment is to be paid at this time and should be made a condition of this approval.

The easements for this drain relocation shall be as follows:

For the <u>onsite</u> easement within Campus Center, the easement shall be as per the easement shown on the Campus Center Secondary Plat, to be recorded at the Hamilton County Recorder's Office. (Note: The petitioner has communicated the plat will be recorded prior to the hearing). A Non-enforcement has been submitted to reduce the regulated drain easement to the dimensions shown on the above document. I recommend approval of the Non-enforcement.

The <u>offsite</u> easement across parcel 10-11-16-00-00-020.101 owned by Noblesville Airport Inc., and parcel 10-11-16-00-00-021.101 owned by Larry D & Marianne Jacobi & Janet Sue Roberts, as per the easement dedication described in the "Grant of Permanent and Temporary Drainage Easements." See attached easement document with exhibits A and B. The regulated drain easement shall have a width of 30' total, with an additional 20' temporary construction easement. Upon approval by the Board, this easement dedication shall be recorded.

I recommend the Board set a hearing for December 19, 2019.

Sincerek

Kenton C. Ward

Hamilton County Surveyor

KCW/stc

HAMILTON COUNTY DRAINAGE BOARD NOBLESVILLE, INDIANA

IN RE:	Hamilton County, Indiana)
	PETITION FOR RELOCATION AND RECONSTRUCTION
	Jackson Development, LLC (hereinafter Petitioner"),
hereby	petitions the Hamilton County Drainage Board for authority to relocate and improve a
section	of the Drain, and in support of
	etition advises the Board that:
1.	Petitioner owns real estate through which a portion of the William Lehr
	Drain runs.
2.	Petitioner plans to develop its real estate with roads, buildings, utilities, storm drains,
	sanitary sewers and other structures.
3.	Petitioner's proposed development of its real estate will require relocation and
	reconstruction of a portion of the Drain, as
	specifically shown on engineering plans and specifications filed with the Hamilton
	County Surveyor.
4.	The work necessary for the proposed relocation and reconstruction will be undertaken at
	the sole expense of the Petitioner and such work will result in substantial improvement to
	the Drain, without cost to other property owners
	on the watershed of the William Lehr Drain.
,	WHEREFORE, Petitioner requests that an Order issued from the Hamilton County
	age Board authorizing relocation and reconstruction of theWilliam Lehr
Drain,	in conformance with applicable law and plans and specifications on file with the Hamilton
	y Surveyor.

Adobe PDF Fillable Form

Signed

Carter Jackson
Printed

FINDINGS AND ORDER

CONCERNING THE PARTIAL VACATION OF THE

William Lehr Drain, Joseph & Brooks Arm Campus Center Relocation

Station 3+25 to Station 13+35

On this 19th day of December, 2019, the Hamilton County Drainage Board has held a hearing on the Maintenance Report and Schedule of Assessments of the William Lehr Drain, Joseph & Brooks Arm, Campus Center Relocation (Station 3+25 to Station 13+35).

Evidence has been heard. Objections were presented and considered. The Board then adopted an order of action. The Board now finds that the costs of continued maintenance to the portion of the above drain exceed the benefits to the real estate benefited by the portion of the drain to be abandoned and issues this order vacating the above section of the William Lehr Drain, Joseph & Brooks Arm, Campus Center Relocation (Station 3+25 to Station 13+35).

HAMILTON	COUNTY	DRAINAGE	BOARD
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President	age		0
A	En	della	m.
Member		10	- Fre
Member			

Attest: Liggette Maskouigh

STATE OF INDIANA)
) ss:
COUNTY OF HAMILTON)

BEFORE THE HAMILTON COUNTY DRAINAGE BOARD NOBLESVILLE, INDIANA

IN THE MATTER OF THE RECONSTRUCTION OF THE

William Lehr Drain, Joseph & Brooks Arm, Campus Center Relocation

FINDINGS AND ORDER FOR RECONSTRUCTION

The matter of the proposed Reconstruction of the William Lehr Drain, Joseph & Brooks Arm, Campus Center Relocation came before the Hamilton County Drainage Board for hearing on December 19, 2019, on the Reconstruction Report consisting of the report and the Schedule of Damages and Assessments. The Board also received and considered the written objection of an owner of certain lands affected by the proposed Reconstruction, said owner being:

Evidence was heard on the Reconstruction Report and on the aforementioned objections.

The Board, having considered the evidence and objections, and, upon motion duly made, seconded and unanimously carried, did find and determine that the costs, damages and expenses of the proposed Reconstruction will be less than the benefits accruing to the owners of all land benefited by the Reconstruction.

The Board having considered the evidence and objections, upon motion duly made, seconded and unanimously carried, did adopt the Schedule of Assessments as proposed, subject to amendment after inspection of the subject drain as it relates to the lands of any owners which may have been erroneously included or omitted from the Schedule of Assessments.

The Board further finds that it has jurisdiction of these proceedings and that all required notices have been duly given or published as required by law.

Wherefore, it is ORDERED, that the proposed Reconstruction of the William Lehr Drain, Joseph & Brooks Arm, Campus Center Relocation be and is hereby declared established.

Thereafter, the Board made inspection for the purpose of determining whether or not the lands of any owners had been erroneously included or excluded from the Schedule of Assessments. The Board finds on the basis of the reports and findings at this hearing as follows:

HAMILTON COUNTY DRAWNAGE BOARD

PRÉSIDENT

Member

Member

ATTEST:



120% \$


92,000.00

Engineer's Preliminary Opinion of Probable Construction Cost

Name:	Campus Center, Noblesville, IN	Date:	10/7/2019
	•	Prepared By:	WAB
Client:	Carter Jackson Development	r reparca by.	WALE

Off-Site Legal Drain

Item	Description	Unit	Quantity		Unit Price		Cost
1	Mobilization/Demobilization	LS	1	\$	3,066.67	\$	3,066.67
2	24" RCP Storm Sewer	LF	797	\$	56.00	\$	44,632.00
3	Manhole	EA	3	\$	2,225.00	\$	6,675.00
4	Granular Backfill	LS	1	\$	22,293.00	\$	22,293.00
				Total	Estimated Cost	Ś	76,666.67

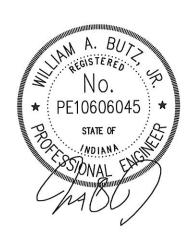

Campus Center - Lehr Drain

SITE IMPROVEMENT PERFORMANCE BOND

1,00 × 00 × 0	Bond No: 41403303
	HCDB-2019-00041
verific de AFAG	KNOW ALL MEN BY THESE PRESENTS That we,
	Jackson Development, LLC
	located at 19 E Main St, Ste 300, Carmel, IN 46032-1920
	alifnoffzed to do DUSINGSS III
	the State of Indiana as Surety, are held and firmly bound unto the Hamilton County Commissioners
One Hamilton	County Square, Ste 157, Noblesville, IN , as Obligee, in the full and just sum of Ninety-two Thousand And No/100
	(\$\$92,000.00) lawful money of the United States of
	America, to be paid to said Obligee, for which payment well and truly to be made, we bind ourselves, our
	heirs, executors, administrators, successors and assigns, jointly and severally, firmly by these presents.
	WHEREAS, the Principal has received or is about to receive a site plan approval from the Obligee for site improvements only at a project and site improvements described as Stormwater Legal Drain at NEC of
	Promise and 146th Street
	With certain related bondable site improvements; the satisfactory completion of which is required to be guaranteed as a condition of the approval.
	 WHEREAS, the bond is subject to the following conditions: a) No party other than the Obligee shall have rights hereunder against the Surety. b) The aggregate liability of the Surety shall not exceed the above stated bond amount for any cause or reason whatsoever.
•	NOW, THEREFORE, the condition of this obligation is such that, if said Principal shall complete the improvements as agreed to in the Site Improvement Plan then this obligation shall be null and void, otherwise to remain in full force and effect.
	This bond shall become effective on 10/8/2019 and shall remain in force until released by the Obligee.
	Signed sealed and dated this 8th day of October, 20 19.
	Principal Jackson Development, LLC
	on Clarle Galon,
	BY: Charles C). Jackson
	Printed name and title
	The state of the s
	Surety: Platte River Insurance Company
	BY: Attorney-ih-Fact: Tiffany T. Williams
	ALIVA THINK
	Power of Attorney must be attached to the bond to be valid

PLATTE RIVER INSURANCE COMPANY POWER OF ATTORNEY

41403303

	TOMER OF WITOWING	
KNOW ALL MEN BY THESE PRESENTS, That the its principal offices in the City of Middleton, Wisconsi	ne PLATTE RIVER INSURANCE COMP. an, does make, constitute and appoint	ANY, a corporation of the State of Nebraska, having
STELLA M. MII	LLI, TIFFANY T. WILLIAMS; MICHAEL K.	CORCORAN J. WAGGONER
its true and lawful Attorney(s)-in-fact, to make, execute, and contracts of suretyship, provided that no bond or un	seal and deliver for and on its behalf, as surety,	and as its act and deed, any and all bonds, undertakings
ALL WRITTEN	I INSTRUMENTS IN AN AMOUNT NOT I	TO EXCEED\$20,000,000.00
This Power of Attorney is granted and is signed and se Directors of PLATTE RIVER INSURANCE COMP.	ealed by facsimile under and by the authority ANY at a meeting duly called and held on the	of the following Resolution adopted by the Board of 8th day of January, 2002.
TRESOLVED , that the President, Executive Vice Presare granted the power and authorization to appoint by other writings obligatory in the nature thereof, one or the powers and duties usual to such offices to the busin such power of attorney or to any certificate relating the or facsimile seal shall be valid and binding upon the Coshall be valid and binding upon the facility is attached. Any such appointment may be revenued.	sident, Vice President, Secretary or Treasurer a Power of Attorney for the purposes only or more resident vice-presidents, assistant secre- ness of this company; the signature of such of hereto by facsimile, and any such power of at Company, and any such power so executed a future with respect to any bond or undertaking	, acting individually or otherwise, be and they hereby f executing and attesting bonds and undertakings, and etaries and attorney(s)-in-fact, each appointee to have fficers and seal of the Company may be affixed to any torney or certificate bearing such facsimile signatures and certified by facsimile signatures and facsimile seal and or other writing obligatory in the nature thereof to
In connection with obligations in favor of the Florida Attorney-in-Fact includes any and all consents for the required by the State of Florida Department of Transport making payment of the final estimate to the Contracto	e release of retained percentages and/or fina ortation. It is fully understood that consentin	l estimates on engineering and construction contracts g to the State of Florida Department of Transportation
In connection with obligations in favor of the Kentuc Attorney-in-Fact cannot be modified or revoked unles Highways of the Commonwealth of Kentucky at least	s prior written personal notice of such intent	has been given to the Commissioner – Department of
IN WITNESS WHEREOF, the PLATTE RIVER IS corporate seal to be hereto affixed duly attested, this 3 Attest:	NSURANCE COMPANY has caused these	
John E. Rzepinski Vice President, Treasurer & CFO Suzanne M. Broadbent Assistant Secretary STATE OF WISCONSIN COUNTY OF DANE STATE OF WISCONSIN S.S.:	SEAL **REBRASKA** THE STEPHEN I SI'lls to me known, who being	PLATTE RIVER INSURANCE COMPANY Stephen J. Sills CEO & President
On the 3 rd day of May, 2017 before me personally can the County of New York. State of New York: that I	the is President of PLATTE RIVER INSUR the seal of the said corporation; that the seal	by me duly sworn, did depose and say: that he resides ANCE COMPANY, the corporation described in and affixed to said instrument is such corporate seal; that it thereto by like order.
STATE OF WISCONSIN COUNTY OF DANE S.S.:	VALVE CONSOLITATION OF VISCOLITATION OF	David J. Regele Notary Public, Dane Co., WI My Commission Is Permanent
I the undersigned, duly elected to the office sta	HEREBY CERTIFY that the foregoing at tion of the Board of Directors, set forth in the	TE RIVER INSURANCE COMPANY, a Nebraska tached Power of Attorney remains in full force and have the Power of Attorney is now in force.
	(SEAL)	Antonio Celii
	CONTROL .	neral Counsel, Vice President & Seccretary
THIS DOCUMENT IS NOT VALID UNLESS PRINTED CORNER. IF YOU HAVE ANY QUESTIONS CONCER	ON GREEN SHADED BACKGROUND WITH NING THE AUTHENTICITY OF THIS DOCUM	A RED SERIAL NUMBER IN THE UPPER RIGHT HAND ENT CALL 800-475-4450. PR-POA (Rev. 10-201

BEFORE THE HAMILTON COUNTY DRAINAGE BOARD IN THE MATTER OF

William Lehr Drain, Joseph & Brooks Arm Campus Center Relocation

NOTICE

Го	Whom	Ιt	May	Concern	and:	
					-	

Notice is hereby given of the hearing of the Hamilton County Drainage Board concerning the reconstruction of the William Lehr Drain, Joseph & Brooks Arm, Campus Center Relocation on December 19, 2019 at 9:00 A.M. in Commissioners Court, Hamilton County Judicial Center, One Hamilton County Square, Noblesville, Indiana. Construction and maintenance reports of the Surveyor and the Schedule of Assessments proposed by the Drainage Board have been filed and are available for public inspection in the office of the Hamilton County Surveyor.

Hamilton County Drainage Board

Attest: Lynette Mosbaugh

ONE TIME ONLY

STATE	OF	INDIANA)				
)	SS	BEFORE	THE	HAMILTON
)				
COUNTY	Z OF	HAMILTON)		DRAINA	GE BO	DARD

IN THE MATTER OF William Lehr Drain, Joseph & Brooks Arm, Campus Center Relocation

NOTICE

Notice is hereby given that the Hamilton County Drainage Board at its regular meeting **December 19, 2019** adopted the reconstruction report of the Surveyor and the Amended Schedule of damages and assessments including annual assessment for periodic maintenance, finding that the costs, damages and expense of the proposed improvement would be less than the benefits which will result to the owner of lands benefited thereby.

The Board issued an order declaring the proposed improvement established. Such findings and order were marked filed and are available for inspection in the Office of the Hamilton County Surveyor.

If judicial review of the findings and order of the Board is not requested pursuant to Article VIII of the 1965 Indiana Drainage Code as amended within twenty (20) days from the date of publication of this notice, the findings and order shall become conclusive.

HAMILTON COUNTY DRAINAGE BOARD

BY: Christine Altman
PRESIDENT

ATTEST: Lynette Mosbaugh
SECRETARY





Kenton C. Ward, CFM Surveyor of Hamilton County Phone (317) 776-8495 Fax (317) 776-9628 Suite 188 One Hamilton County Square Noblesville, Indiana 46060-2230

To: Hamilton County Drainage Board

November 2, 2021

Re: William Lehr Drain: Joseph & Brooks Arm - Campus Center Relocation

Attached are as-built, certificate of completion & compliance, and other information for the Campus Center Relocation. An inspection of the drainage facilities for this section has been made and the facilities were found to be complete and acceptable.

During construction, changes were made to the drain, which will alter the plans submitted with my report for this drain-dated November 1, 2019. The report was approved by the Board at the hearing held December 19, 2019. (See Drainage Board Minutes Book 19, Pages 83-86) The changes are as follows: The 24" RCP was shortened from 797 to 796 feet. The length of the drain due to the changes described above is now **796 feet**. It should be noted that the project removed 1010 feet of existing tile.

The non-enforcement was approved by the Board at its meeting on December 19, 2019 and recorded under instrument #2021079140.

The following sureties were guaranteed by Platte River Insurance Company and released by the Board on its April 12, 2021 meeting.

Bond-LC No: 41403303

Amount: \$92,000

For: Storm Sewers & SSD Issue Date: October 8, 2019


I recommend the Board approve the drain's construction as complete and acceptable.

Sincerely,

Kenton C. Ward, CFM Hamilton County Surveyor

CERTIFICATE OF COMPLETION AND COMPLIANCE

To: Hamilton County Surveyor
Re: Nublesville Campus Center
I hereby certify that:
1. I am a Registered Land Surveyor or Engineer in the State of Indiana.
2. I am familiar with the plans and specifications for the above referenced subdivision.
3. I have personally observed and supervised the completion of the drainage facilities for the above referenced subdivision.
4. The drainage facilities within the above referenced subdivision to the best of my knowledge, information and belief have been installed and completed in conformity with all plans and specifications.
 The drainage facilities within the above referenced subdivision to the best of my knowledge, information and belief have been correctly represented on the Record Drawings, Digital Record Drawings and the Structure Data Spreadsheet.
Signature:
Type or Print Name: William A. But 2 Jr.
Business Address: 250 E. 96th Street, Suite 580
Indpls, IN 46240
Telephone Number: 317 - 218 - 9566
SEALA INDIANA REGISTRATION NUMBER PE 10 C060 45 STATE OF

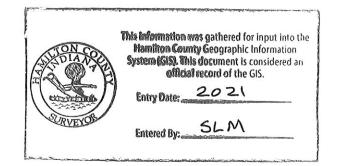

INFRASTUCTURE ENGINEERING PLANS

CAMPUS CENTER

NEC OF 146TH ST & PROMISE RD NOBLESVILLE, IN 46060

LOCATION MAP (NOT TO SCALE) E 156TH STREET NOBLESVILLE AIRPORT-180 146TH STREE PROJECT LOCATION

THE CITY OF NOBLESVILLE STANDARDS FOR PUBLIC INFRASTRUCTURE CONSTRUCTION SHALL BE INCORPORATED BY REFERENCE INTO THESE PLANS. IN THE EVENT THAT CONFLICTING STANDARDS OCCUR, THE FOLLOWING ORDER OF PRECEDENCE SHALL GOVERN.

- A. CITY OF NOBLESVILLE STANDARDS
- B. INDIANA DEPARTMENT OF TRANSPORTATION STANDARDS AND SPECIFICATIONS TEN STATE STANDARDS
- PROJECT SPECIFIC PROVISIONS E. ANY OTHER APPLICABLE STANDARDS AND SPECIFICATIONS

NO ALTERNATE SPECIFICATIONS OR MATERIALS OR NEW MATERIALS MAY BE USED WITHOUT THE EXPRESS WRITTEN APPROVAL FROM THE CITY OF NOBLESVILLE PRIOR TO THE COMPLETION OF THE WORK.

THE CITY'S REVIEW AND APPROVAL OF PLANS FOR THIS PROJECT DOES NOT RELIEVE THE DESIGN PROFESSIONAL OF ITS PROFESSIONAL RESPONSIBILITY FOR THE PLANS. DESIGN PROFESSIONAL CERTIFYING PLANS FOR THIS PROJECT ACKNOWLEDGES THEIR PROFESSIONAL RESPONSIBILITY TO PREPARE WORK THAT IS CORRECT, ACCURATE AND COMPLIES WITH ALL APPROPRIATE LAWS, STANDARDS, REGULATIONS AND ORDINANCES. IF AN ERROR OR OMISSION BY THE DESIGN PROFESSIONAL IS FOUND, THE DESIGN PROFESSIONAL SHALL CORRECT THE ERROR OR OMISSION AND, IF NECESSARY, DETERMINE A SOLUTION THAT COMPLIES WITH ALL APPROPRIATE LAWS, STANDARDS, REGULATIONS AND ORDINANCES. IF SUCH AN ERROR OR OMISSION IS FOUND, THE DEVELOPER IS NOT RELIEVED OF ITS OBLIGATION TO COMPLY WITH ALL APPROPRIATE LAWS, STANDARDS, REGULATIONS, AND ORDINANCES.

UTILITY AND GOVERNING AGENCY CONTACTS

ENGINEERING DEPARTMENT CITY OF NOBLESVILLE 16 S 10TH ST, SUITE 155 NOBLESVILLE, IN 46060 TEL: (317) 776-6330 CONTÀCT: BRIAN GRAY

COMMUNITY DEVELOPMENT & PLANNING CITY OF NOBLESVILLE

16 S 10TH ST, SUITE 150 NOBLESVILLE, IN 46060 TEL: (317) 776-6325 CONTACT: JOYCEANN YELTON

NOBLESVILLE FIRE DEPARTMENT 135 S 9TH ST NOBLESVILLE, IN 46060 TEL: (317) 776-6336 CONTACT: DARREL CROSS

STORM SEWER SERVICE CITY OF NOBLESVILLE 16 S 10TH ST NOBLESVILLE, IN 46060 TEL: (317) 776-6330 CONTÀCT: BRIAN GRAY

MS4 OPERATOR CITY OF NOBLESVILLE 16 S 10TH ST, SUITE 155 NOBLESVILLE, IN 46060 TEL: (317) 776-6330 CONTACT: BRAD ROBINS

STREET DEPARTMENT 1575 PLEASANT ST NOBLESVILLE, IN 46060 TEL: (317) 776-6348

CONTACT: VINCE BAKER

PROJECT TEAM

<u>DEVELOPER</u> JACKSON DEVELOPMENT, LLC 19 EAST MAIN ST., SUITE 300 CARMEL, IN 46032 TEL: (317) 797-1115 CONTACT: CARTER JACKSON

CIVIL ENGINEER KIMLEY-HORN AND ASSOCIATES, INC. 250 E 96TH ST, SUITE 580 INDIANAPOLIS, IN 46240 TEL: (317) 218-9561 EMAIL: BILL.BUTZ@KIMLEY-HORN.COM CONTACT: BILL BUTZ, P.E.

<u>SURVEYOR</u> HAMILTON DESIGNS, LLC 11988 FISHERS CROSSING DRIVE, SUITE 154 FISHERS, IN 46038 TEL: (317) 570-8800 CONTACT: TERRY D. WRIGHT, PS

HAMILTON COUNTY SURVEYOR'S OFFICE

ONE HAMILTON COUNTY SQ, SUITE 146

NOBLESVILLE, IN 46060 TEL: (317) 776-8495

CONTÀCT: STEVE CASH

INDIANAPOLIS, IN 46204

TEL: (317) 610-5437 CONTACT: BRIAN PETERS

TEL: (317) 752-9426

100 S MILL CREEK RD

NOBLESVILLE, IN 46060 TEL: (317) 776-5348

NATURAL GAS COMPANY

16000 ALLISONVILLE RD INDIANAPOLIS, IN 46060

TEL: (317) 776-5560

15227 HERRIMAN BLVD

NOBLESVILLE, IN 46060

CONTACT: PAT O'BRIAN

TEL: (317) 773-2497

CONTACT: RANDY CRUTCHFIELD

INDIANA AMERICAN WATER COMPANY

CONTACT: CLINT THOMPSON

POWER COMPANY DUKE ENERGY

240 N MERIDIAN ST, ROOM 280

(TELECOM PLACEMENT, INC.)

CONTACT: THOMAS SPENCER

COMMUNICATION

COMCAST

VECTREN

LANDSCAPE ARCHITECT KIMELY-HORN AND ASSOCIATES, INC. 250 E 96TH ST, SUITE 580 INDIANAPOLIS, IN 46240 TEL: (317) 218-9571 EMAIL: BRANDON.SCHREEG@KIMLEY-HORN.COM CONTACT: BRANDON SCHREEG




Hydrologic Soil Group

Map unit symbol	Map unit name	Rating	Acres in AOI	Percent of AOI
Br	Brookston silty clay loam, 0 to 2 percent slopes	B/D	27.0	66.5%
CrA	Crosby silt loam, fine- loamy subsoil, 0 to 2 percent slopes	C/D	13.6	33.5%
Totals for Area of Intere	est		40.6	100.0%

AS-BUILT




Officet Number	
C0.0	TITLE SHEET
C0.1	ALTA (SHEET 1 OF 2)
C0.2	ALTA (SHEET 2 OF 2)
C1.0	GENERAL NOTES
C2.1	EXISTING CONDITIONS & DEMOLITION PLAN (1 OF 6)
C2.2	EXISTING CONDITIONS & DEMOLITION PLAN (2 OF 6)
C2.3	EXISTING CONDITIONS & DEMOLITION PLAN (3 OF 6)
C2.4	EXISTING CONDITIONS & DEMOLITION PLAN (4 OF 6)
C2.5	EXISTING CONDITIONS & DEMOLITION PLAN (5 OF 6)
C2.6	EXISTING CONDITIONS & DEMOLITION PLAN (6 OF 6)
C3.0	OVERALL DEVELOPMENT PLAN
C3.1	TYPICAL CROSS SECTIONS
C3.2	ROAD LAYOUT PLAN AND PROFILE (1 OF 6)
C3.3	ROAD LAYOUT PLAN AND PROFILE (2 OF 6)
C3.4	ROAD LAYOUT PLAN AND PROFILE (3 OF 6)
C3.5	ROAD LAYOUT PLAN AND PROFILE (4 OF 6)
C3.6	ROAD LAYOUT PLAN AND PROFILE (5 OF 6)
C3.7	ROAD LAYOUT PLAN AND PROFILE (6 OF 6)
C3.8	ROAD LAYOUT PLAN PROMISE RD STRIPING
C4.1	EROSION CONTROL PLAN (1 OF 6)
C4.2	EROSION CONTROL PLAN (2 OF 6)
C4.3	EROSION CONTROL PLAN (3 OF 6)
C4.4	EROSION CONTROL PLAN (4 OF 6)
C4.5	EROSION CONTROL PLAN (5 OF 6)
C4.6	EROSION CONTROL PLAN (6 OF 6)
C4.7	EROSION CONTROL DETAILS
C4.8	SWPPP
C5.1	GRADING & DRAINAGE PLAN (1 OF 6)
C5.2	GRADING & DRAINAGE PLAN (2 OF 6)
C5.3	GRADING & DRAINAGE PLAN (3 OF 6)
C5.4	GRADING & DRAINAGE PLAN (4 OF 6)
C5.5	GRADING & DRAINAGE PLAN (5 OF 6)
C5.6	GRADING & DRAINAGE PLAN (6 OF 6)
C6.0	OVERALL UTILITY PLAN
C6.1	UTILITY PLAN (1 OF 6)
C6.2	UTILITY PLAN (2 OF 6)
C6.3	UTILITY PLAN (3 OF 6)
C6.4	UTLITY PLAN (4 OF 6)
C6.5	UTILITY PLAN (5 OF 6)
C6.6	UTILITY PLAN (6 OF 6)
C6.7	SANITARY PLAN & PROFILES (1 OF 5)
C6.8	SANITARY PLAN & PROFILES (2 OF 5)
C6.9	SANITARY PLAN & PROFILES (3 OF 5)
C6.10	SANITARY PLAN & PROFILES (4 OF 5)
C6.11	SANITARY PLAN & PROFILES (5 OF 5)
C6.12	WATER PLAN & PROFILES (1 OF 5)
C6.13	WATER PLAN & PROFILES (2 OF 5)
C6.14	WATER PLAN & PROFILES (3 OF 5)
C6.15	WATER PLAN & PROFILES (4 OF 5)
C6.16	WATER PLAN & PROFILES (5 OF 5)
C6.17	STORM PROFILES (1 OF 5)
C6.18	STORM PROFILES (2 OF 5)
C6.19	STORM PROFILES (3 OF 5)
C6.20	STORM PROFILES (4 OF 5)
C6.21	STORM PROFILES (5 OF 5)
C7.0	CONSTRUCTION DETAILS
C7.1	CONSTRUCTION DETAILS
C7.2	CONSTRUCTION DETAILS
C7.3	CONSTRUCTION DETAILS
L1.0	OVERALL LANDSCAPE PLAN
L1.1	LANDSCAPE PLAN (1 OF 5)
L1.2	LANDSCAPE PLAN (2 OF 5)
	LANDSCAPE PLAN (3 OF 5)
L1.3	
_1.4	LANDSCAPE PLAN (4 OF 5)
	LANDSCAPE PLAN (4 OF 5) LANDSCAPE DETAILS (5 OF 5)

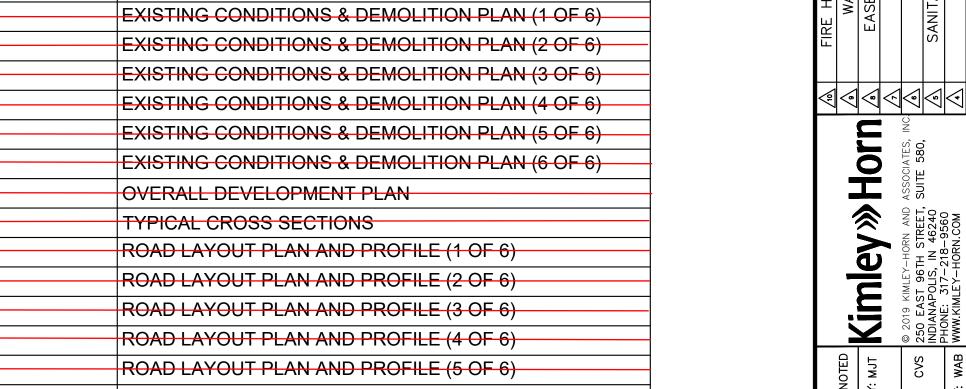

Sheet List Table

|Sheet Number | Sheet Title

Indiana Utilities Protection Service

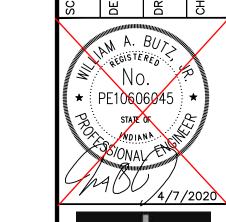


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ORIGINAL ISSUE: 04/29/2019 KHA PROJECT NO. 170072000 SHEET NUMBER

C0.0



Indiana Utilities Protection Service

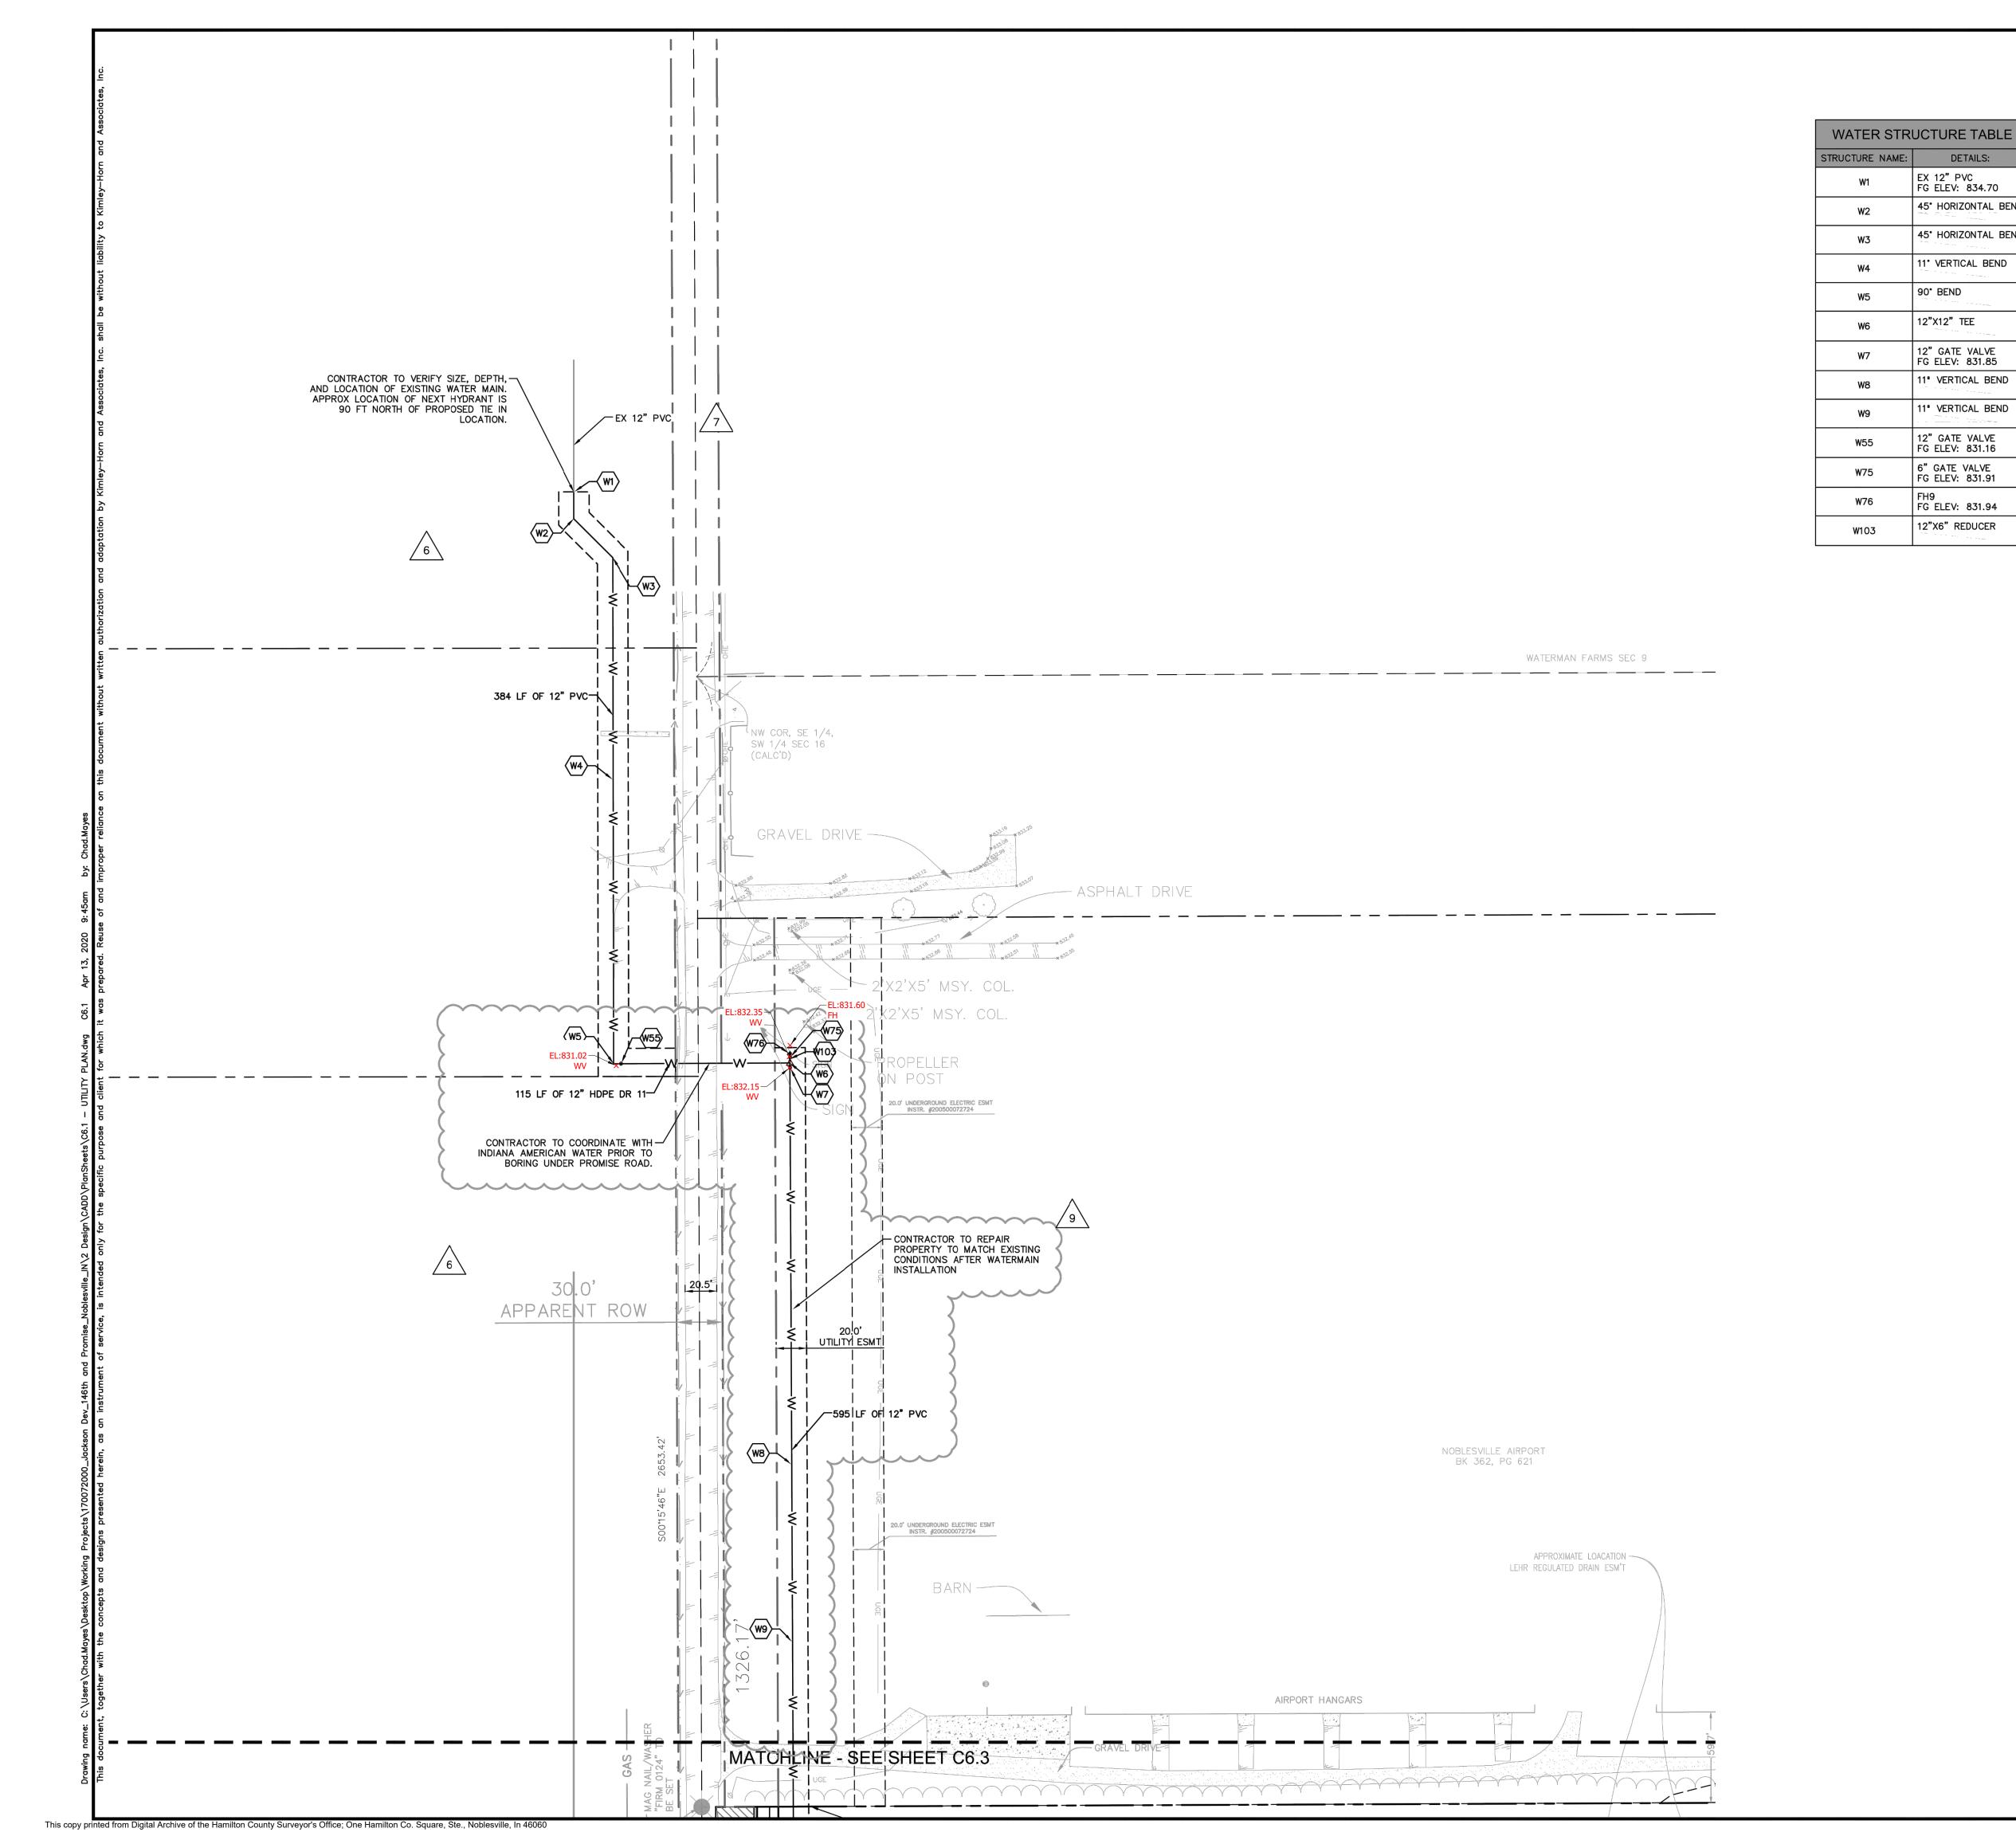DETAILS:

45° HORIZONTAL BEND

45° HORIZONTAL BEND

11° VERTICAL BEND

EX 12" PVC FG ELEV: 834.70

90° BEND

12"X12" TEE

FG ELEV: 831.85

11° VERTICAL BEND

11° VERTICAL BEND

12" GATE VALVE

FG ELEV: 831.16

6" GATE VALVE FG ELEV: 831.91


FG ELEV: 831.94

12"X6" REDUCER

W76

W103



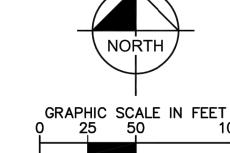

UTILITY NOTES

GENERAL UTILITY NOTES

1. ALL WATER LINES SHALL BE PVC C900 DR-14 OR DUCTILE IRON CL 52

MAINTAIN 8 FEET OF HORIZONTAL SEPARATION BETWEEN THE WATER MAIN AND ANY STORM AND SANITARY STRUCTURES, IN LOCATIONS WHERE SEPARATION CANNOT BE MAINTAINED, USE THE APPROVED ALTERNATIVE TECHNICAL STANDARD. INSTALL THE WATER MAIN WITHIN A STEEL CASING OR INSTALL THE WATER MAIN SUCH THAT IT IS CENTERED ON THE STRUCTURE AND THE NEAREST JOINT IS 10 FT AWAY AND MAINTAIN 24 IN OF SEPARATION.

3. ALL SANITARY SEWER LINES SHALL BE PVC MEETING, ASTM D-3034 SDR 26 EXCEPT FOR SANITARY SEWER THAT CROSSES ABOVE WATER MAIN, THIS PIPE SHALL BE AWWA C900 (UNLESS WATER MAIN CASING IS UTILIZED). PROVIDE <u>54"</u> MINIMUM COVER.


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- 14. SEE DETAILS FOR LOCATING STORM STRUCTURES WITHIN THE CURB LINE.
- 15. STORMWATER FACILITIES MUST BE FUNCTIONAL BEFORE BUILDING CONSTRUCTION

UTILITY LEGEND

20 LF OF 4" UNDERDRAIN, TYP. EX. SANITARY SEWER MANHOLE EX. STORM MANHOLE EX. STORM CATCH BASIN/INLET EX. ELECTRIC MANHOLE EX. LIGHT POLE PROPOSED STORM STRUCTURE PROPOSED SANITARY MANHOLE PROPOSED SANITARY CLEANOUT PROPOSED WATER STRUCTURE PROPOSED LIGHT POLE

> NOTE: CONTRACTOR TO CAP AND MARK END OF STUB FOR ALL SANITARY LATERALS. SANITARY LATERALS TO BE 6" PVC WITH 1% MINIMUM SLOPE.

AS-BUILT

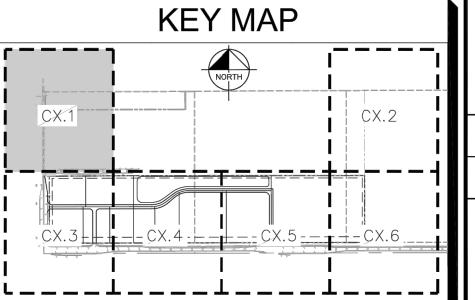

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ORIGINAL ISSUE: 04/29/2019

KHA PROJECT NO. 170072000 SHEET NUMBER

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CONTRACTOR TO VERIES SIZE DEPTH	
CONTRACTOR TO VERIFY SIZE, DEPTH, AND LOCATION OF STORM LINE.	
	sdmh rim: 818.60 ie=816.12 (12"hdpe w) ie=816.12 (12"hdpe n)
EXI)	3.90
TERMAN FARMS SE >>> >>> SEL:818	Ci N89°51'15"E 1330.23'
hout writ	
NE COR, SW 1/4, SE 1/4 SEC 16 (CALC'D)	
(CALC'D) 9 0 0 0 0 0 0 0 0 0 0 0 0 0 0 0 0 0	FINISHED GRADE
8 8 9 1 1 1 1 1 1 1 1 1 1 1 1 1 1 1 1 1	
391 LF OF—	
391 LF OF——————————————————————————————————	
STORM LINE 1—	ALL OTHER WITHIN OR 30—FT AIRPORT FROM THE GRASS
	PROPERTY RUNWAY
	1 FLOWABLE FILL TO BE PLACED AROUND PIPE AND UP TO 6 INCHES ABOVE PIPE. 2 MECHANICALLY COMPACTED #53 CRUSHED STONE IN 6 INCH LIFTS TO 95% OF A STANDARD PROCTOR.
	STANDARD PROCTOR. 3 SOD TO BE PLACED AND WATERED IN FLUSH WITH EXISTING GRADE.
	#53 CRUSHED STONE MECHANICALLY COMPACTED UNTIL 6 INCHES OVER PIPE TO 95% OF A STANDARD PROCTOR.
	NATIVE SOIL TO BE MECHANICALLY COMPACTED TO 95% OF A STANDARD PROCTOR.
the spanning of the spanning o	LEGAL DRAIN BEDDING DETAILS ON AIRPORT PROPERTY N.T.S.
	322.02 IH D1
REFER TO DETAIL ON GRASS RUNWAY REPAIR. ALL OTHER	AIRPORT NOTE:
RUNWAY REPAIR. ALL OTHER	AIRPORT NOTE: CONTRACTOR TO COORDINATE ALL WORK ON AIRPORT PROPERTY WITH AIRPORT OWNER. PIPE INSTALLATION AND BACKFILL SHALL BE COMPLETED AS QUICKLY AS POSSIBLE TO MINIMIZE AIRPORT CLOSURE TIME.
COMPACTED TO AT LEAST 95% OF A STANDARD PROCTOR ON AIRPORT PROPERTY	CONTRACTOR TO PROTECT RUNWAY LIGHTS ON EITHER SIDE
3.52.62 1 1 1 1 1 1 1 1 1 1	24" RCP @ 0.19%
herein, herein	
STN C	322.99 H D1A
209 LF OF—24" RCP @ 0.19%	
24" RCP @ 0.19%	
Phis documents of the state of	MATCHLINE - SEE SHEET C6.4

Indiana Utilities Protection Service

STORM STRUCTURE TABLE

NEENAH R-1772

INV IN: 815.83 (S) INV OUT: 815.73 (N)

NEENAH R-1772

INV IN: 816.20 (S)

INV OUT: 816.20 (N) EX. STORM MANHOLE


INV IN: 815.00 (S)

STRUCTURE NAME:

D1A

EX1



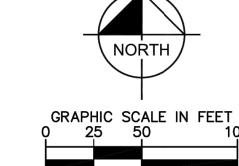


UTILITY NOTES

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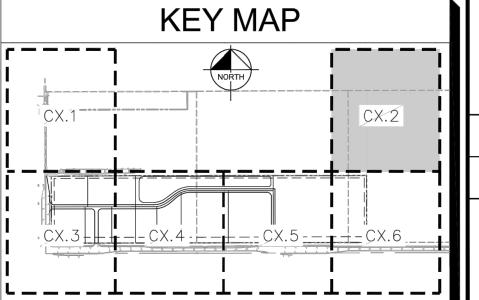
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AS-BUILT




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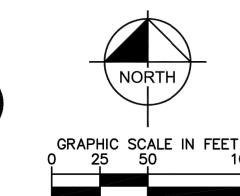
ORIGINAL ISSUE: 04/29/2019 KHA PROJECT NO. 170072000

SHEET NUMBER

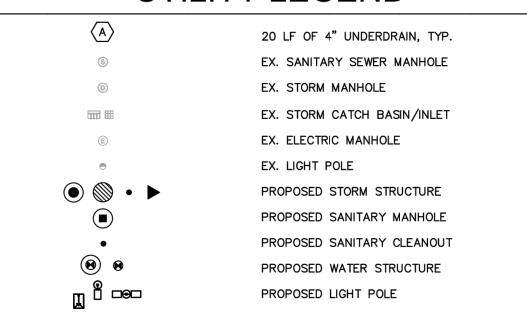

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Indiana Utilities Protection Service

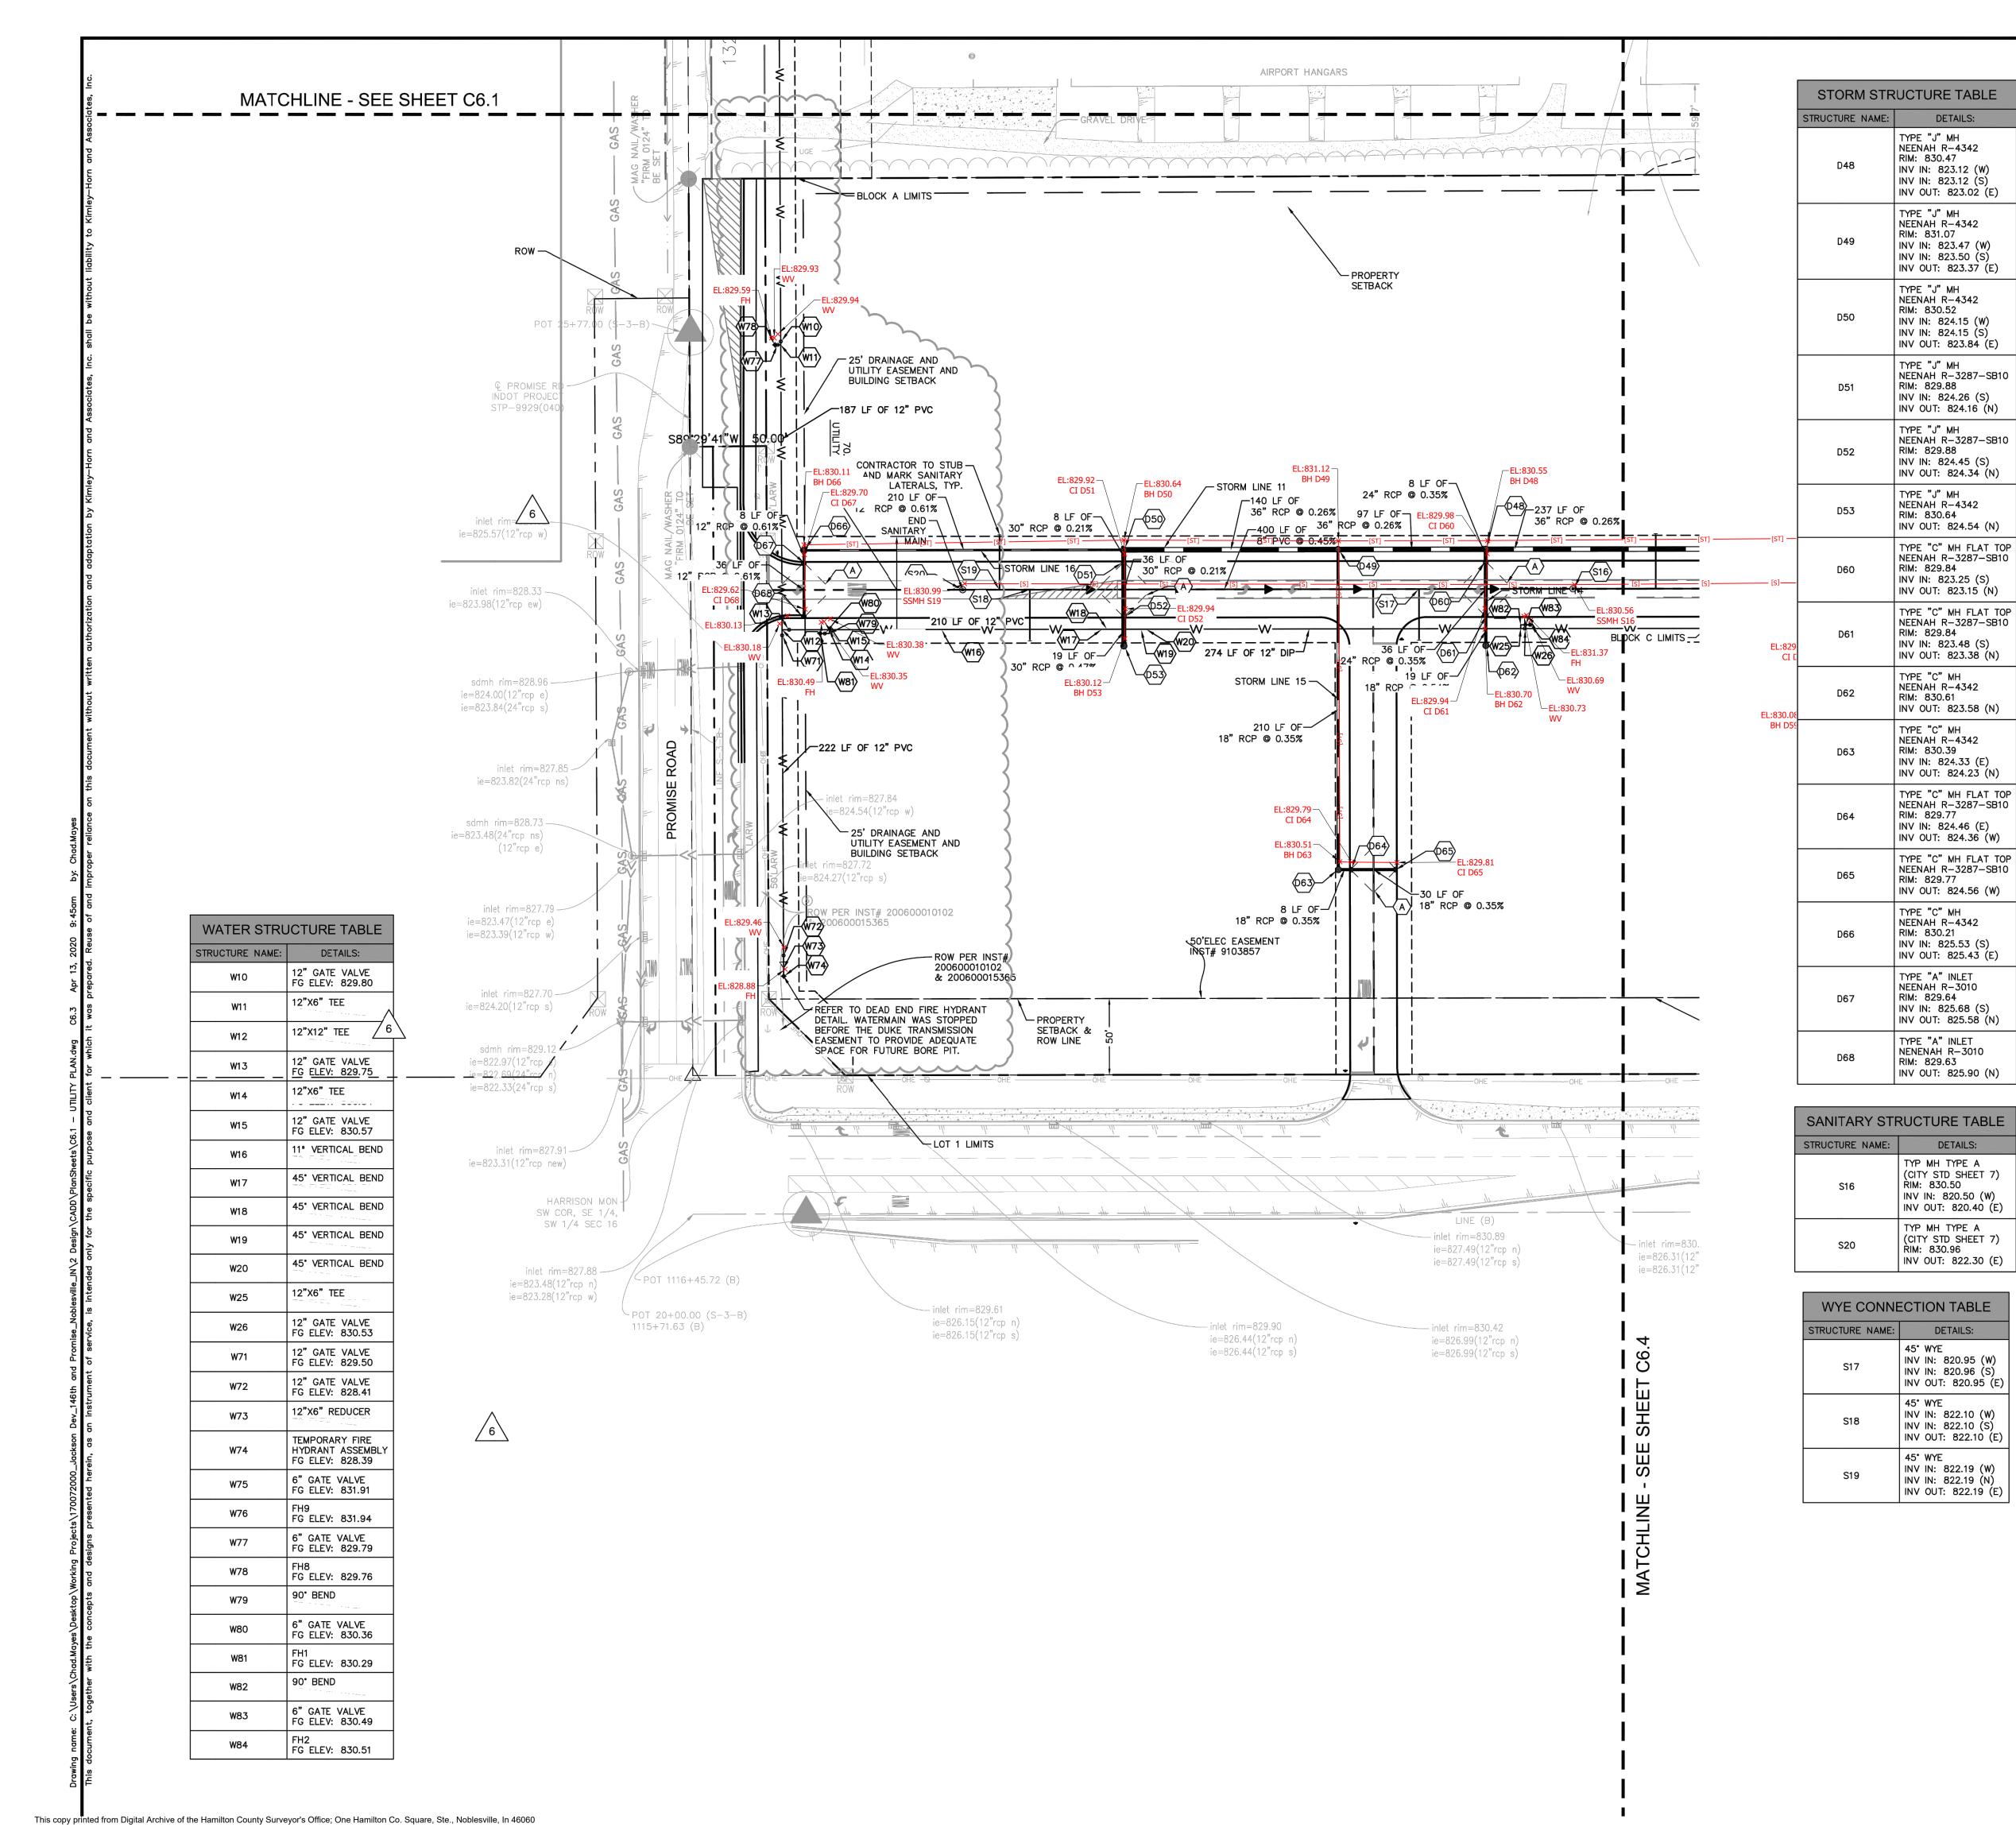

UTILITY NOTES

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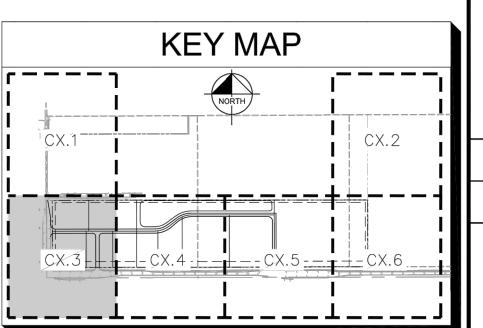
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UTILITY I FGEND

OTILI	I I LLOLIND
A	20 LF OF 4" UNDERDRAIN, TYP.
3	EX. SANITARY SEWER MANHOLE
(D)	EX. STORM MANHOLE
፡ ⊞	EX. STORM CATCH BASIN/INLET
Ē	EX. ELECTRIC MANHOLE
•	EX. LIGHT POLE
	PROPOSED STORM STRUCTURE
	PROPOSED SANITARY MANHOLE
•	PROPOSED SANITARY CLEANOUT
❷ ❷	PROPOSED WATER STRUCTURE
m®⊐⊖□	PROPOSED LIGHT POLE

NOTE: CONTRACTOR TO CAP AND MARK END OF STUB FOR ALL SANITARY LATERALS. SANITARY LATERALS TO BE 6" PVC WITH 1% MINIMUM SLOPE.

AS-BUILT



FIRE HYDRANT COORDINATION
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EASEMENT COORDINATION
INAW REVISIONS
INAW REVISIONS
SANITARY/WATER REVISIONS
CITY COMMENTS
REVISIONS

OFT & W. W. CATES, INC. & SANIT

Kimley >>> Horr © 2019 KIMLEY-HORN AND ASSOCIATES, I 250 EAST 96TH STREET, SUITE 580, INDIANAPOLIS, IN 46240 PHONE: 317-218-9560 WWW.KIMLEY-HORN.COM

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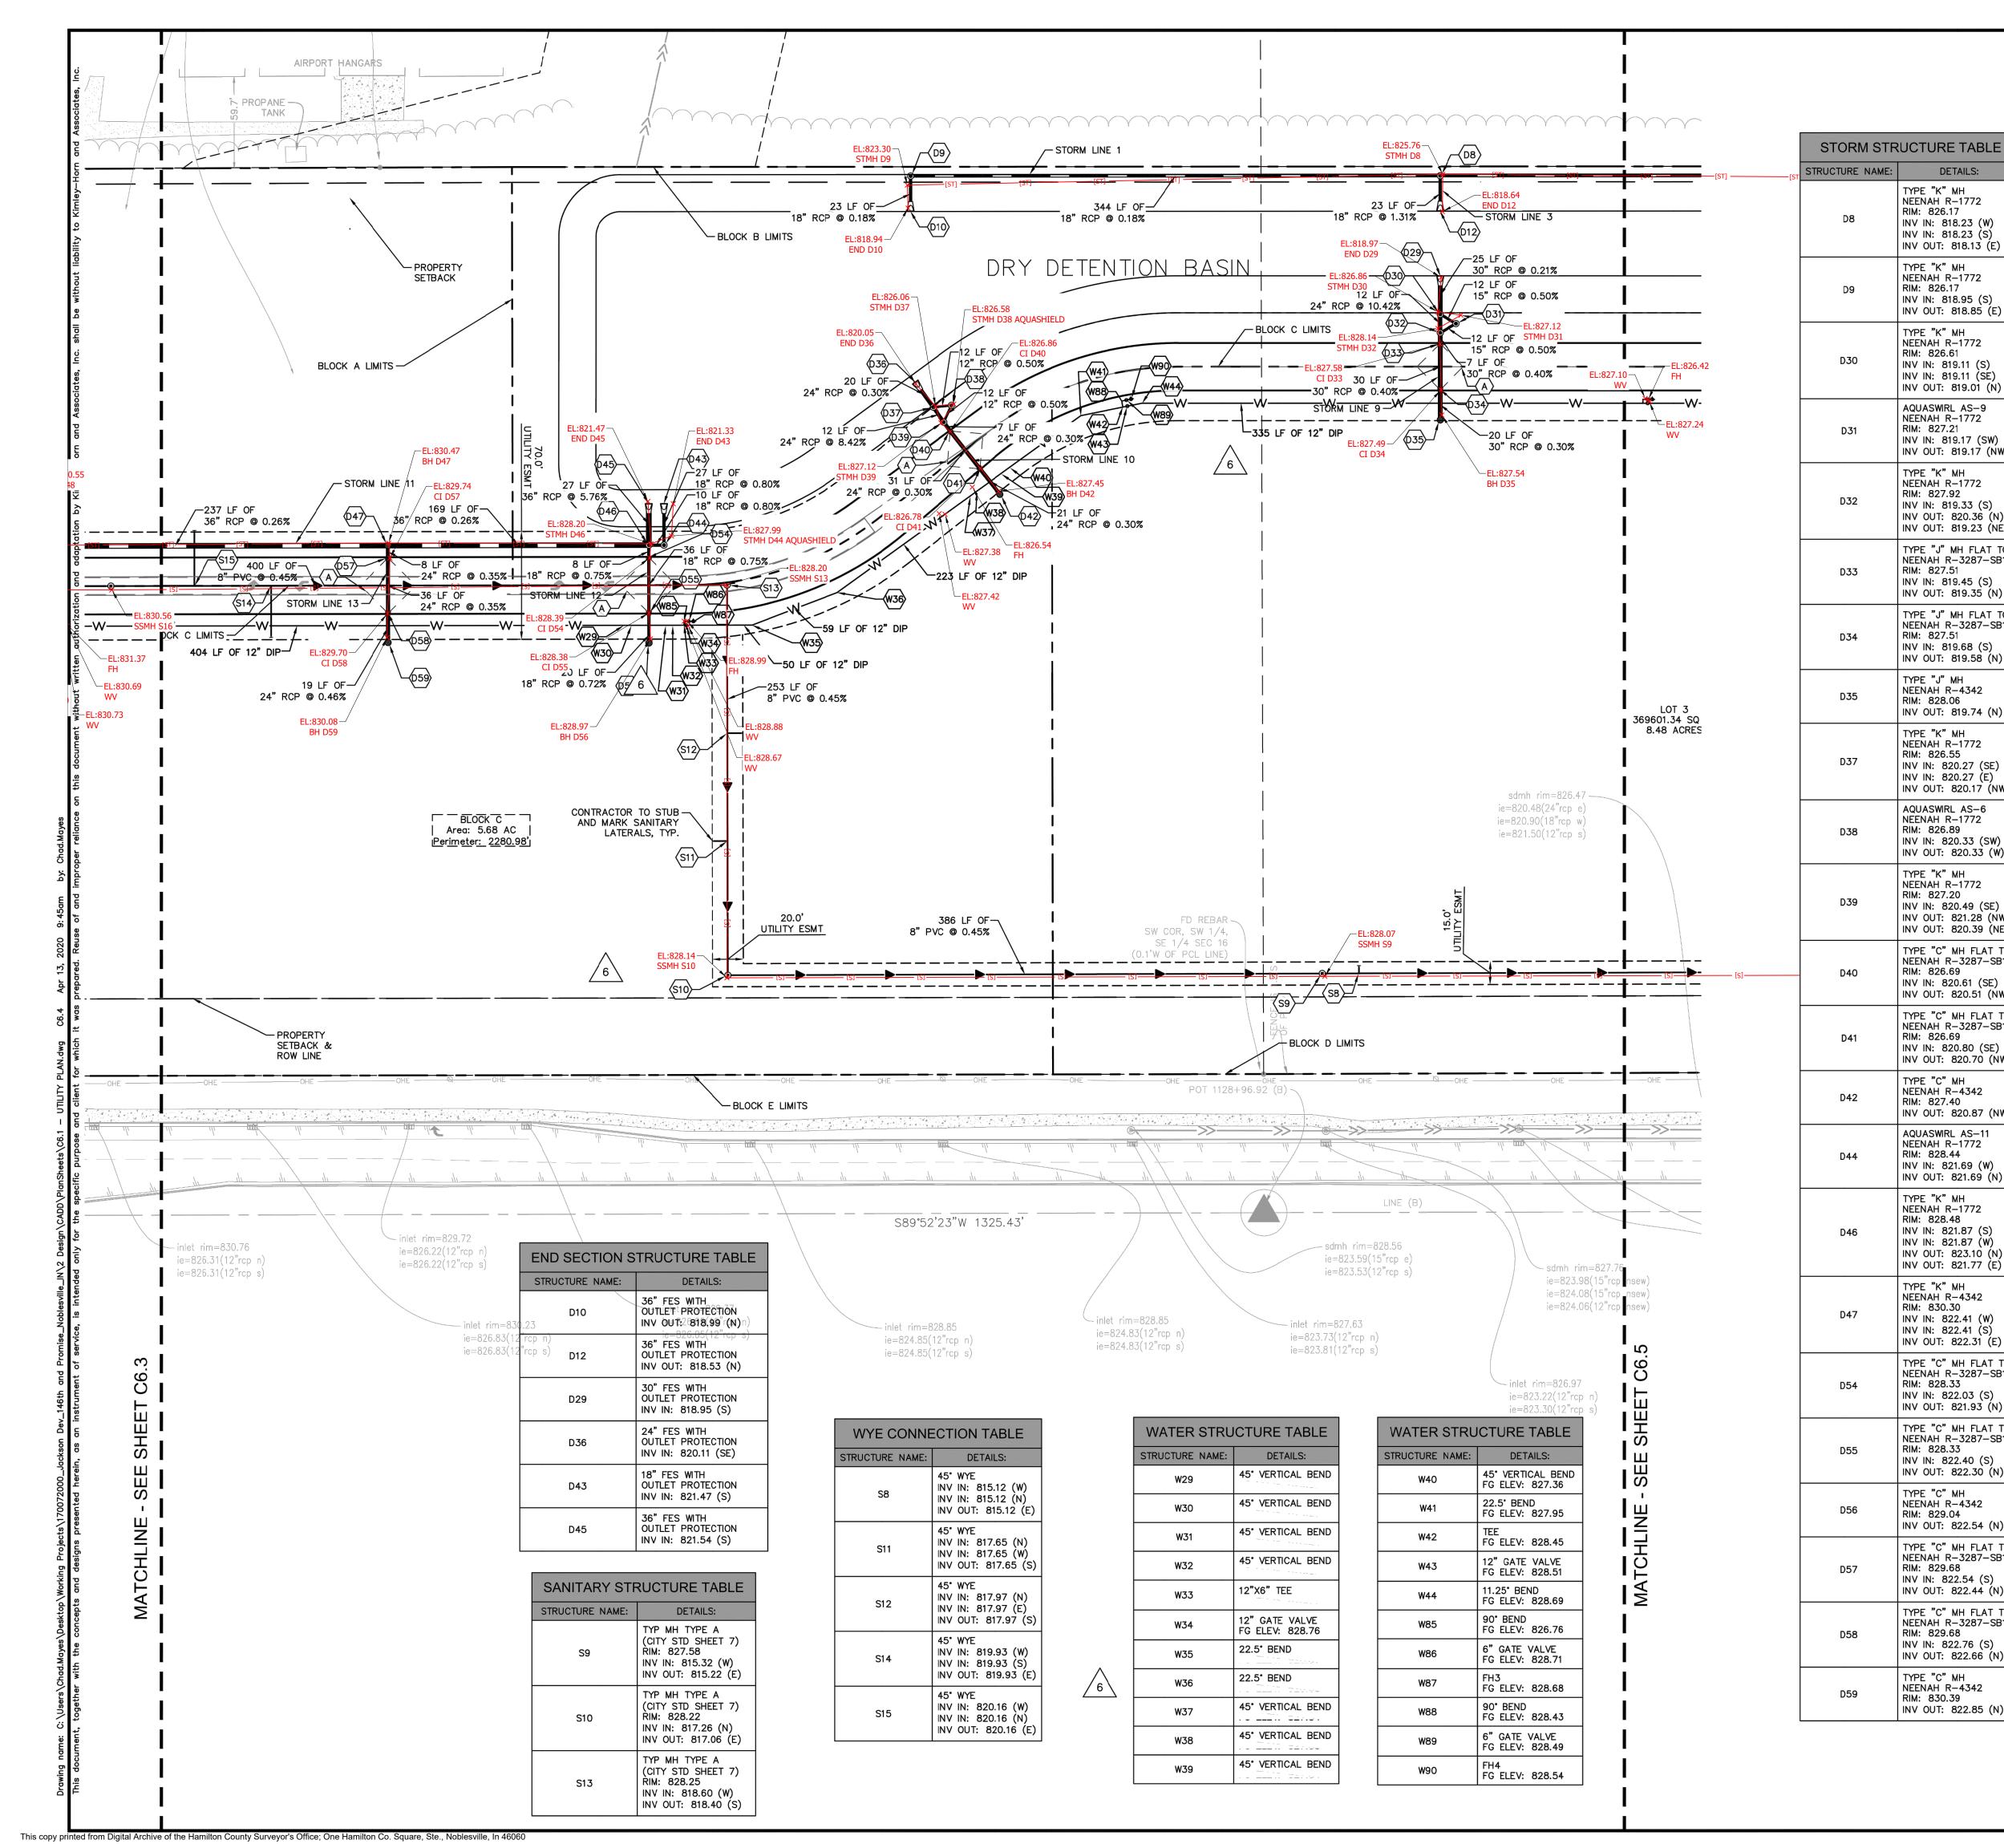
ACKSON DEVELOPMENT

ITILITY PLAN (3 OF 6)

SAMPUS CENTER
146TH STREET &
PROMISE ROAD
NOBLESVILLE, IN

ORIGINAL ISSUE: 04/29/2019 KHA PROJECT NO. 170072000

SHEET NUMBER





DETAILS:

TYPE "K" MH NEENAH R-1772

RIM: 826.17

INV IN: 818.23 (W) INV IN: 818.23 (S)

NEENAH R-1772

INV IN: 818.95 (S)

INV OUT: 818.85 (E)

RIM: 826.17

TYPE "K" MH

RIM: 826.61

NEENAH R-1772

| INV IN: 819.11 (S)

AQUASWIRL AS-9

NEENAH R-1772

INV IN: 819.17 (SW)

| INV OUT: 819.17 (NW)

RIM: 827.21

TYPE "K" MH

RIM: 827.92

RIM: 827.51

RIM: 827.51

TYPE "J" MH

RIM: 828.06

TYPE "K" MH NEENAH R-1772 RIM: 826.55

NEENAH R-4342

NEENAH R-1772

INV IN: 819.33 (S)

INV OUT: 820.36 (N)

| INV OUT: 819.23 (NE)

TYPE "J" MH FLAT TOP

NEENAH R-3287-SB10

TYPE "J" MH FLAT TOP

NEENAH R-3287-SB10

INV IN: 819.45 (S)

INV IN: 819.68 (S)

INV OUT: 819.58 (N)

INV OUT: 819.74 (N)

INV IN: 820.27 (SE)

INV IN: 820.27 (E)

AQUASWIRL AS-6

INV IN: 820.33 (SW)

| INV OUT: 820.33 (W)

INV IN: 820.49 (SE)

INV OUT: 821.28 (NW)

INV OUT: 820.39 (NE)

TYPE "C" MH FLAT TOP

NFFNAH R-3287-SB10

TYPE "C" MH FLAT TOP NEENAH R-3287-SB10

INV IN: 820.61 (SE) INV OUT: 820.51 (NW)

INV IN: 820.80 (SE)

NEENAH R-4342

AQUASWIRL AS-11

INV IN: 821.69 (W) INV OUT: 821.69 (N)

TYPE "K" MH

NEENAH R-1772 RIM: 828.48

| INV IN: 821.87 (S)

INV IN: 821.87 (W)

NEENAH R-4342

INV IN: 822.41 (W)

INV IN: 822.41 (S)

INV IN: 822.03 (S)

INV IN: 822.40 (S)

NEENAH R-4342

RIM: 829.04

RIM: 829.68

RIM: 829.68

TYPE "C" MH

RIM: 830.39

INV OUT: 822.30 (N)

INV OUT: 822.54 (N)

TYPE "C" MH FLAT TOP

NEENAH R-3287-SB10

INV IN: 822.54 (S)

INV OUT: 822.44 (N)

TYPE "C" MH FLAT TOP

NEENAH R-3287-SB10

| INV IN: 822.76 (S)

NEENAH R-4342

INV OUT: 822.66 (N)

INV OUT: 822.85 (N)

INV OUT: 821.93 (N)

TYPE "C" MH FLAT TOP

NEENAH R-3287-SB10

INV OUT: 822.31 (E)

TYPE "C" MH FLAT TOP

NEENAH R-3287-SB10

RIM: 830.30

RIM: 828.33

RIM: 828.33

INV OUT: 823.10 (N)

INV OUT: 821.77 (E)

NEENAH R-1772 RIM: 828.44

RIM: 827.40

INV OUT: 820.70 (NW)

INV OUT: 820.87 (NW)

NEENAH R-1772

RIM: 826.89

TYPE "K" MH

RIM: 826.69

RIM: 826.69

NEENAH R-1772 RIM: 827.20

| INV OUT: 820.17 (NW)


INV OUT: 819.35 (N)

INV IN: 819.11 (SE)

INV OUT: 819.01 (N)

INV OUT: 818.13 (E)

Indiana Utilities Protection Service

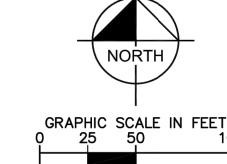

GENERAL UTILITY NOTES

ALL WATER LINES SHALL BE PVC C900 DR-14 OR DUCTILE IRON CL 52


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- 15. STORMWATER FACILITIES MUST BE FUNCTIONAL BEFORE BUILDING CONSTRUCTION

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> NOTE: CONTRACTOR TO CAP AND MARK END OF STUB FOR ALL SANITARY LATERALS. SANITARY LATERALS TO BE 6" PVC WITH 1% MINIMUM SLOPE.

AS-BUILT



NATION	4/13/2020	MJT
NO	2/13/2020	MJT
ATION	2/3/2020	MJT
	10/31/19	CSM
	61/80/01	CSM
ISIONS	09/12/19	CVS
	08/12/19	NJB
	DATE	ВҮ
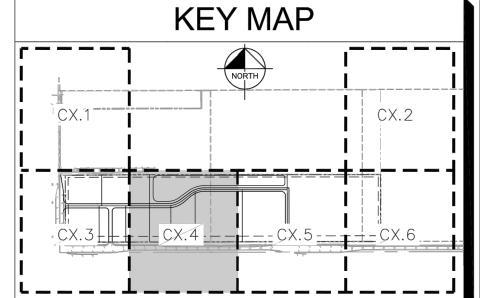
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UTILITY NOTES


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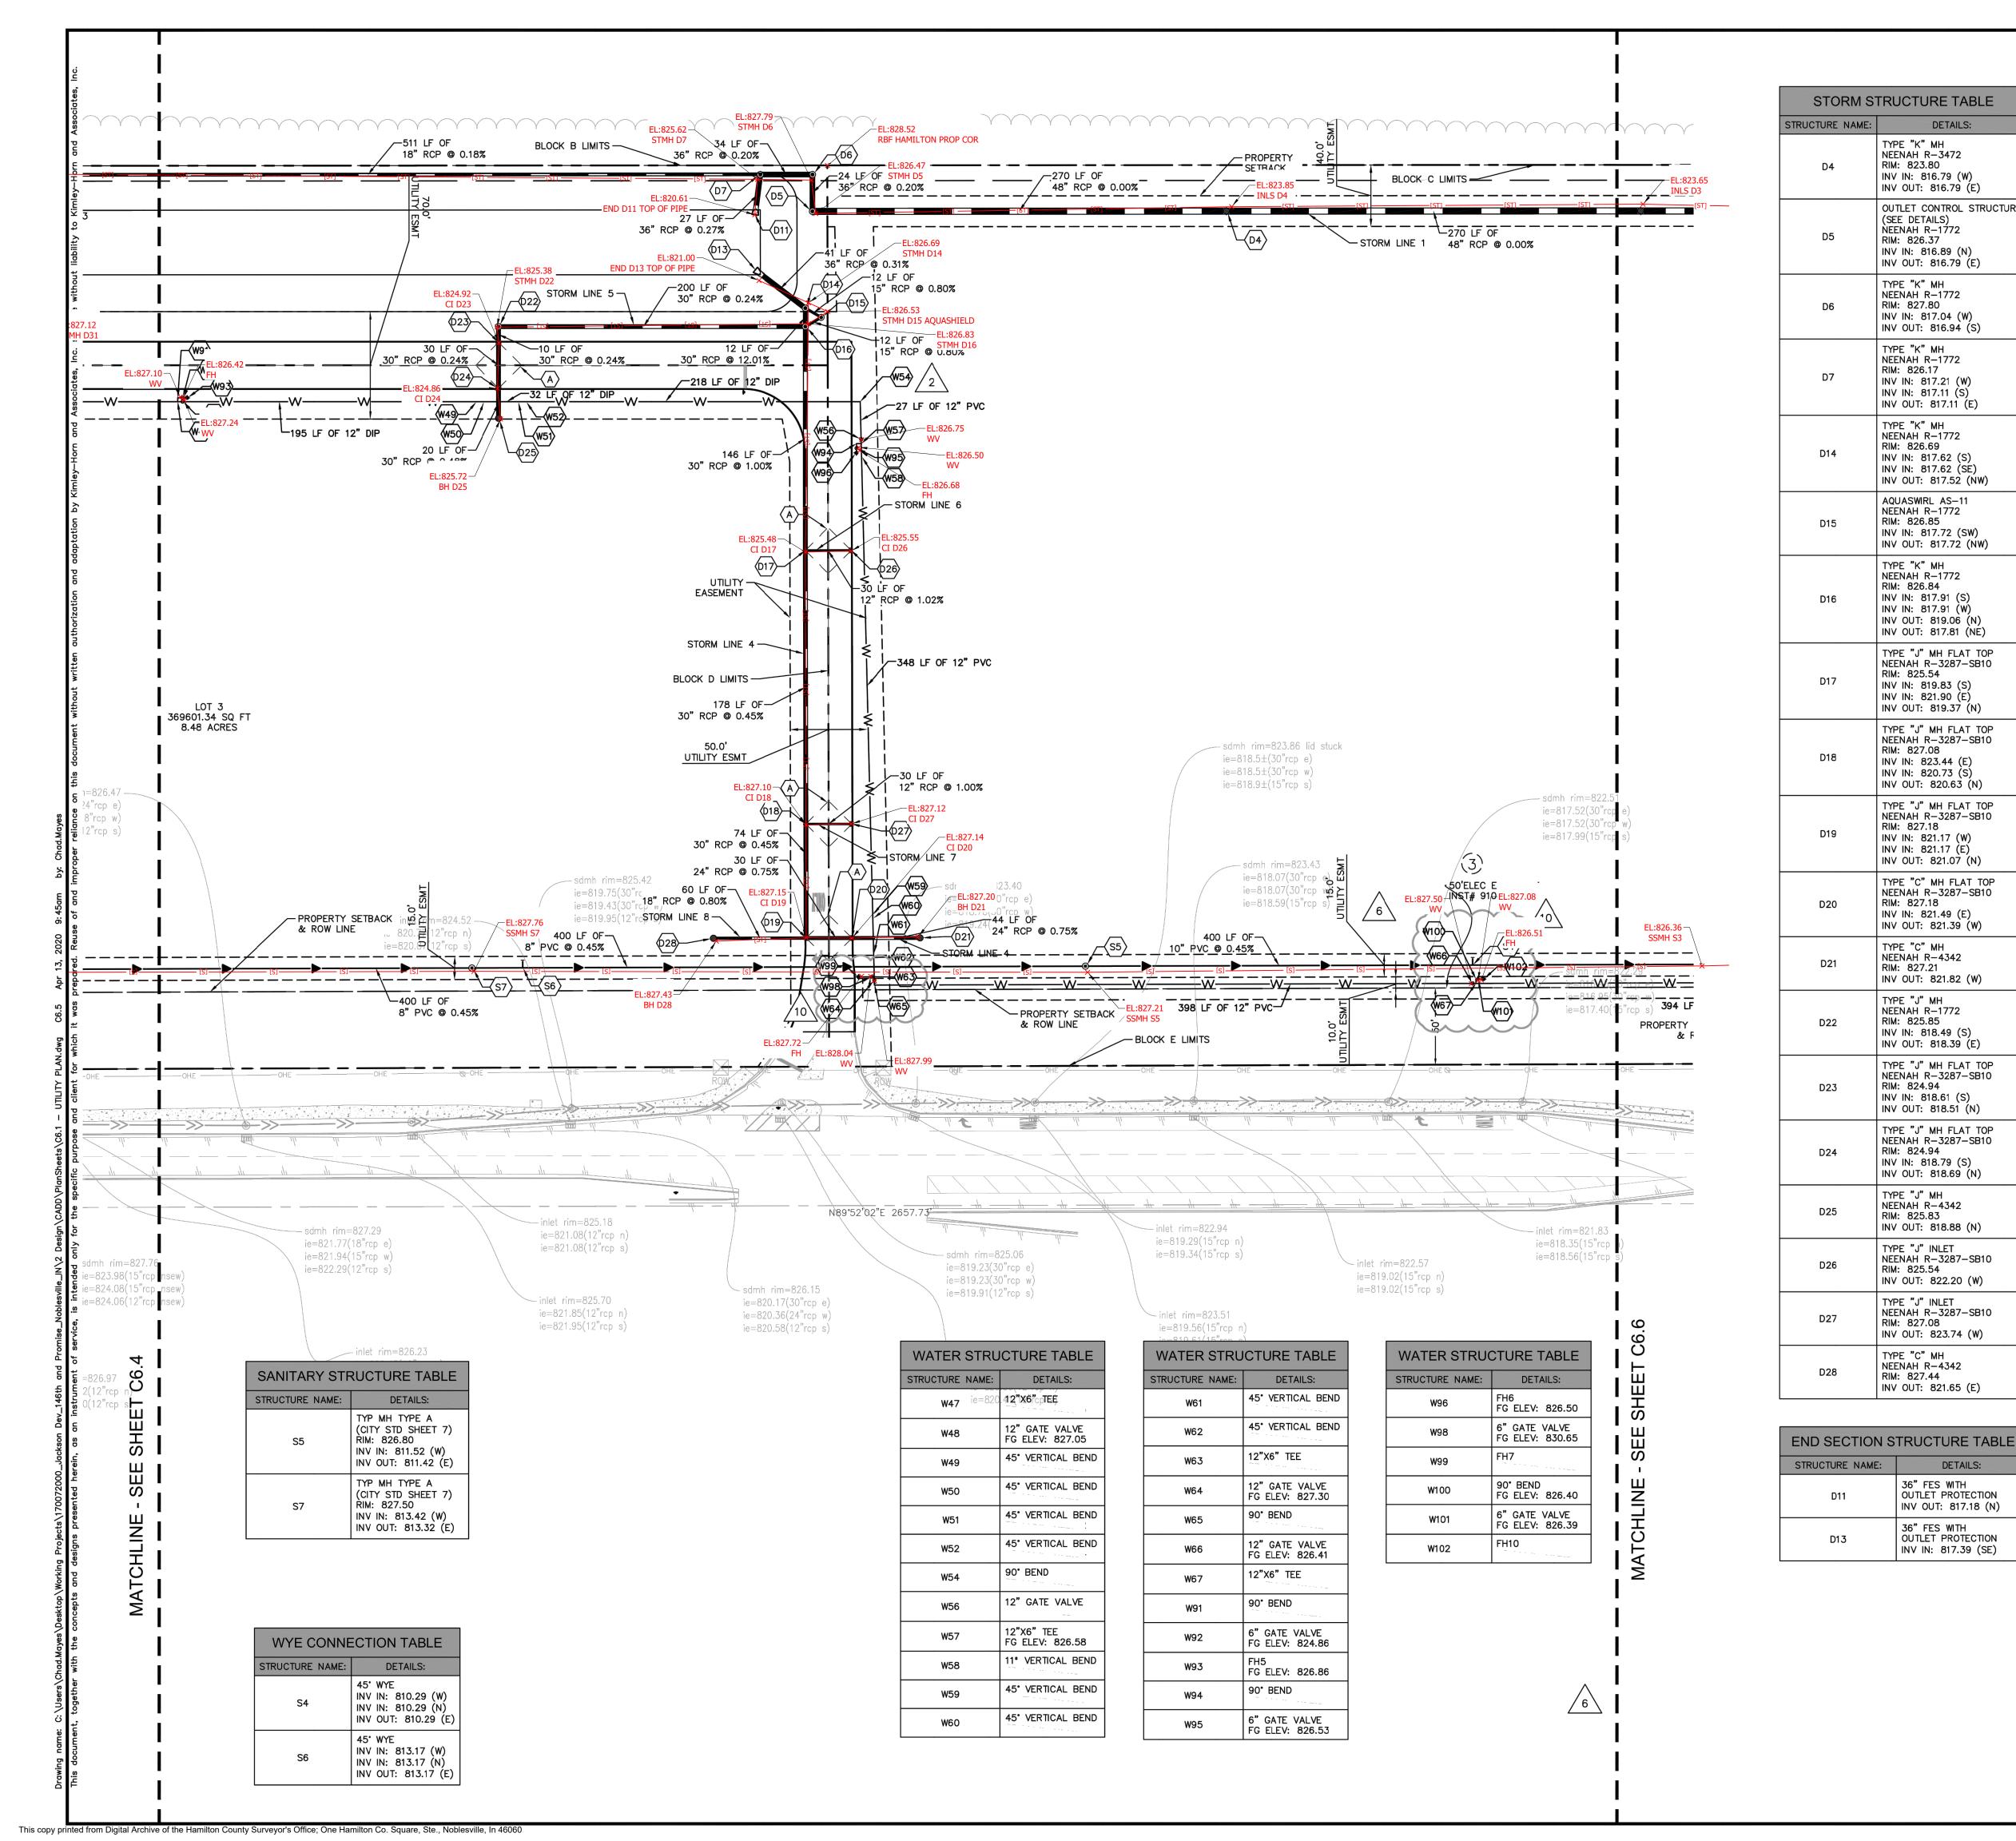
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UTILITY LEGEND

PROPOSED LIGHT POLE



ORIGINAL ISSUE: 04/29/2019 KHA PROJECT NO. 170072000 SHEET NUMBER

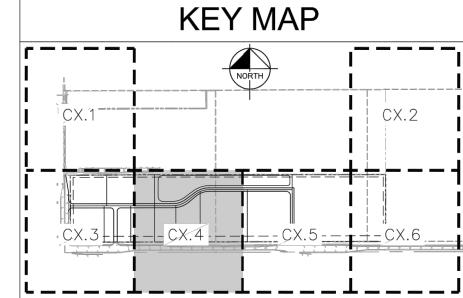

Indiana Utilities Protection Service before you dig **GENERAL UTILITY NOTES**

DETAILS:

OUTLET CONTROL STRUCTURE

TYPE "K" MH

RIM: 823.80 INV IN: 816.79 (W)

(SEE DETAILS)

RIM: 826.37

TYPE "K" MH

RIM: 827.80 INV IN: 817.04 (W)

NEENAH R-1772

NEENAH R-1772

INV IN: 817.21 (W)

INV OUT: 817.11 (E)

INV IN: 817.11 (S)

RIM: 826.17

TYPE "K" MH

NEENAH R-1772 RIM: 826.69

INV IN: 817.62 (S)

| INV IN: 817.62 (SE) INV OUT: 817.52 (NW)

AQUASWIRL AS-11

INV IN: 817.72 (SW)

INV OUT: 817.72 (NW)

NEENAH R-1772

RIM: 826.85

TYPE "K" MH

RIM: 826.84

RIM: 825.54

RIM: 827.08

RIM: 827.18

RIM: 827.18

NEENAH R-1772

INV IN: 817.91 (S)

INV IN: 817.91 (W)

INV OUT: 819.06 (N)

INV OUT: 817.81 (NE)

TYPE "J" MH FLAT TOP

NEENAH R-3287-SB10

INV IN: 819.83 (S)

INV IN: 821.90 (E)

INV OUT: 819.37 (N)

INV IN: 823.44 (E)

INV IN: 820.73 (S)

INV IN: 821.17 (W)

INV IN: 821.17 (E)

INV OUT: 821.07 (N)

INV IN: 821.49 (E)

NEENAH R-4342 RIM: 827.21

TYPE "J" MH NEENAH R-1772

RIM: 825.85

RIM: 824.94

RIM: 824.94

TYPE "J" MH

NEENAH R-4342 RIM: 825.83

TYPE "J" INLET

TYPE "J" INLET

NEENAH R-4342

RIM: 827.44

RIM: 827.08

RIM: 825.54

INV OUT: 818.88 (N)

NEENAH R-3287-SB10

NEENAH R-3287-SB10

INV OUT: 823.74 (W)

INV OUT: 821.65 (E)

DETAILS:

36" FES WITH OUTLET PROTECTION

INV OUT: 817.18 (N)

OUTLET PROTECTION

INV IN: 817.39 (SE)

36" FES WITH

INV OUT: 822.20 (W)

INV OUT: 821.39 (W)

INV OUT: 821.82 (W)

INV IN: 818.49 (S)

INV IN: 818.61 (S) INV OUT: 818.51 (N)

INV IN: 818.79 (S) INV OUT: 818.69 (N)

INV OUT: 818.39 (E)

TYPE "J" MH FLAT TOP NEENAH R-3287-SB10

TYPE "J" MH FLAT TOP

NEENAH R-3287-SB10

TYPE "C" MH FLAT TOP

NEENAH R-3287-SB10

INV OUT: 820.63 (N)

TYPE "J" MH FLAT TOP

NEENAH R-3287-SB10

TYPE "J" MH FLAT TOP NEENAH R-3287-SB10


INV OUT: 816.94 (S)

NEENAH R-1772

INV IN: 816.89 (N) INV OUT: 816.79 (E)

NEENAH R-3472

INV OUT: 816.79 (E)

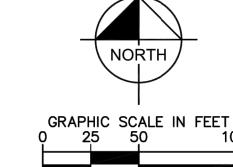

UTILITY NOTES

ALL WATER LINES SHALL BE PVC C900 DR-14 OR DUCTILE IRON CL 52

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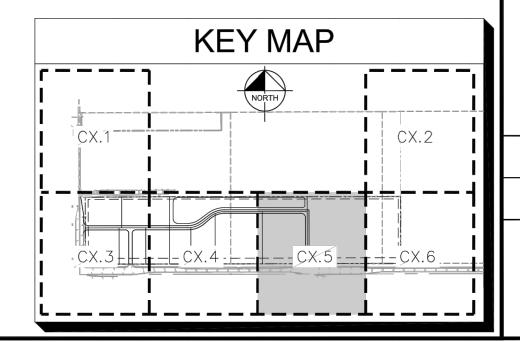
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AS-BUILT




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ORIGINAL ISSUE: 04/29/2019 KHA PROJECT NO. 170072000

SHEET NUMBER



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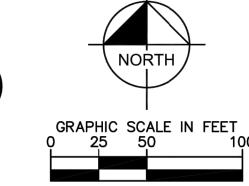
STORM STRUCTURE TABLE STRUCTURE NAME: DETAILS: OUTLET CONTROL STRUCTURE (SEE DETAILS) NEENAH R-1772 RIM: 824.11 INV IN: 816.79 (W) | INV OUT: 816.59 (N) TYPE "K" MH NEENAH R-3472 RIM: 823.80 INV IN: 816.79 (W) INV OUT: 816.79 (E)

SANITAR	Y STRUCTURE TABLE
STRUCTURE NAME:	DETAILS:
EX1	CONNECT TO EXISTING SSWR STUB RIM: 805.79 INV IN: 804.89 (W) INV OUT: 804.89 (E)
S1	TYP MH TYPE B (CITY STD SHEET 7) RIM: 825.92 INV IN: 806.06 (N) INV OUT: 805.09 (E)
S2	TYP MH TYPE A (CITY STD SHEET 7) RIM: 825.49 INV IN: 806.38 (W) INV OUT: 806.18 (S)
S3	TYP MH TYPE A (CITY STD SHEET 7) RIM: 826.13 INV IN: 809.62 (W) INV OUT: 807.44 (E)

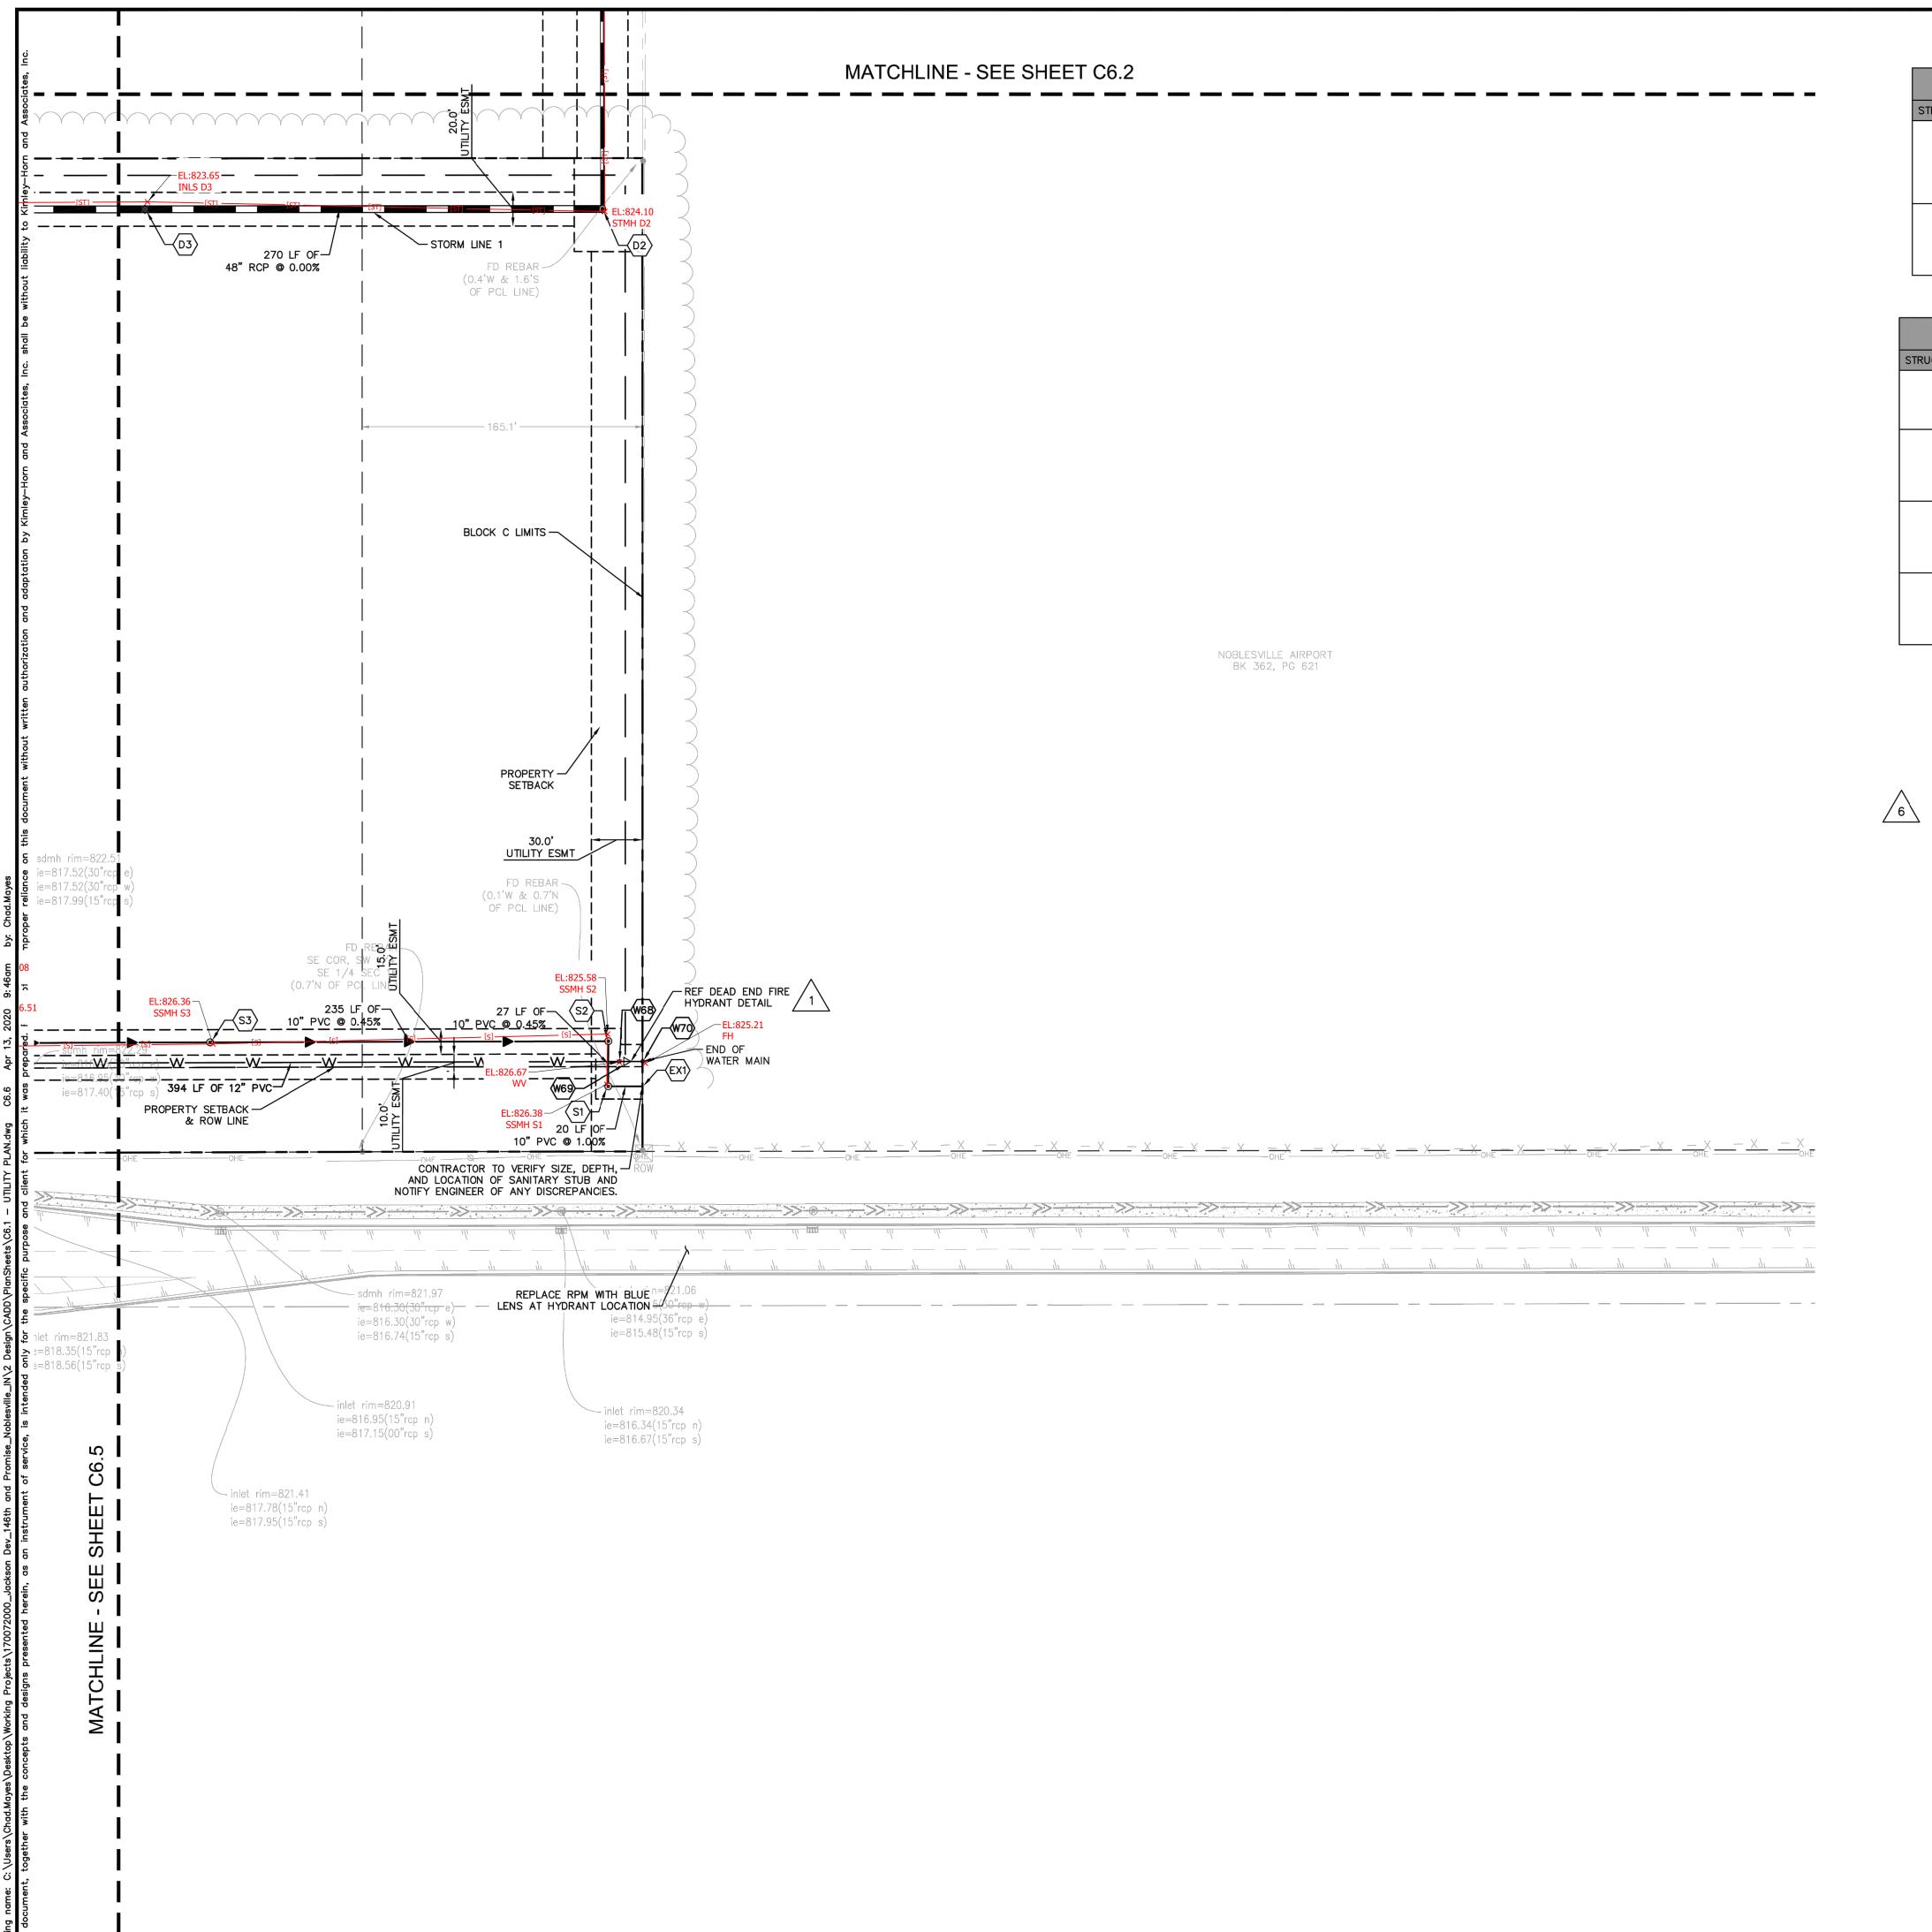	WATER STRU	JCTURE TABLE
	STRUCTURE NAME:	DETAILS:
	W68	12" GATE VALVE FG ELEV: 825.68
	W69	12X6 REDUCER
7	W70	TEMPORARY FIRE HYDRANT ASSEMBLY FG ELEV: 825.67

Indiana Utilities Protection Service





UTILITY NOTES

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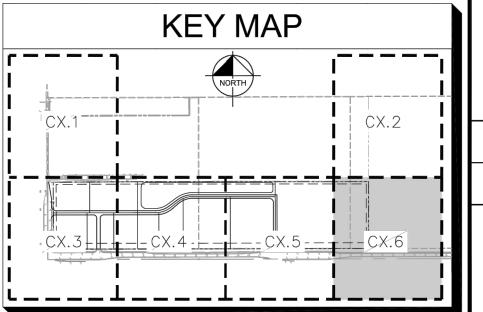
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AS-BUILT




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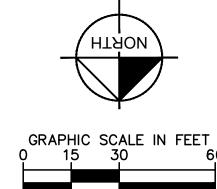
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ORIGINAL ISSUE: 04/29/2019 KHA PROJECT NO. 170072000

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/≫Horn

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AS-BUILT

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- 2. GRANULAR BACKFILL SHALL BE PER CITY OF NOBLESVILLE STANDARDS


GRANULAR BACKFILL
REQUIRED BENEATH AND WITHIN 5 FEET OF PAVEMENT

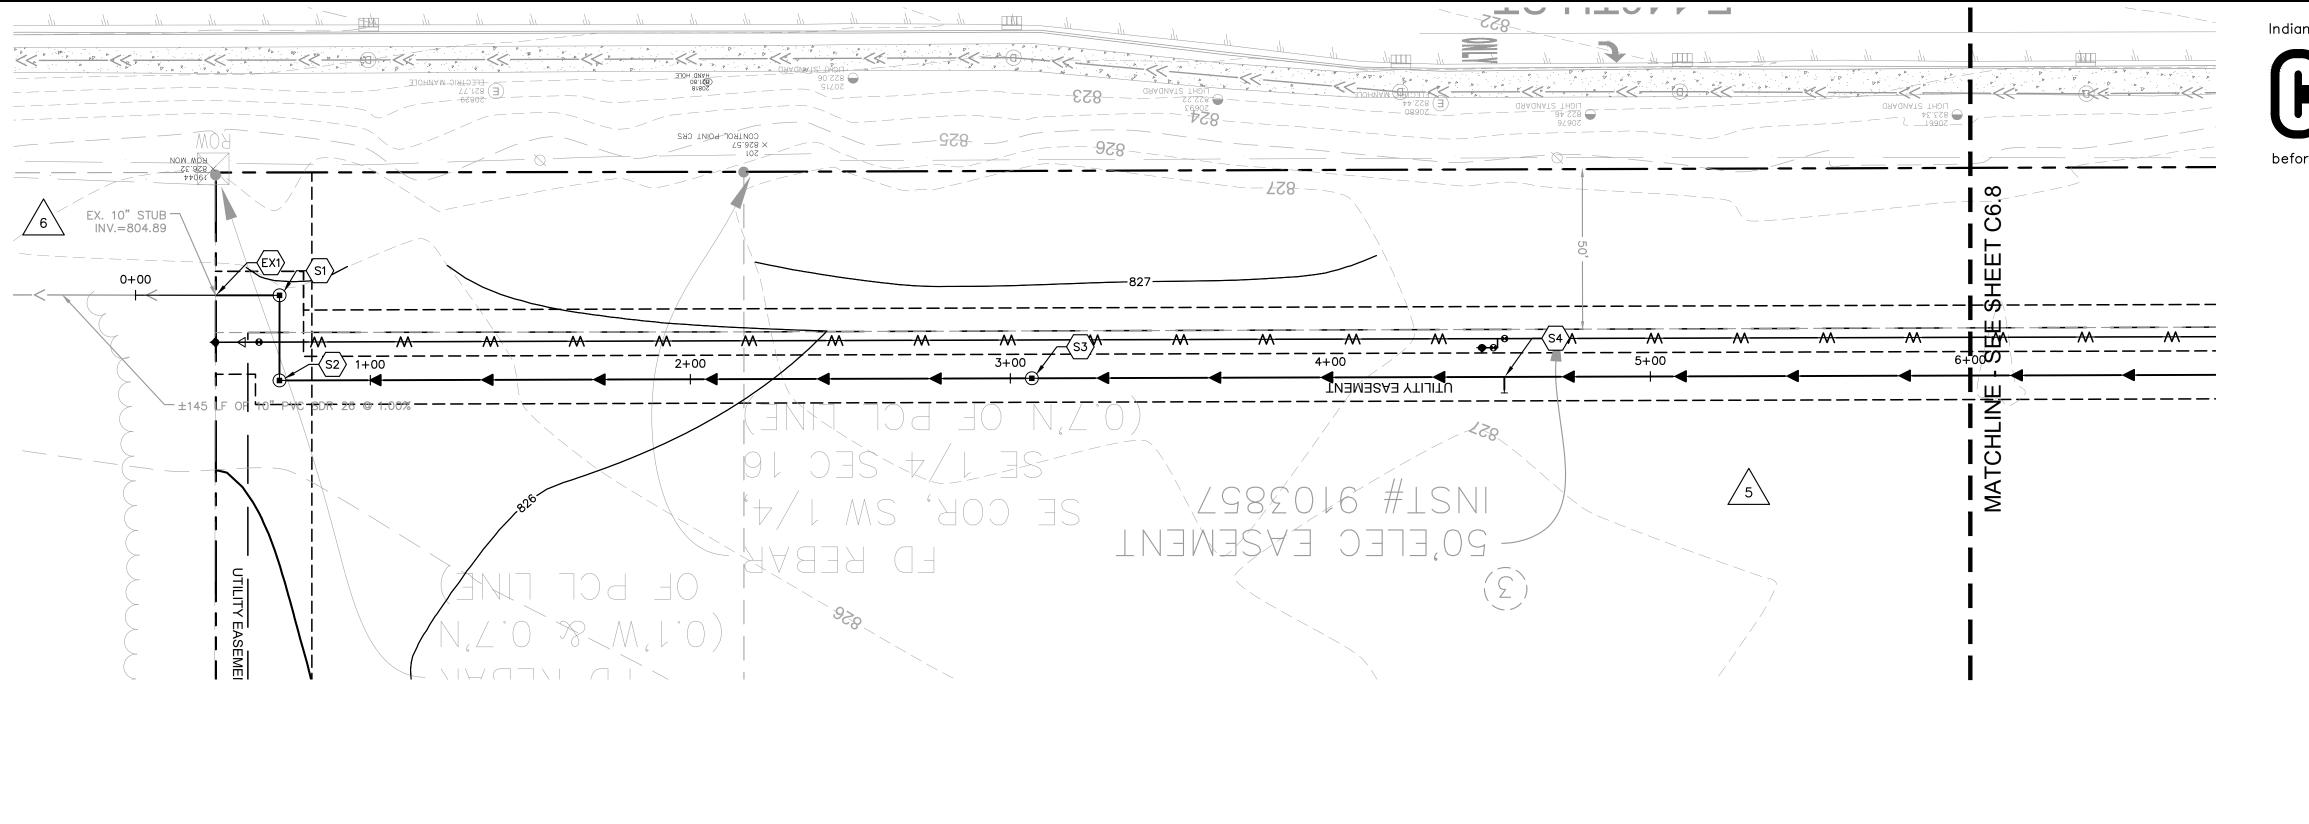ORIGINAL ISSUE: 04/29/2019 KHA PROJECT NO. 170072000 SHEET NUMBER


SAMPUS CENTER 146TH STREET & PROMISE ROAD NOBLESVILLE, IN

∞ 5

C6.7

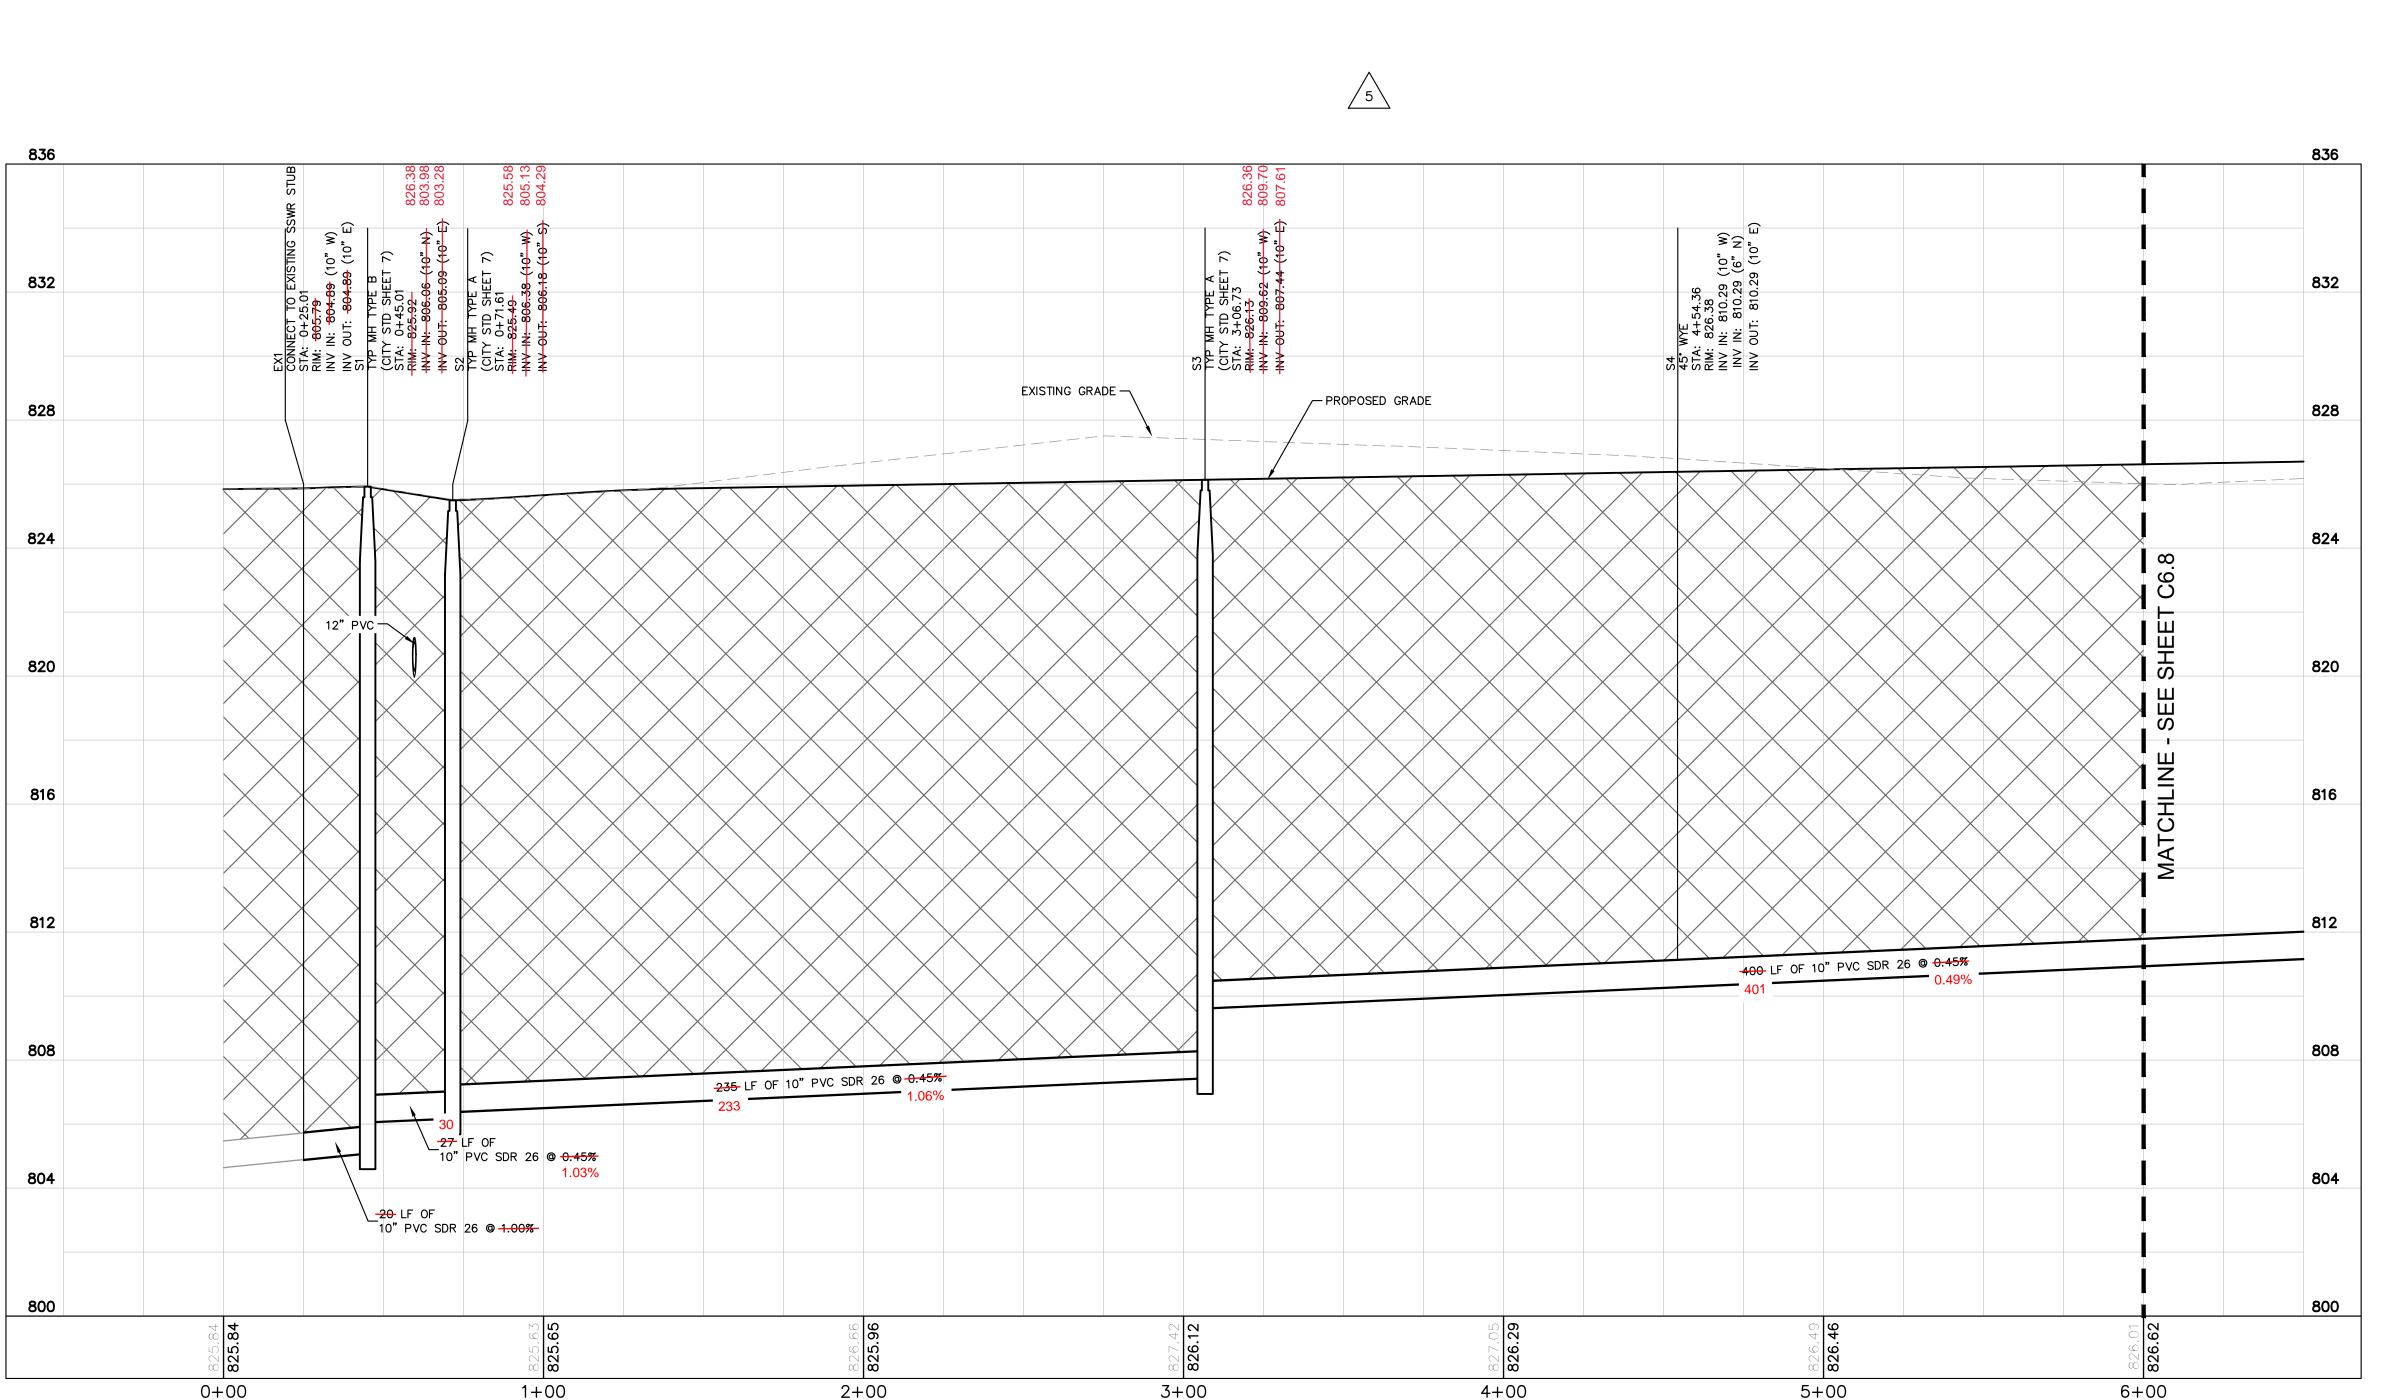

SANITARY - PROFILE 1 SCALE HORIZ. 1"=30' VERT. 1"=3"

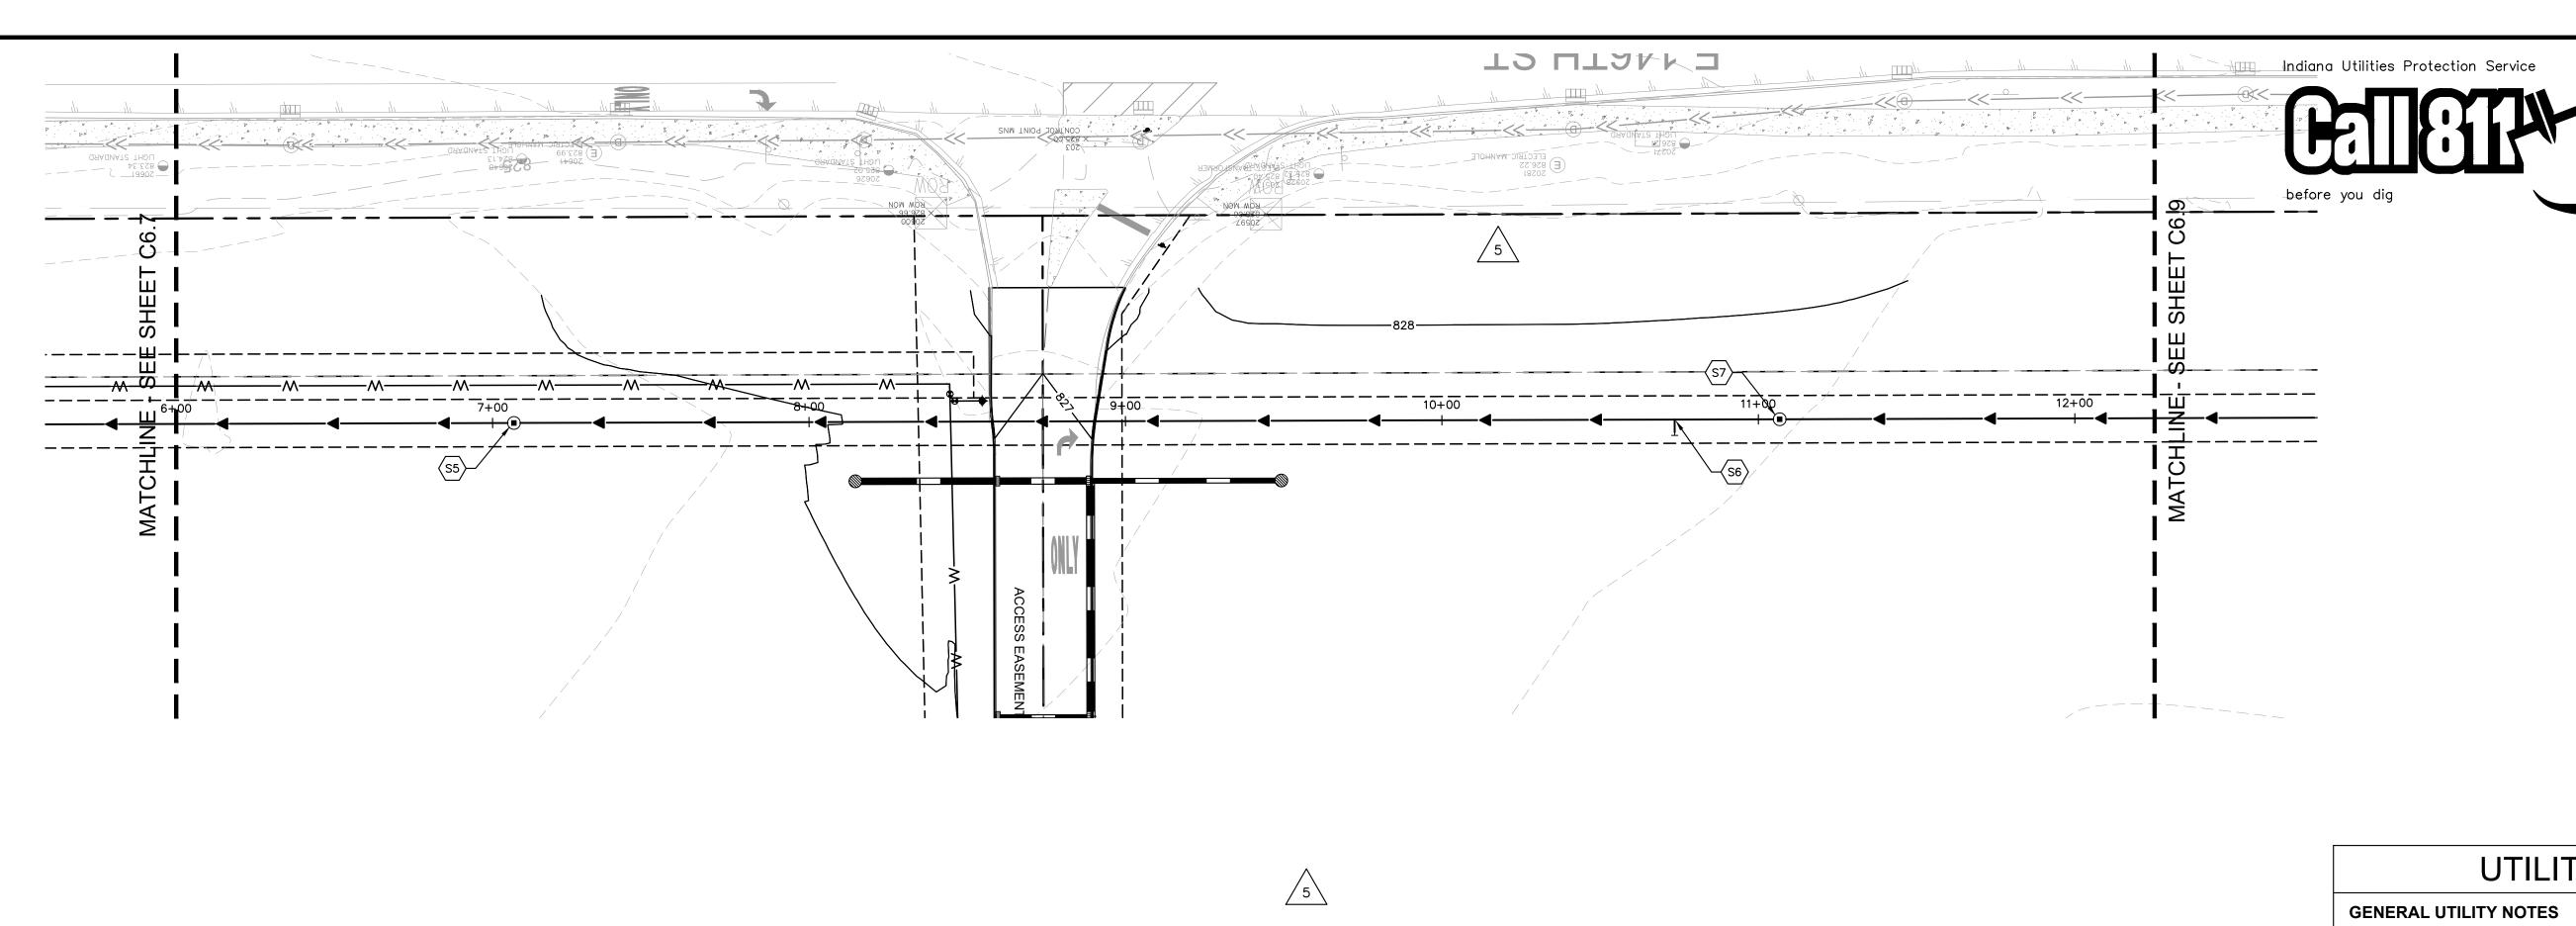

UTILITY NOTES

GRAPHIC SCALE IN FEET

/≫Horn

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AS-BUILT

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ORIGINAL ISSUE:
04/29/2019


KHA PROJECT NO.
170072000

SHEET NUMBER

CAMPUS CENTEF 146TH STREET & PROMISE ROAD NOBLESVILLE, IN


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C6.8

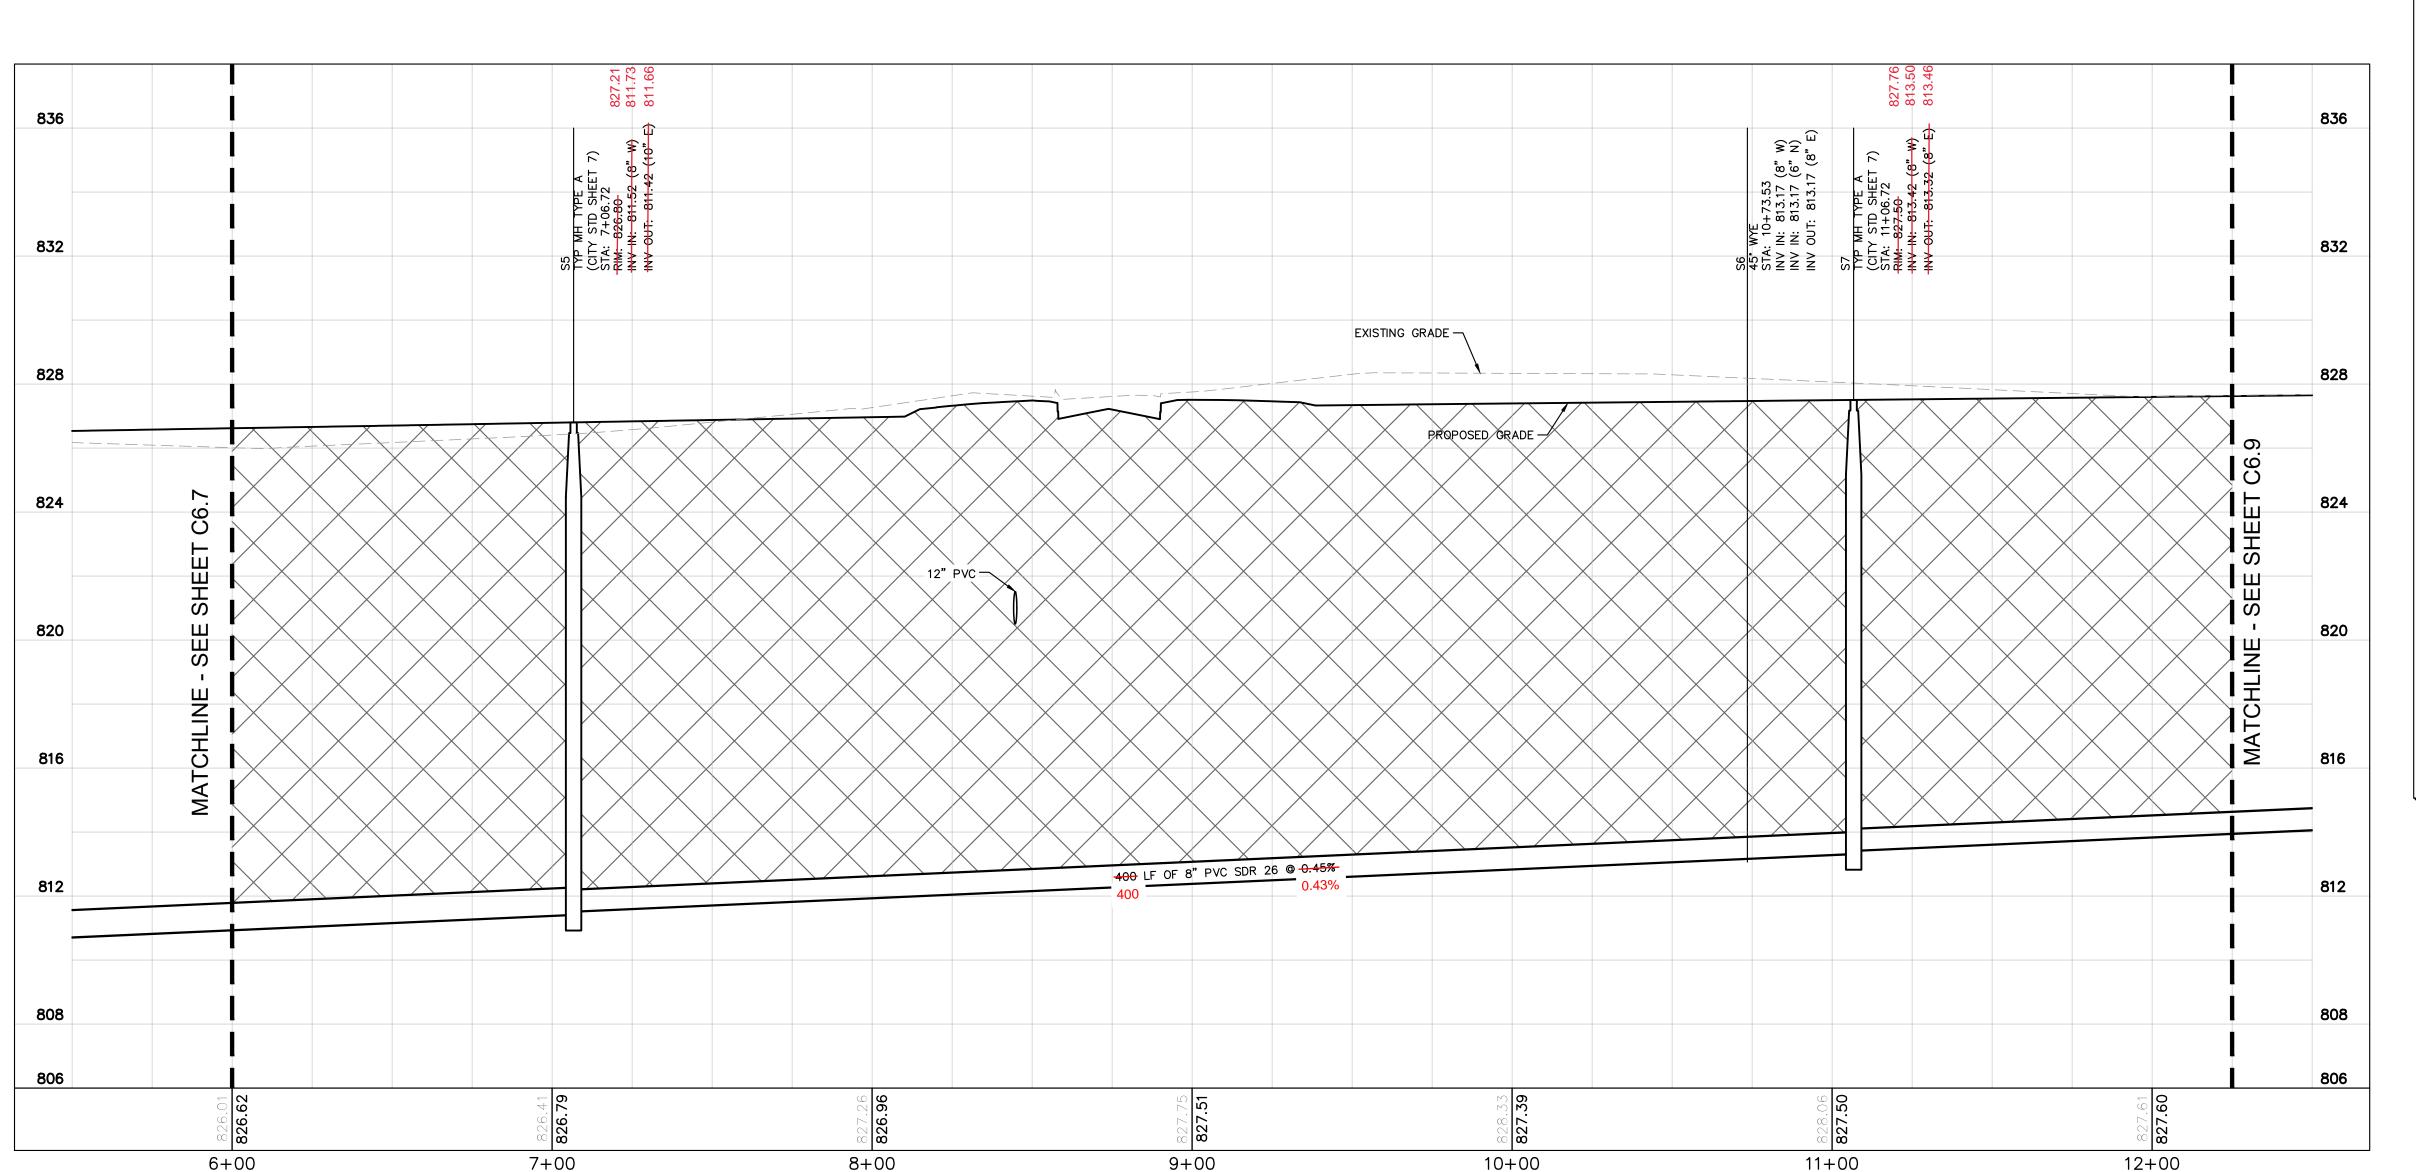

SANITARY - PROFILE 2

SCALE HORIZ. 1"=30" VERT. 1"=3"



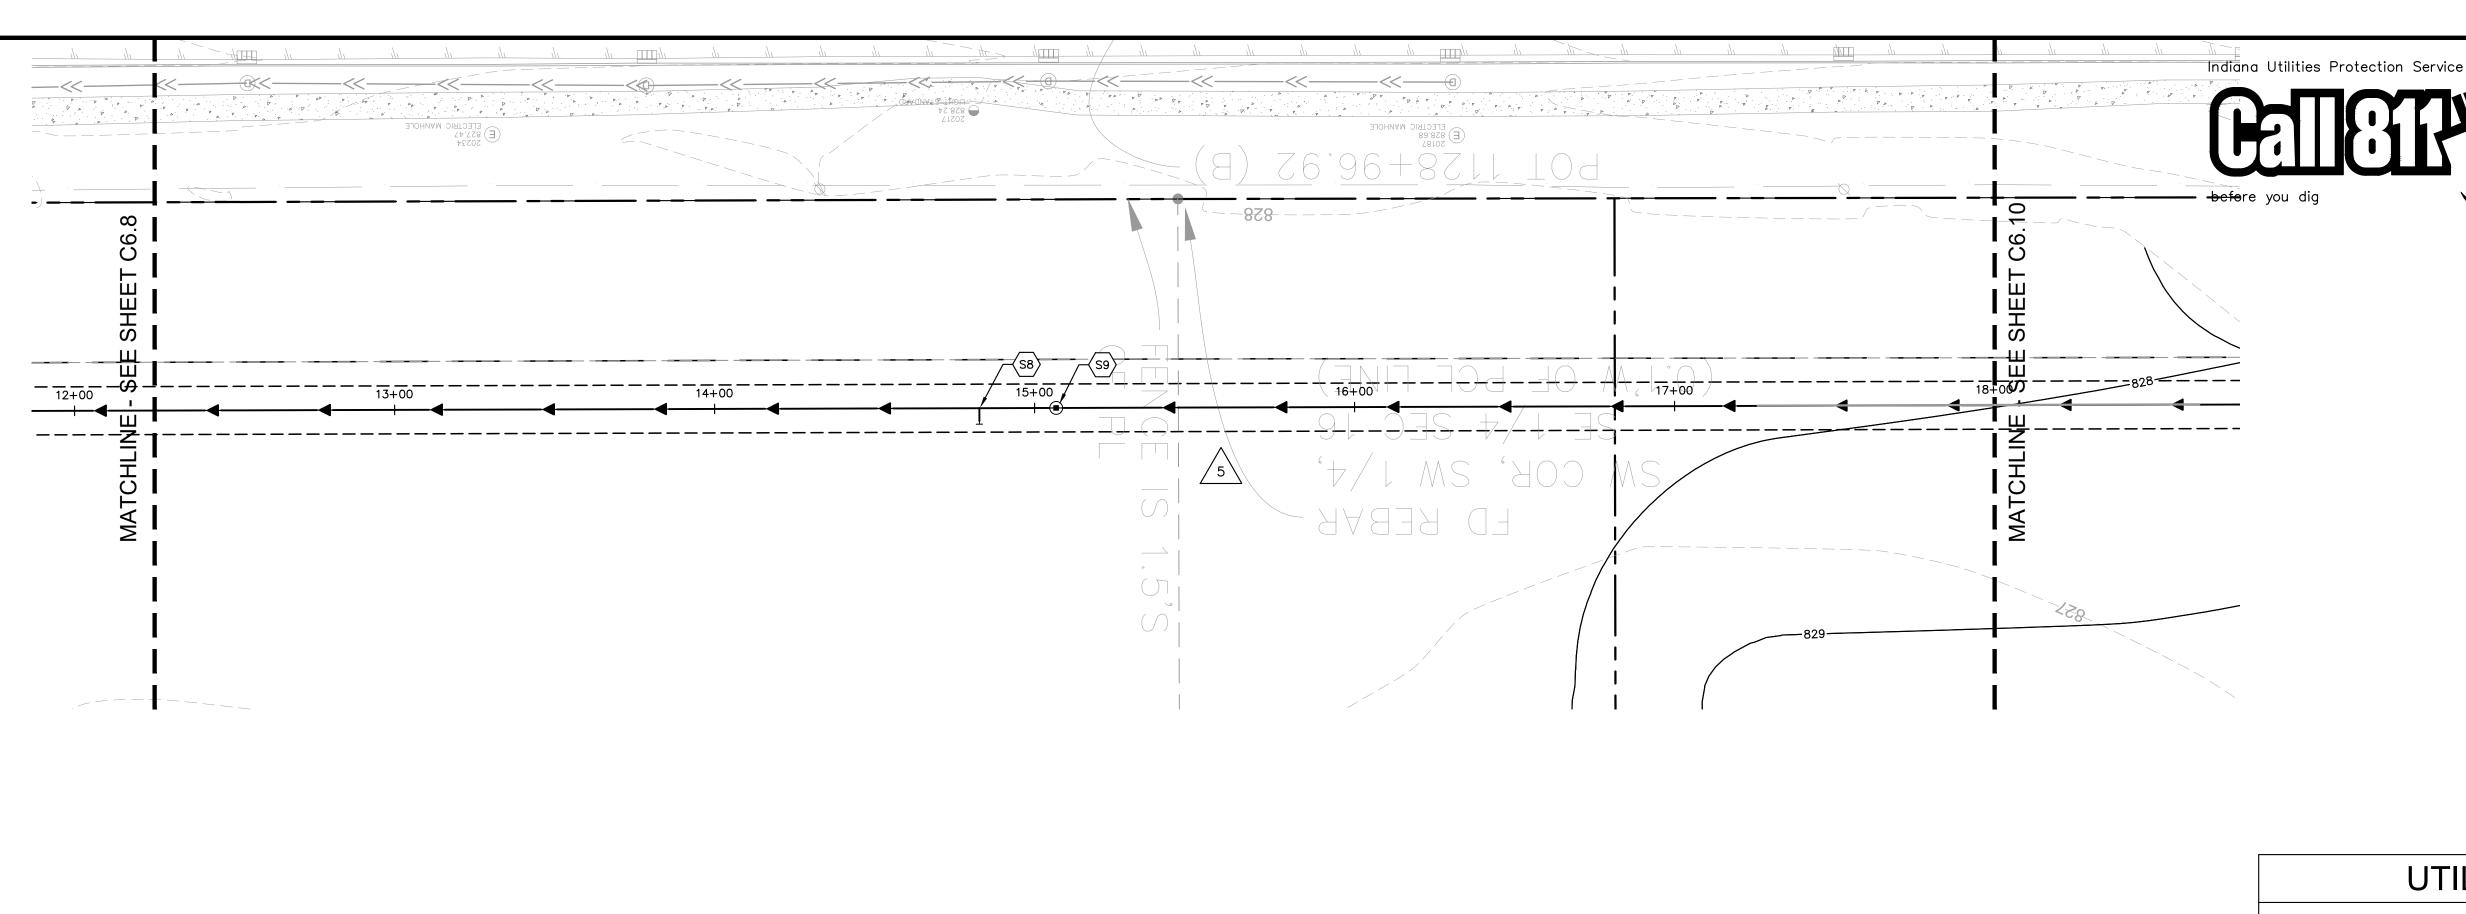

GRAPHIC SCALE IN FEET

Horn

Kimley

GENERAL UTILITY NOTES

- 1. ALL WATER LINES SHALL BE PVC C900 DR-14 OR DUCTILE IRON CL 350.
- 2. ALL SANITARY SEWER LINES SHALL BE PVC MEETING, ASTM D-3034 SDR 26 EXCEPT FOR SANITARY SEWER THAT CROSSES ABOVE WATER MAIN, THIS PIPE SHALL BE AWWA C900 (UNLESS WATER MAIN CASING IS UTILIZED). PROVIDE <u>54"</u> MINIMUM COVER.
- 3. CONTRACTOR SHALL COORDINATE ANY DISRUPTIONS TO EXISTING UTILITY SERVICES WITH ADJACENT PROPERTY OWNERS.
- 4. ALL ELECTRIC AND TELEPHONE EXTENSIONS INCLUDING SERVICE LINES SHALL BE CONSTRUCTED TO THE APPROPRIATE UTILITY COMPANY SPECIFICATIONS. ALL UTILITY DISCONNECTIONS SHALL BE COORDINATED WITH THE DESIGNATED UTILITY COMPANIES.
- CONSTRUCTION SHALL NOT START ON ANY PUBLIC UTILITY SYSTEM UNTIL WRITTEN APPROVAL HAS BEEN RECEIVED BY THE ENGINEER FROM THE APPROPRIATE GOVERNING AUTHORITY AND CONTRACTOR HAS BEEN NOTIFIED BY THE ENGINEER.
- CONTRACTOR TO CALL INDIANA 811 (811 OR 800-382-5544) TO COORDINATE FIELD LOCATIONS OF EXISTING UNDERGROUND UTILITIES BEFORE ORDERING MATERIALS OR COMMENCING CONSTRUCTION. NOTIFY ENGINEER OF ANY DISCREPANCIES IMMEDIATELY.
- PRIOR TO THE CONSTRUCTION OF OR CONNECTION TO ANY STORM DRAIN, SANITARY SEWER, WATER MAIN OR ANY OTHER UTILITIES, THE CONTRACTOR SHALL EXCAVATE, VERIFY AND CALCULATE ALL POINTS OF CONNECTION AND ALL UTILITY CROSSINGS AND INFORM THE ENGINEER AND THE OWNER/ DEVELOPER OF ANY CONFLICT OR REQUIRED DEVIATIONS FROM THE PLAN. NOTIFICATION SHALL BE MADE A MINIMUM OF 72 HOURS PRIOR TO CONSTRUCTION. THE ENGINEER AND ITS CLIENTS SHALL BE HELD HARMLESS IN THE EVENT THAT THE CONTRACTOR FAILS TO MAKE SUCH NOTIFICATION. THE CITY OF NOBLESVILLE SHALL BE NOTIFIED OF ANY AND ALL CHANGES TO THE
- 8. CONTRACTOR SHALL COMPLY COMPLETELY WITH THE LATEST STANDARDS OF OSHA DIRECTIVES OR ANY OTHER AGENCY HAVING JURISDICTION FOR EXCAVATION AND TRENCHING PROCEDURES. THE CONTRACTOR SHALL USE SUPPORT SYSTEMS, SLOPING, BENCHING AND OTHER MEANS OF PROTECTION. THIS IS TO INCLUDE, BUT NOT LIMITED FOR ACCESS AND EGRESS FROM ALL EXCAVATION AND TRENCHING. CONTRACTOR IS RESPONSIBLE FOR COMPLYING WITH PERFORMANCE CRITERIA AS REQUIRED BY OSHA.
- 9. CONTRACTOR TO AVOID DISRUPTION OF ANY ADJACENT TENANT'S TRAFFIC OPERATIONS DURING INSTALLATION OF UTILITIES.
- 10. ALL DIMENSIONS ARE TO CENTERLINE OF PIPE OR CENTER OF MANHOLE UNLESS NOTED OTHERWISE.
- 11. SEE ARCHITECTURAL AND MEP PLANS FOR EXACT UTILITY CONNECTION LOCATIONS AT BUILDING.
- 12. LIGHT POLES SHOWN FOR COORDINATION PURPOSES ONLY AND DO NOT REPRESENT ACTUAL SIZE. SEE SITE LIGHTING PLANS BY OTHERS FOR MORE INFORMATION.
- 13. SEE DETAILS FOR LOCATING STORM STRUCTURES WITHIN THE CURB LINE.
- 14. STORMWATER FACILITIES MUST BE FUNCTIONAL BEFORE BUILDING CONSTRUCTION

NOTE: CONTRACTOR TO CAP AND MARK END OF STUB FOR ALL SANITARY LATERALS. SANITARY LATERALS TO BE 6" PVC WITH 1% MINIMUM SLOPE.

AS-BUILT

NOTES AND LEGEND

- CONTRACTOR TO HORIZONTALLY AND VERTICALLY FIELD LOCATE EXISTING CROSSING UTILITIES, PROVIDE TOP OF PIPE ELEVATION, AND VERIFY SIZE. THIS INFORMATION SHOULD BE PROVIDED TO THE ENGINEER PRIOR TO ORDERING MATERIALS.
- 2. GRANULAR BACKFILL SHALL BE PER CITY OF NOBLESVILLE STANDARDS

GRANULAR BACKFILL
REQUIRED BENEATH AND WITHIN 5 FEET OF PAVEMENT

ORIGINAL ISSUE: 04/29/2019 KHA PROJECT NO. 170072000 SHEET NUMBER


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SAMPUS CENTER 146TH STREET & PROMISE ROAD NOBLESVILLE, IN


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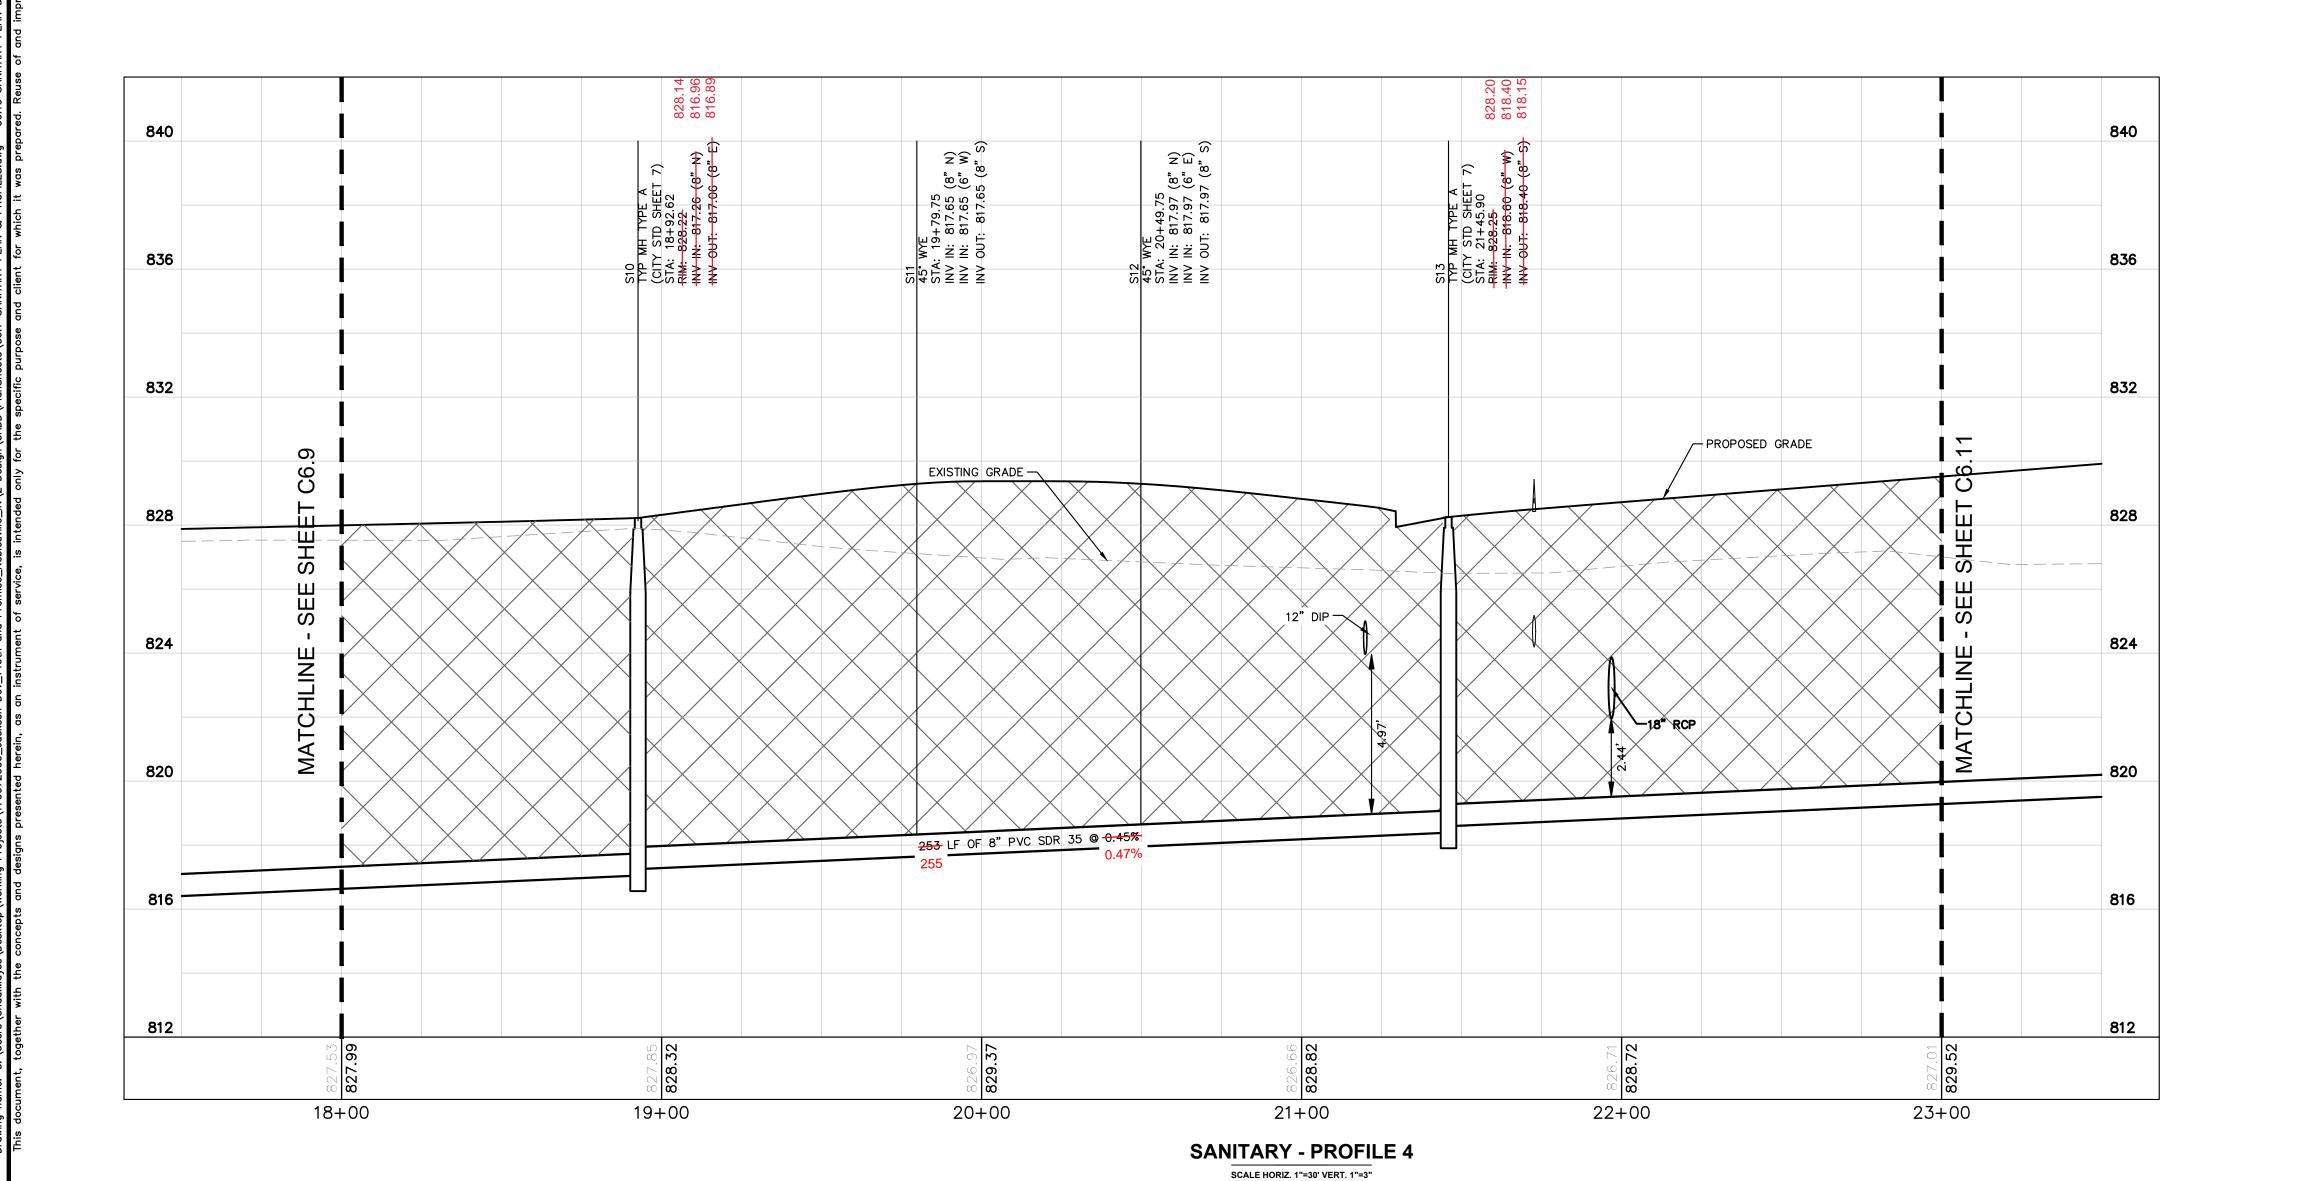
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SCALE HORIZ. 1"=30' VERT. 1"=3"






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Indiana Utilities Protection Service

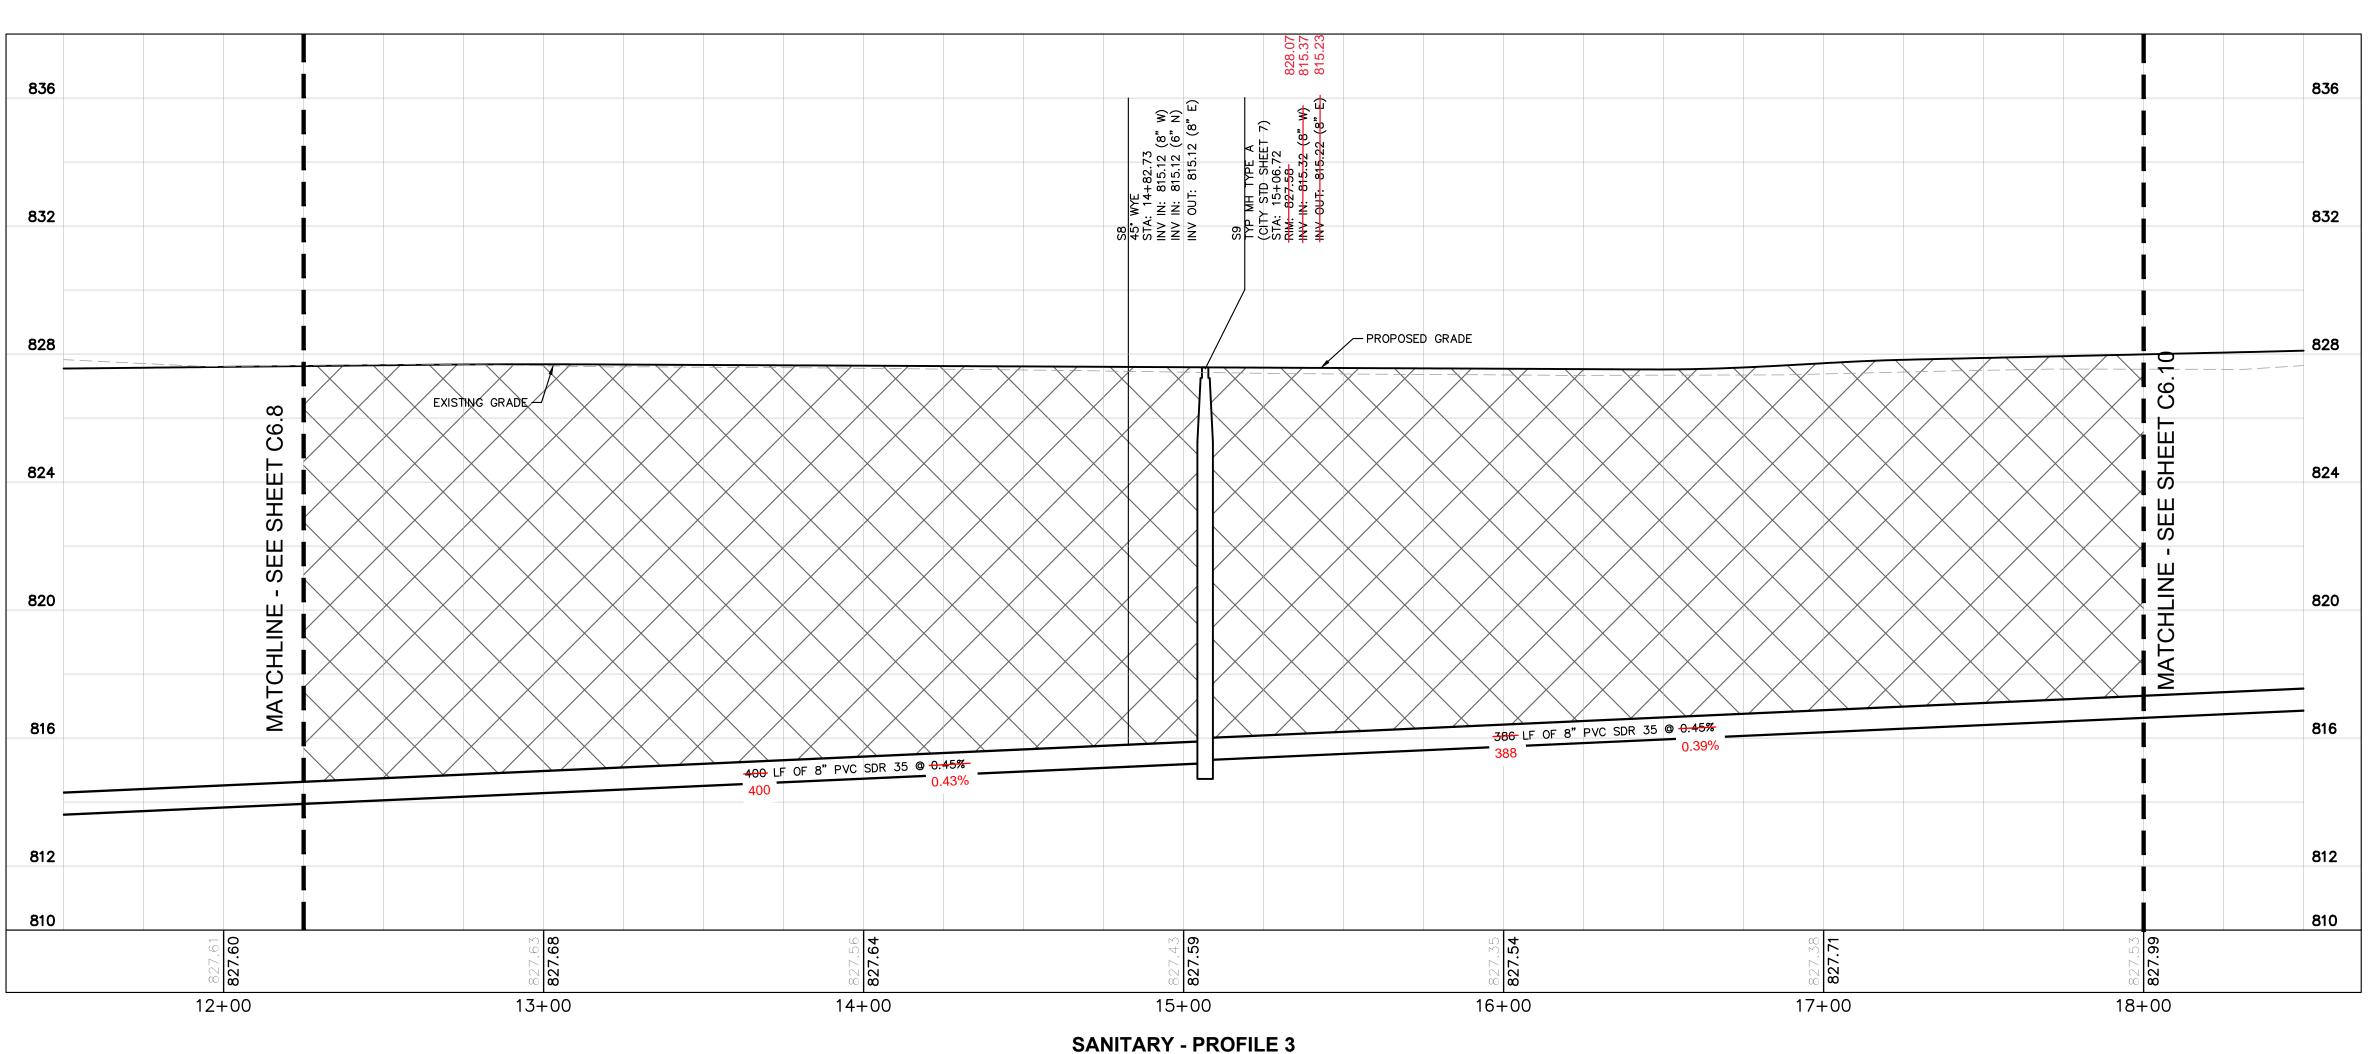

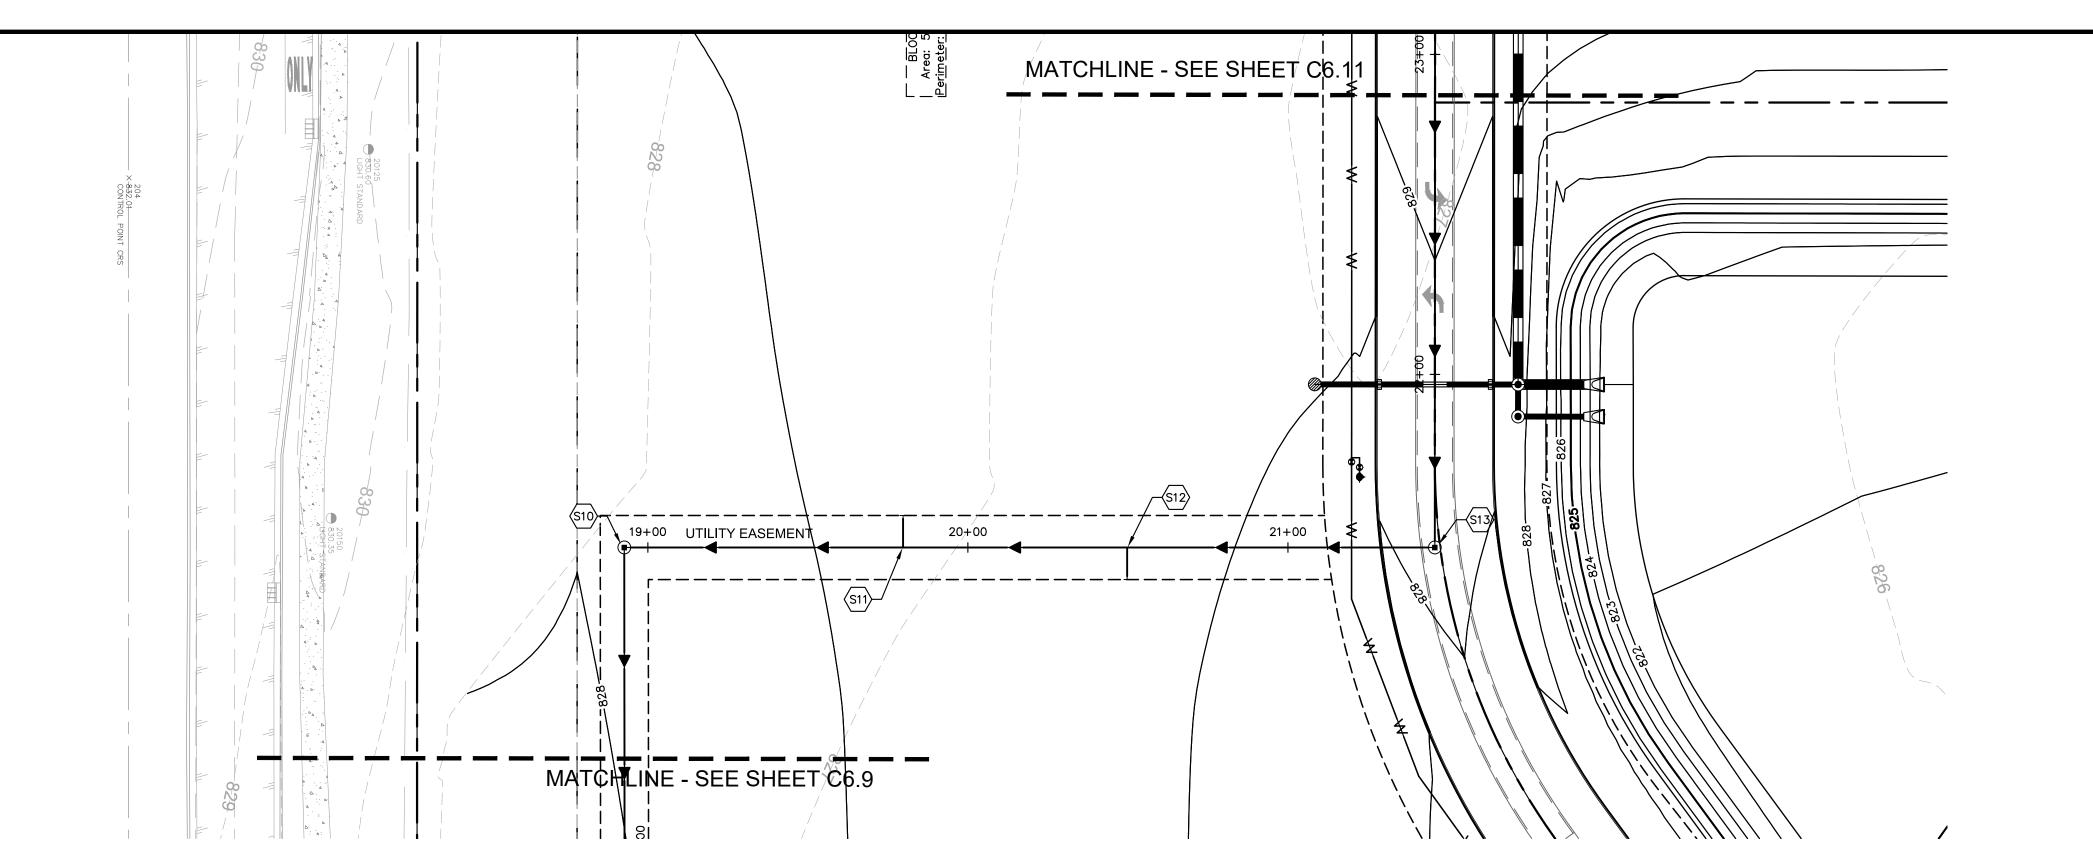

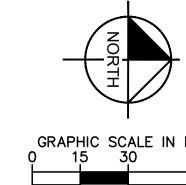	TLM	TUM	TUM	MSO	MSO	SAO	arN
	4/13/2020	2/13/2020	2/3/2020	61/12/01	61/80/01	09/12/19	01/21/80
SCALE IN FEET 30 60							

SNOISING	1 2
CITY COMMENTS	\triangleleft
SANITARY/WATER REVISIONS	⊘
INAW REVISIONS	INC.
INAW REVISIONS	\triangleleft
EASEMENT COORDINATION	<
WATERMAIN REVISION	<
FIRE HYDRANT COORDINATION	%

| | | | | Kimley

4. ALL ELECTRIC AND TELEPHONE EXTENSIONS INCLUDING SERVICE LINES SHALL BE CONSTRUCTED TO THE APPROPRIATE UTILITY COMPANY SPECIFICATIONS. ALL UTILITY DISCONNECTIONS SHALL BE COORDINATED WITH THE DESIGNATED UTILITY COMPANIES.

UTILITY NOTES

1. ALL WATER LINES SHALL BE PVC C900 DR-14 OR DUCTILE IRON CL 350.

3. CONTRACTOR SHALL COORDINATE ANY DISRUPTIONS TO EXISTING UTILITY

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GENERAL UTILITY NOTES

<u>54"</u> MINIMUM COVER.

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13. SEE DETAILS FOR LOCATING STORM STRUCTURES WITHIN THE CURB LINE.

14. STORMWATER FACILITIES MUST BE FUNCTIONAL BEFORE BUILDING CONSTRUCTION

NOTE: CONTRACTOR TO CAP AND MARK END OF STUB FOR ALL SANITARY LATERALS. SANITARY LATERALS TO BE 6" PVC WITH 1% MINIMUM SLOPE.

AS-BUILT


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GRANULAR BACKFILL
REQUIRED BENEATH AND WITHIN 5 FEET OF PAVEMENT

ORIGINAL ISSUE: 04/29/2019 KHA PROJECT NO. 170072000 SHEET NUMBER

SAMPUS CENTEF 146TH STREET & PROMISE ROAD NOBLESVILLE, IN



UTILITY NOTES

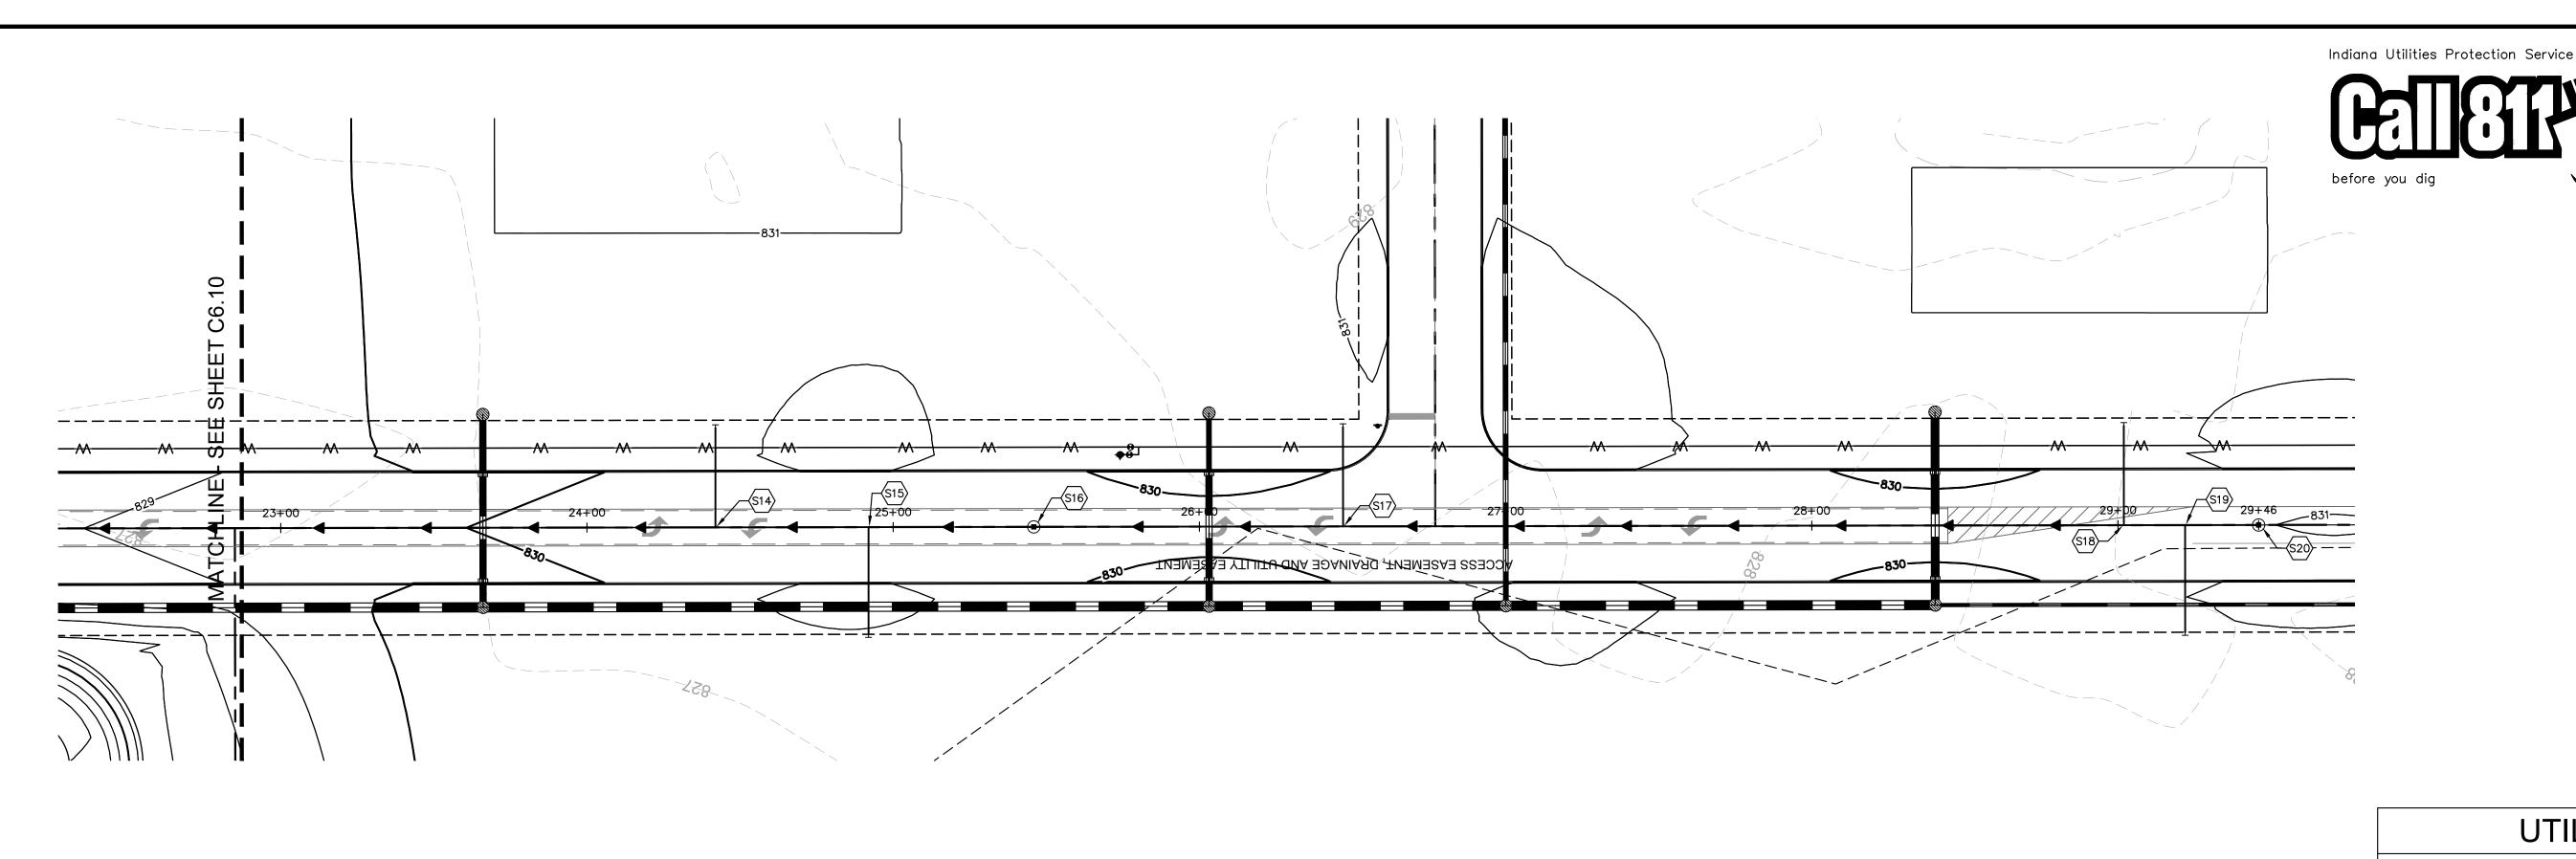GRAPHIC SCALE IN FEET

Horn

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AS-BUILT

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GRANULAR BACKFILL REQUIRED BENEATH AND WITHIN 5 FEET OF PAVEMENT ORIGINAL ISSUE:
04/29/2019


KHA PROJECT NO.
170072000

SHEET NUMBER

SAMPUS CENTEF 146TH STREET & PROMISE ROAD NOBLESVILLE, IN


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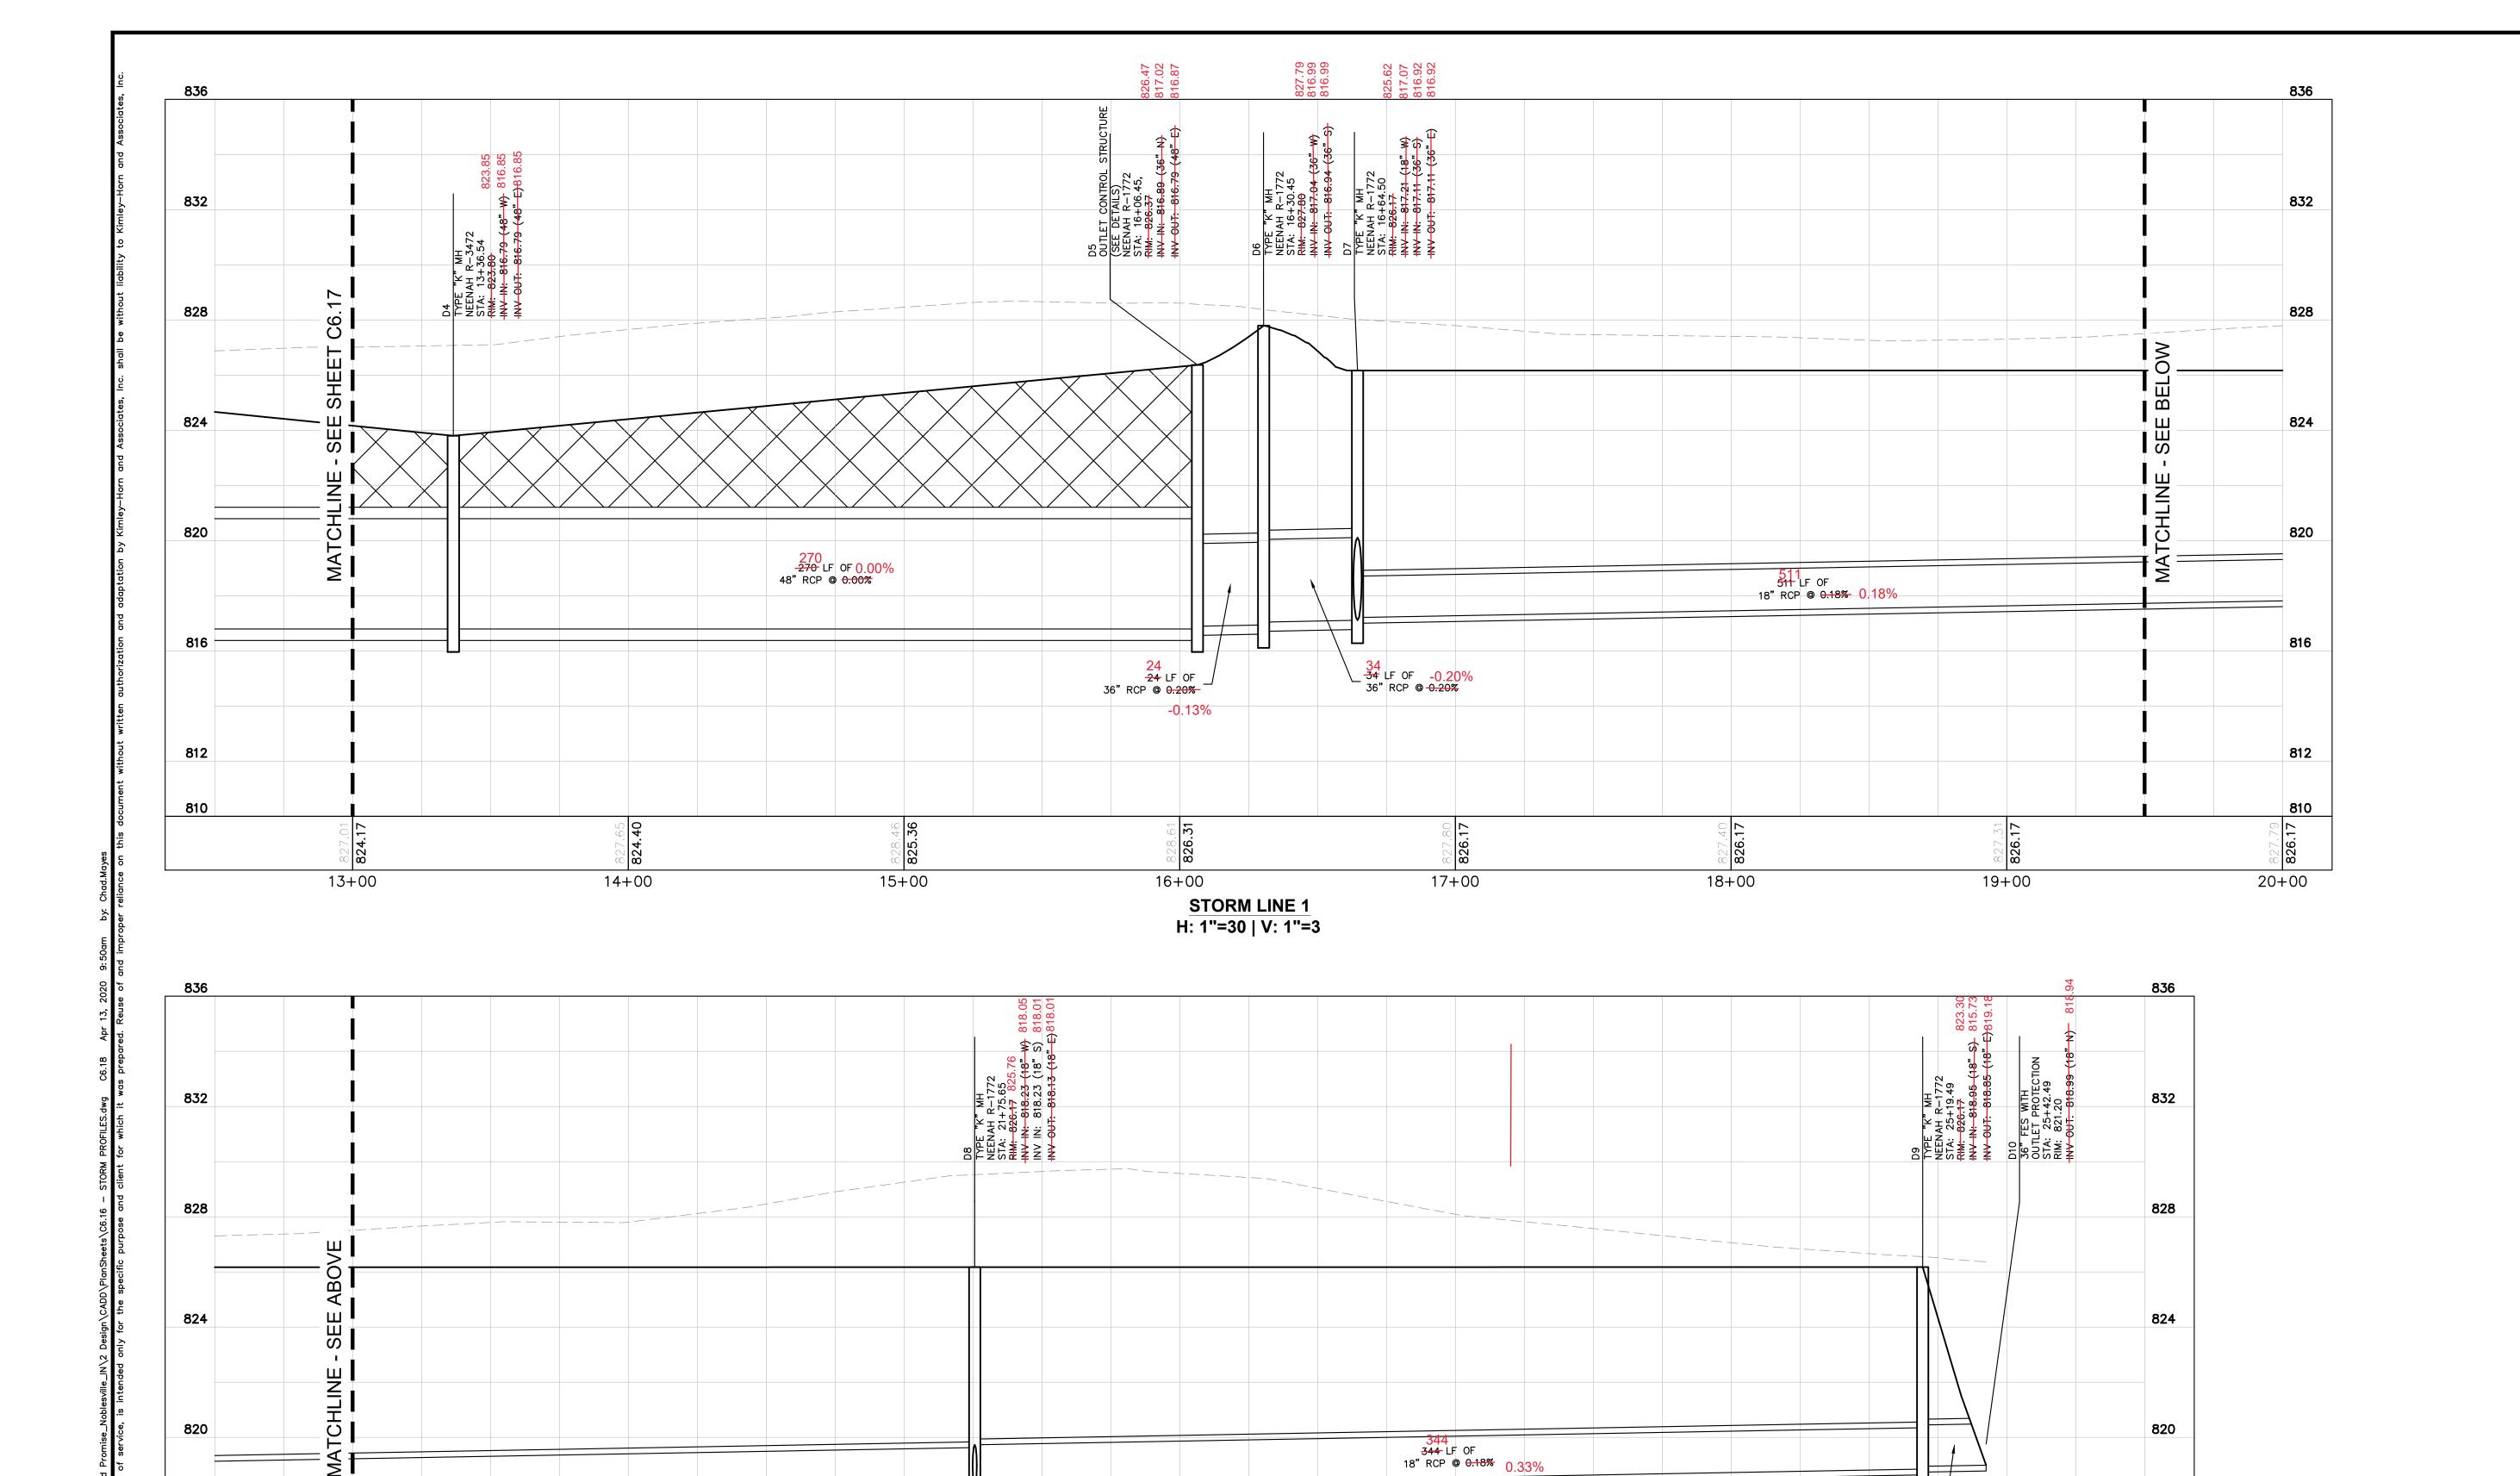
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SANITARY - PROFILE 5

SCALE HORIZ. 1"=30' VERT. 1"=3"

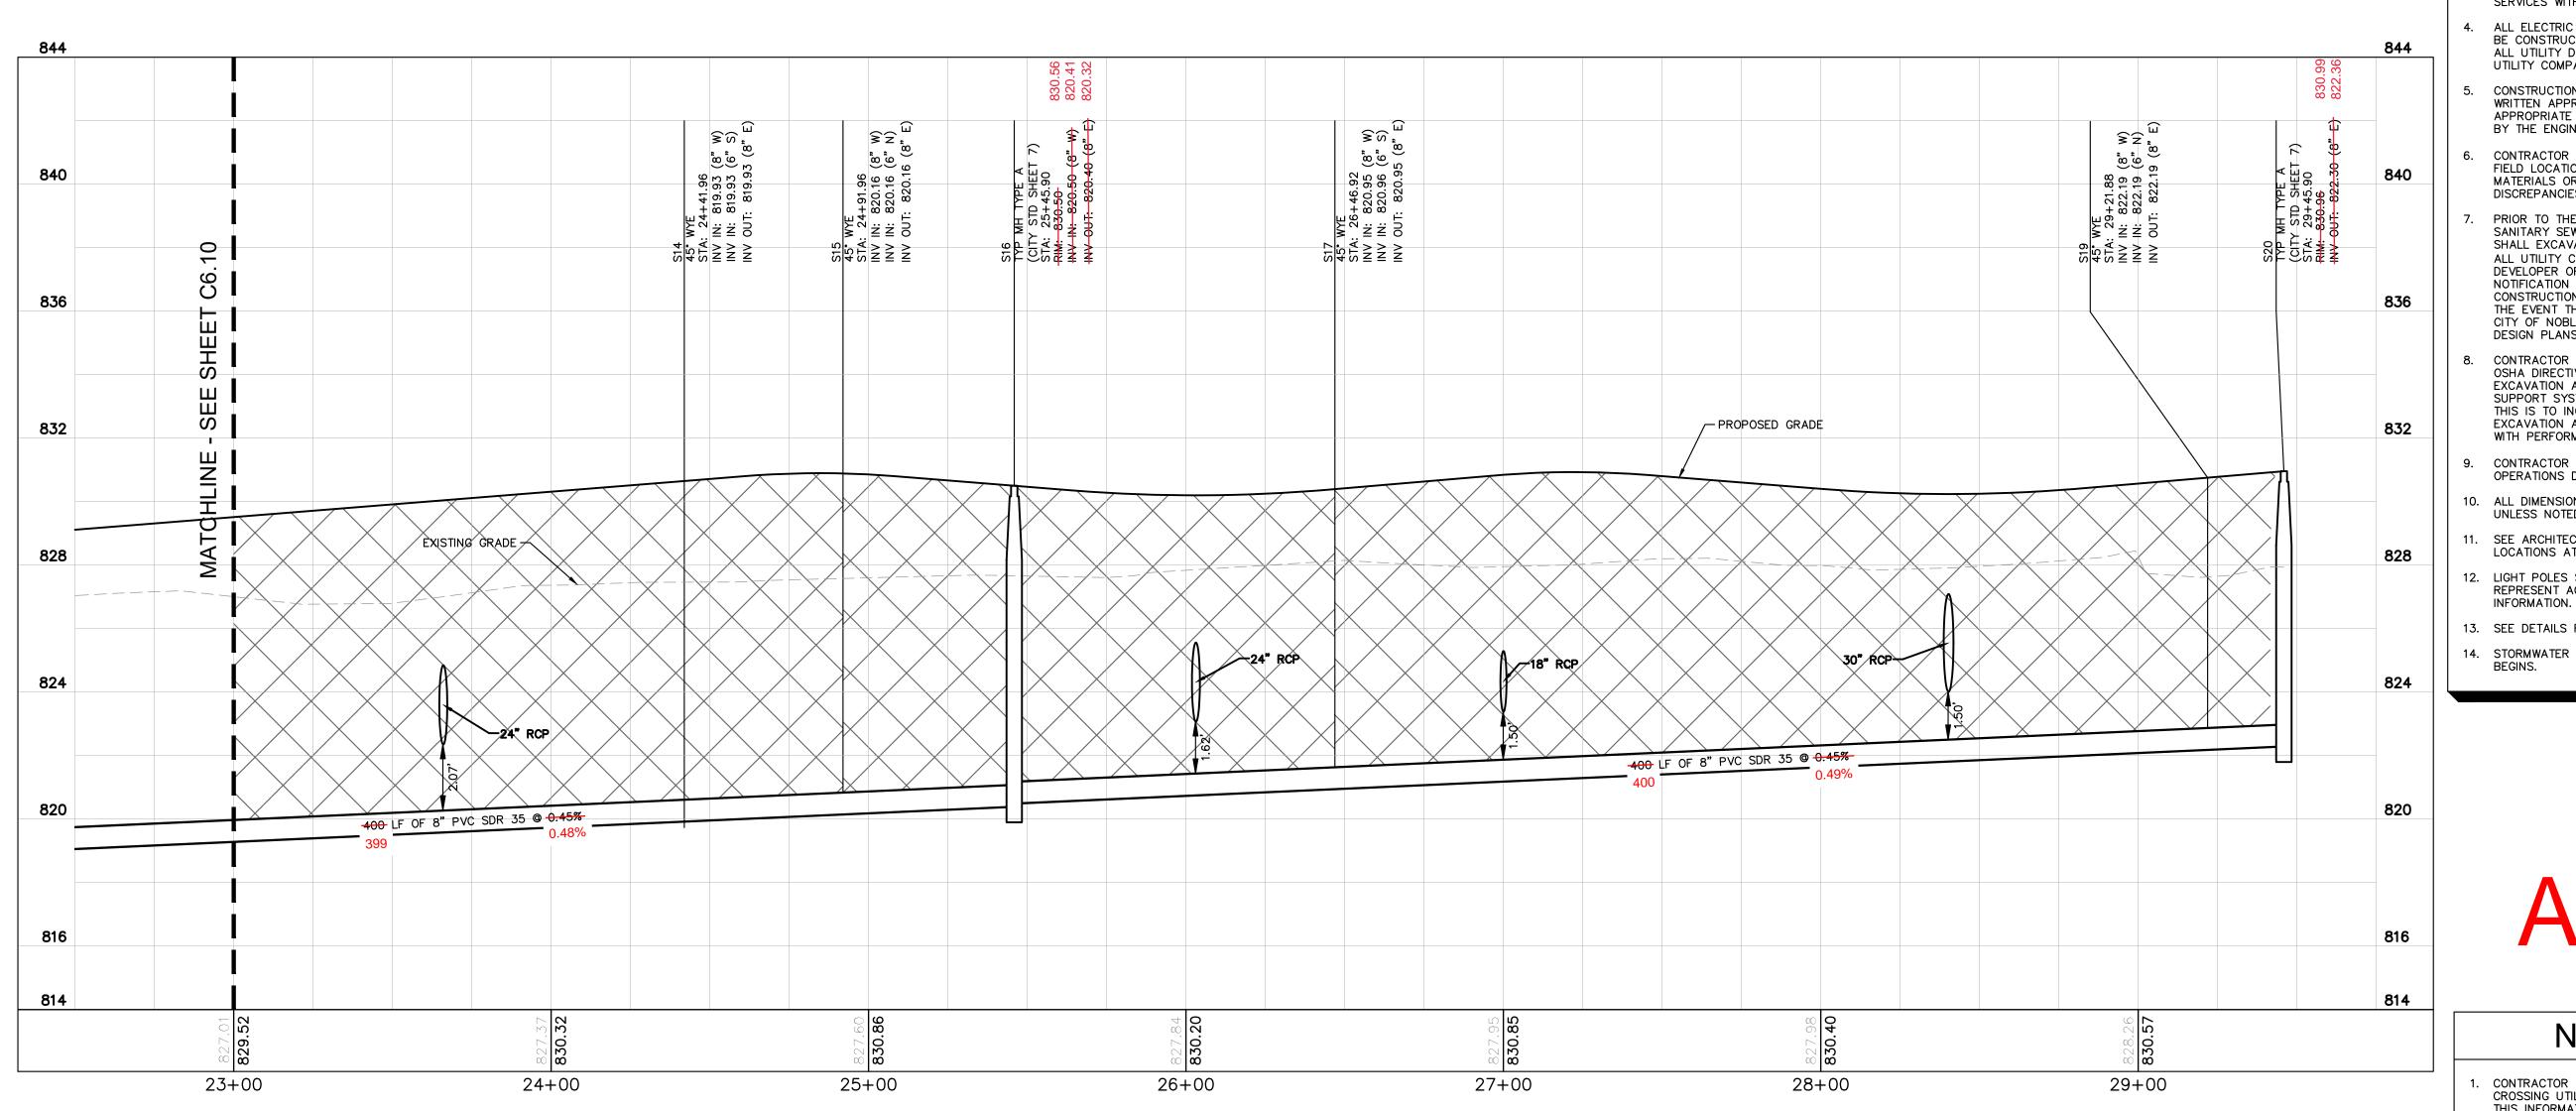



23+00

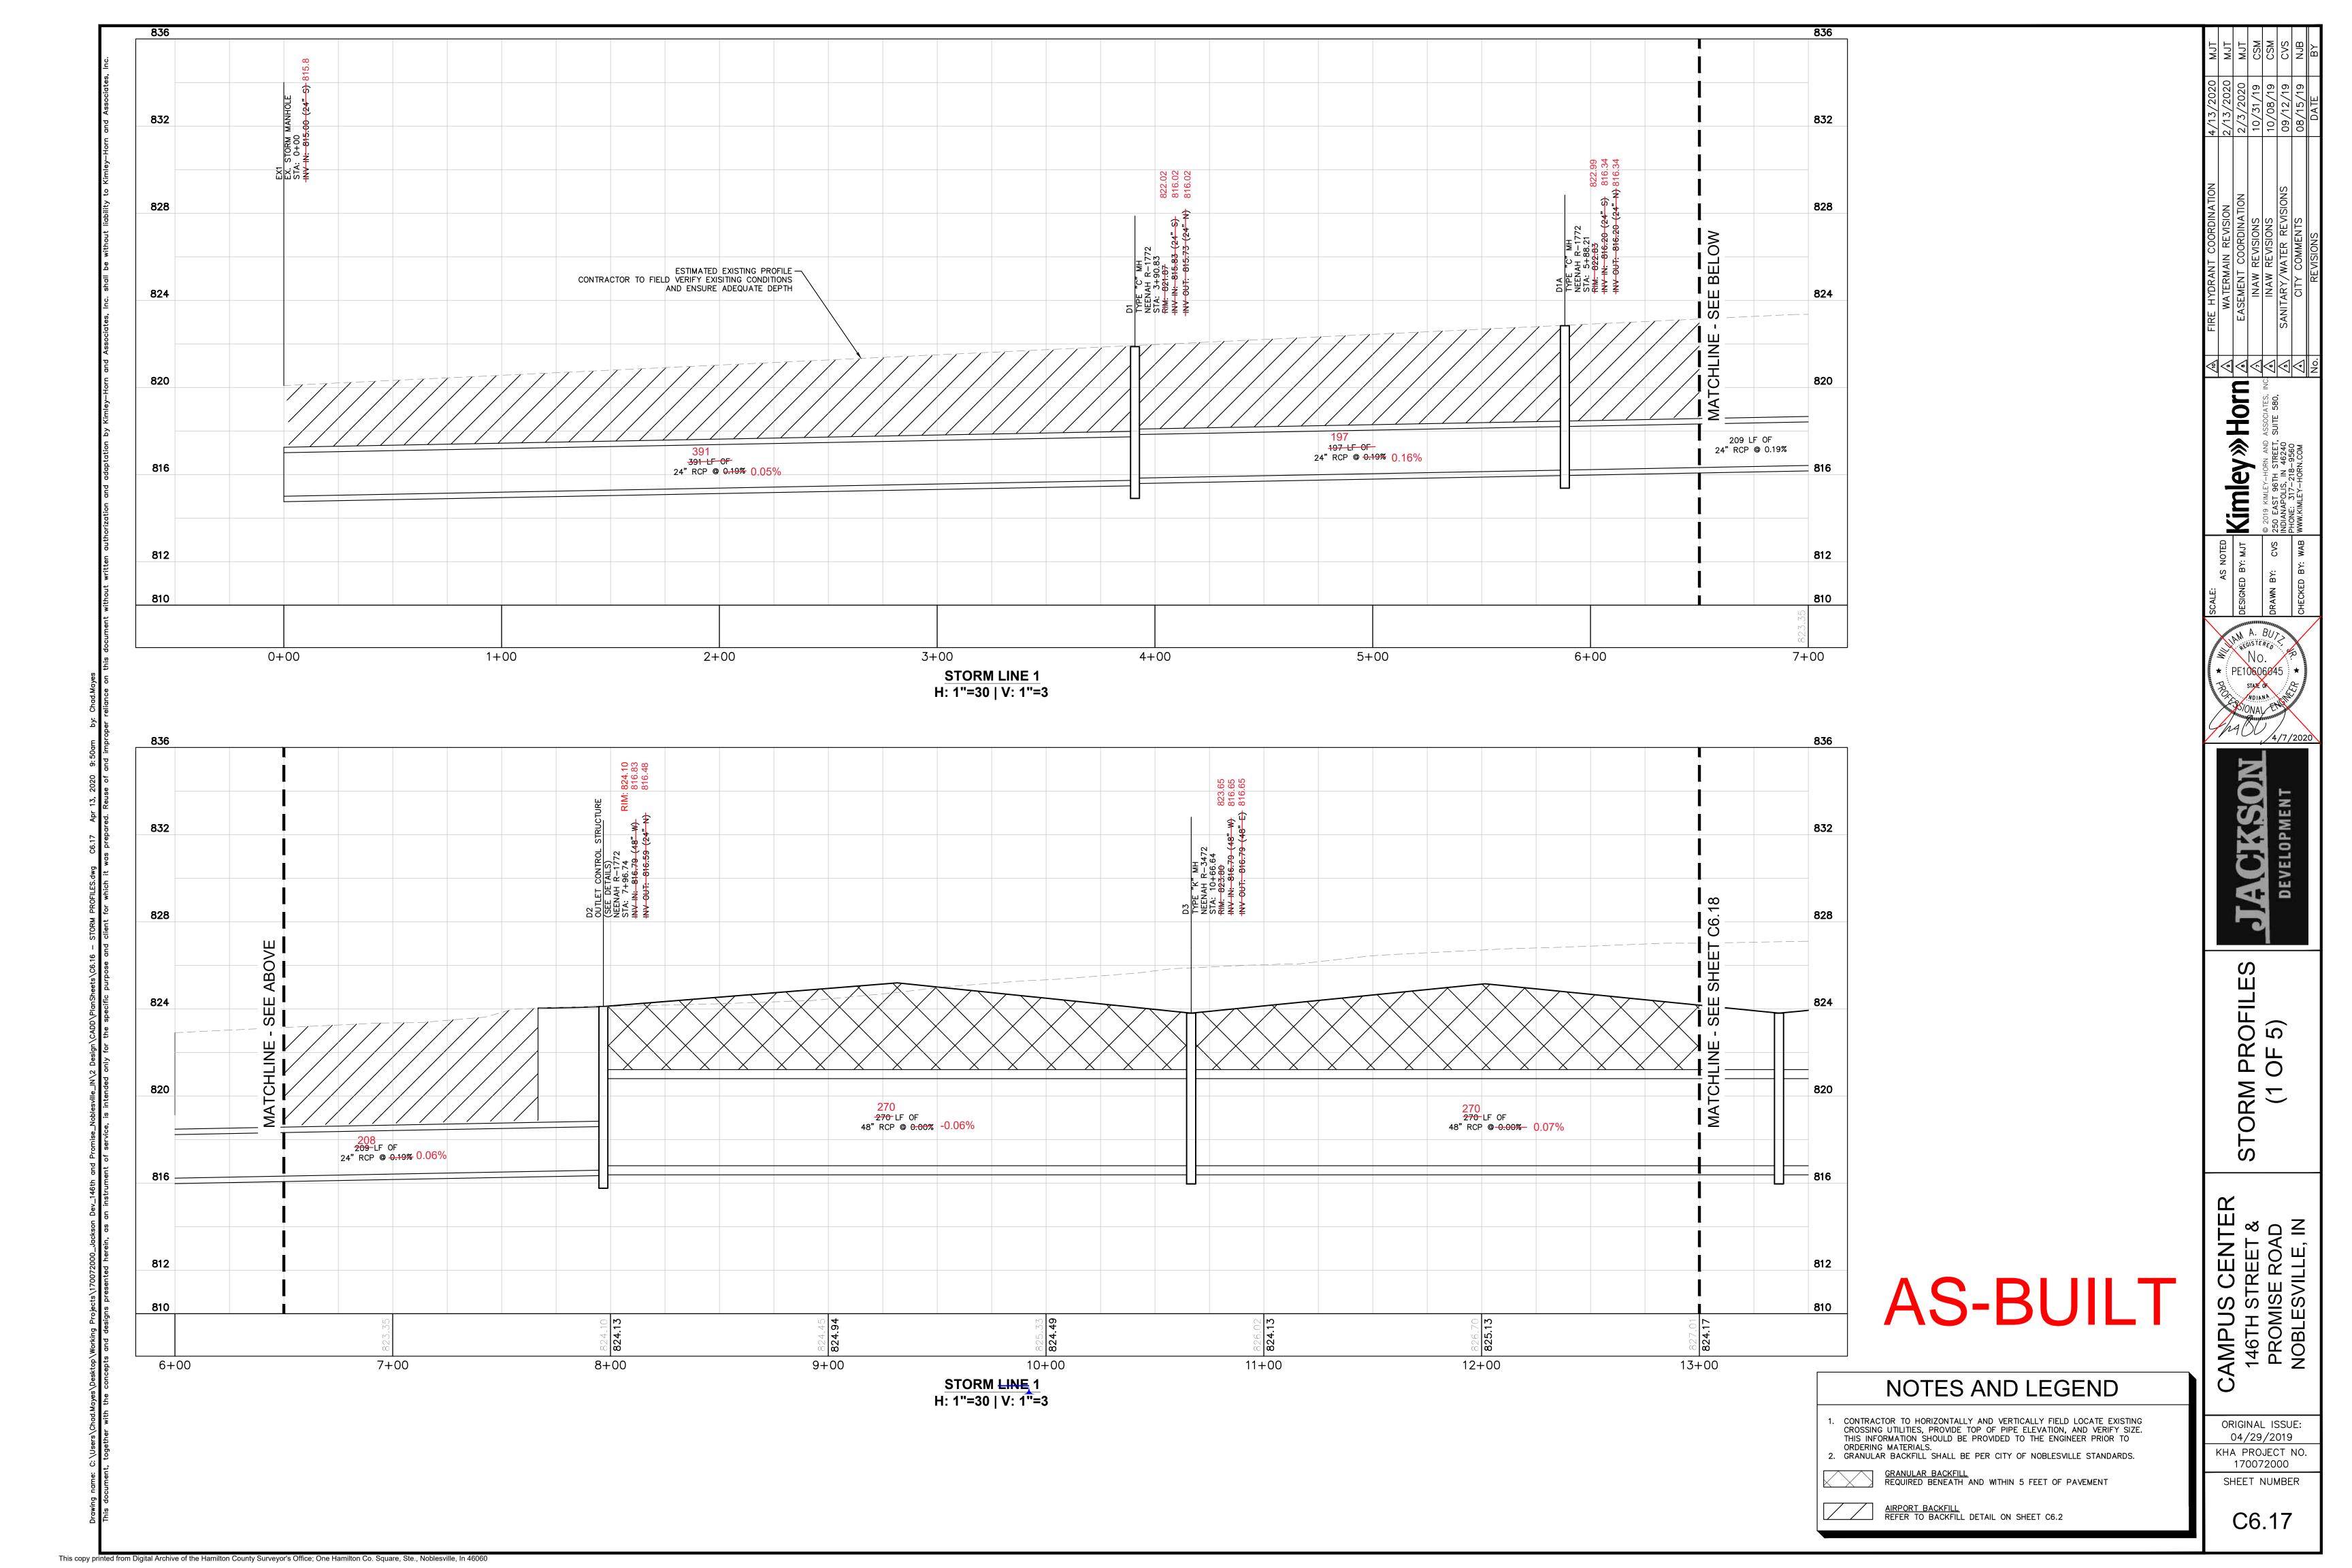STORM LINE 1

H: 1"=30 | V: 1"=3

24+00

816

812

19+00

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20+00

21+00

22+00

AS-BUILT

NOTES AND LEGEND

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GRANULAR BACKFILL
REQUIRED BENEATH AND WITHIN 5 FEET OF PAVEMENT

23 -23 LF OF 18" RCP @ 0.18%

25+00

816

812

810

ORIGINAL ISSUE:
04/29/2019


KHA PROJECT NO.
170072000


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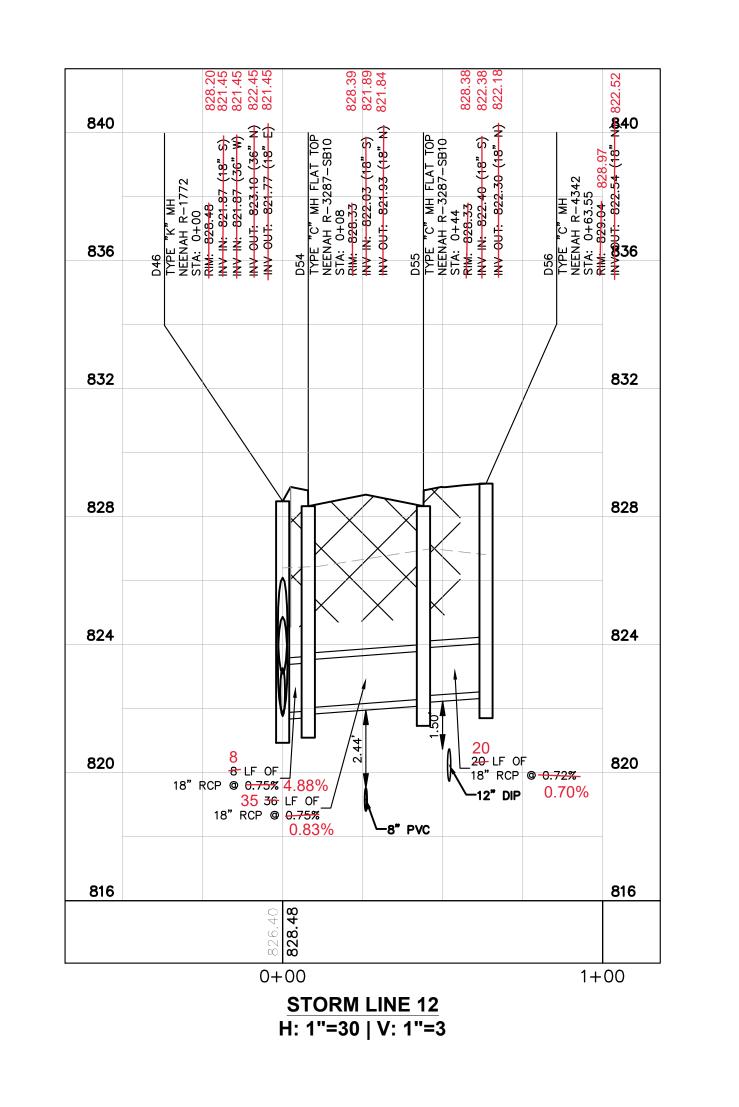
CAMPUS CENTER 146TH STREET & PROMISE ROAD NOBLESVILLE, IN


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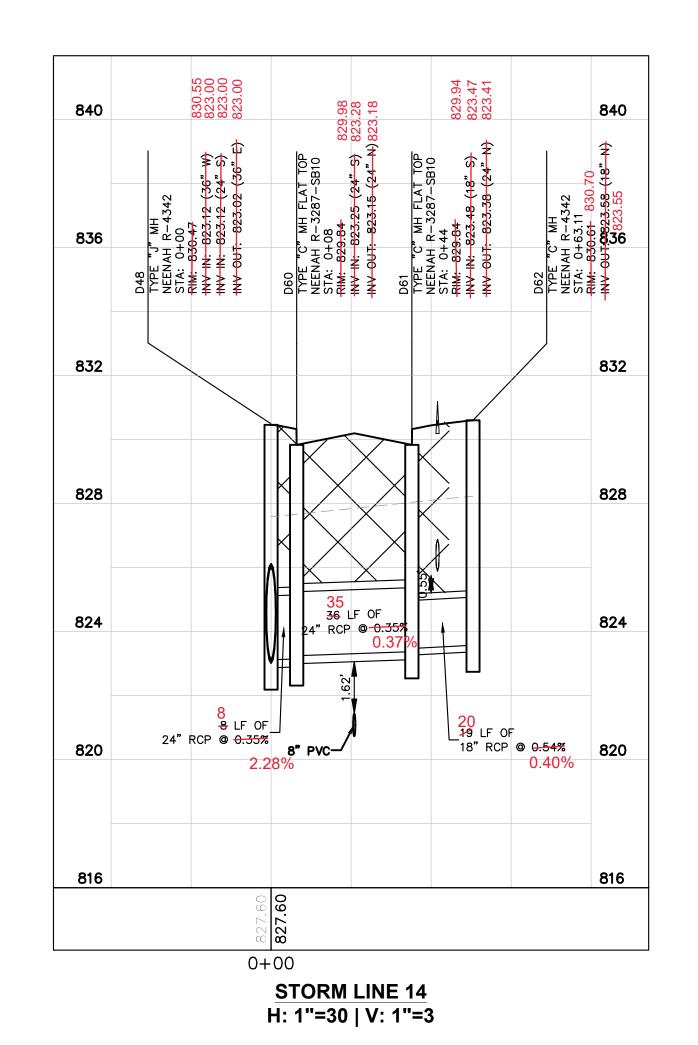
Kimley » Horn






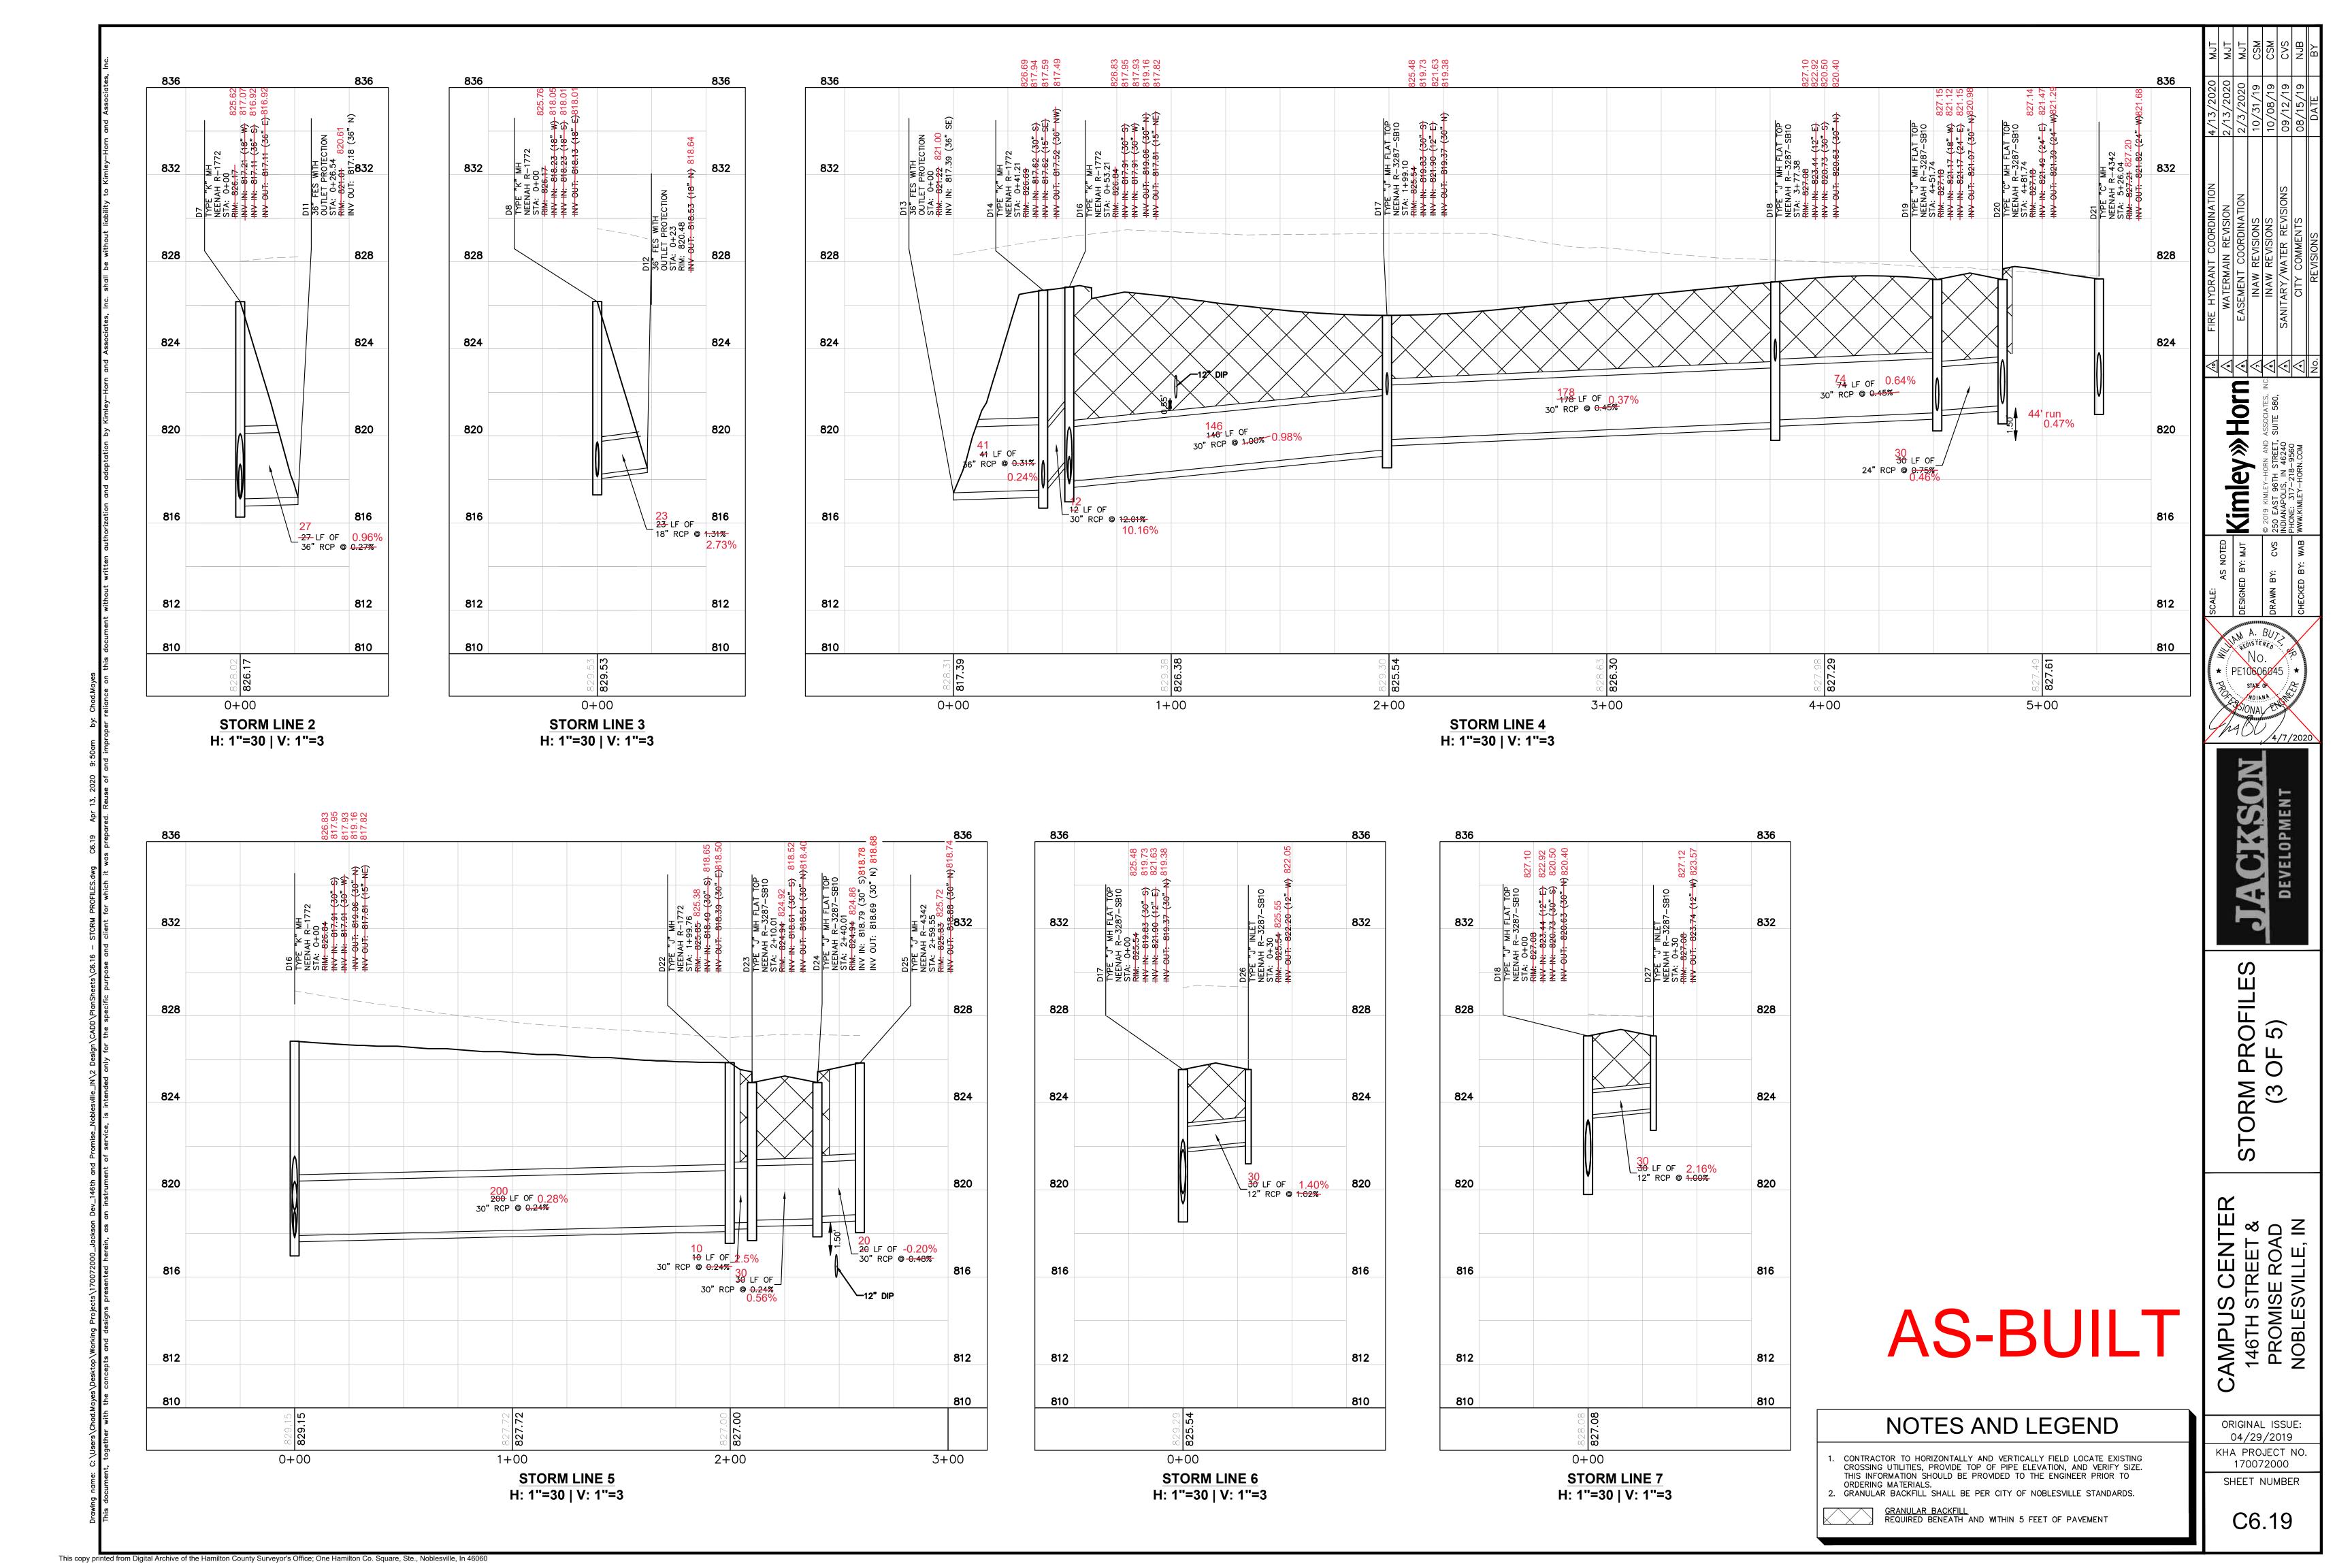


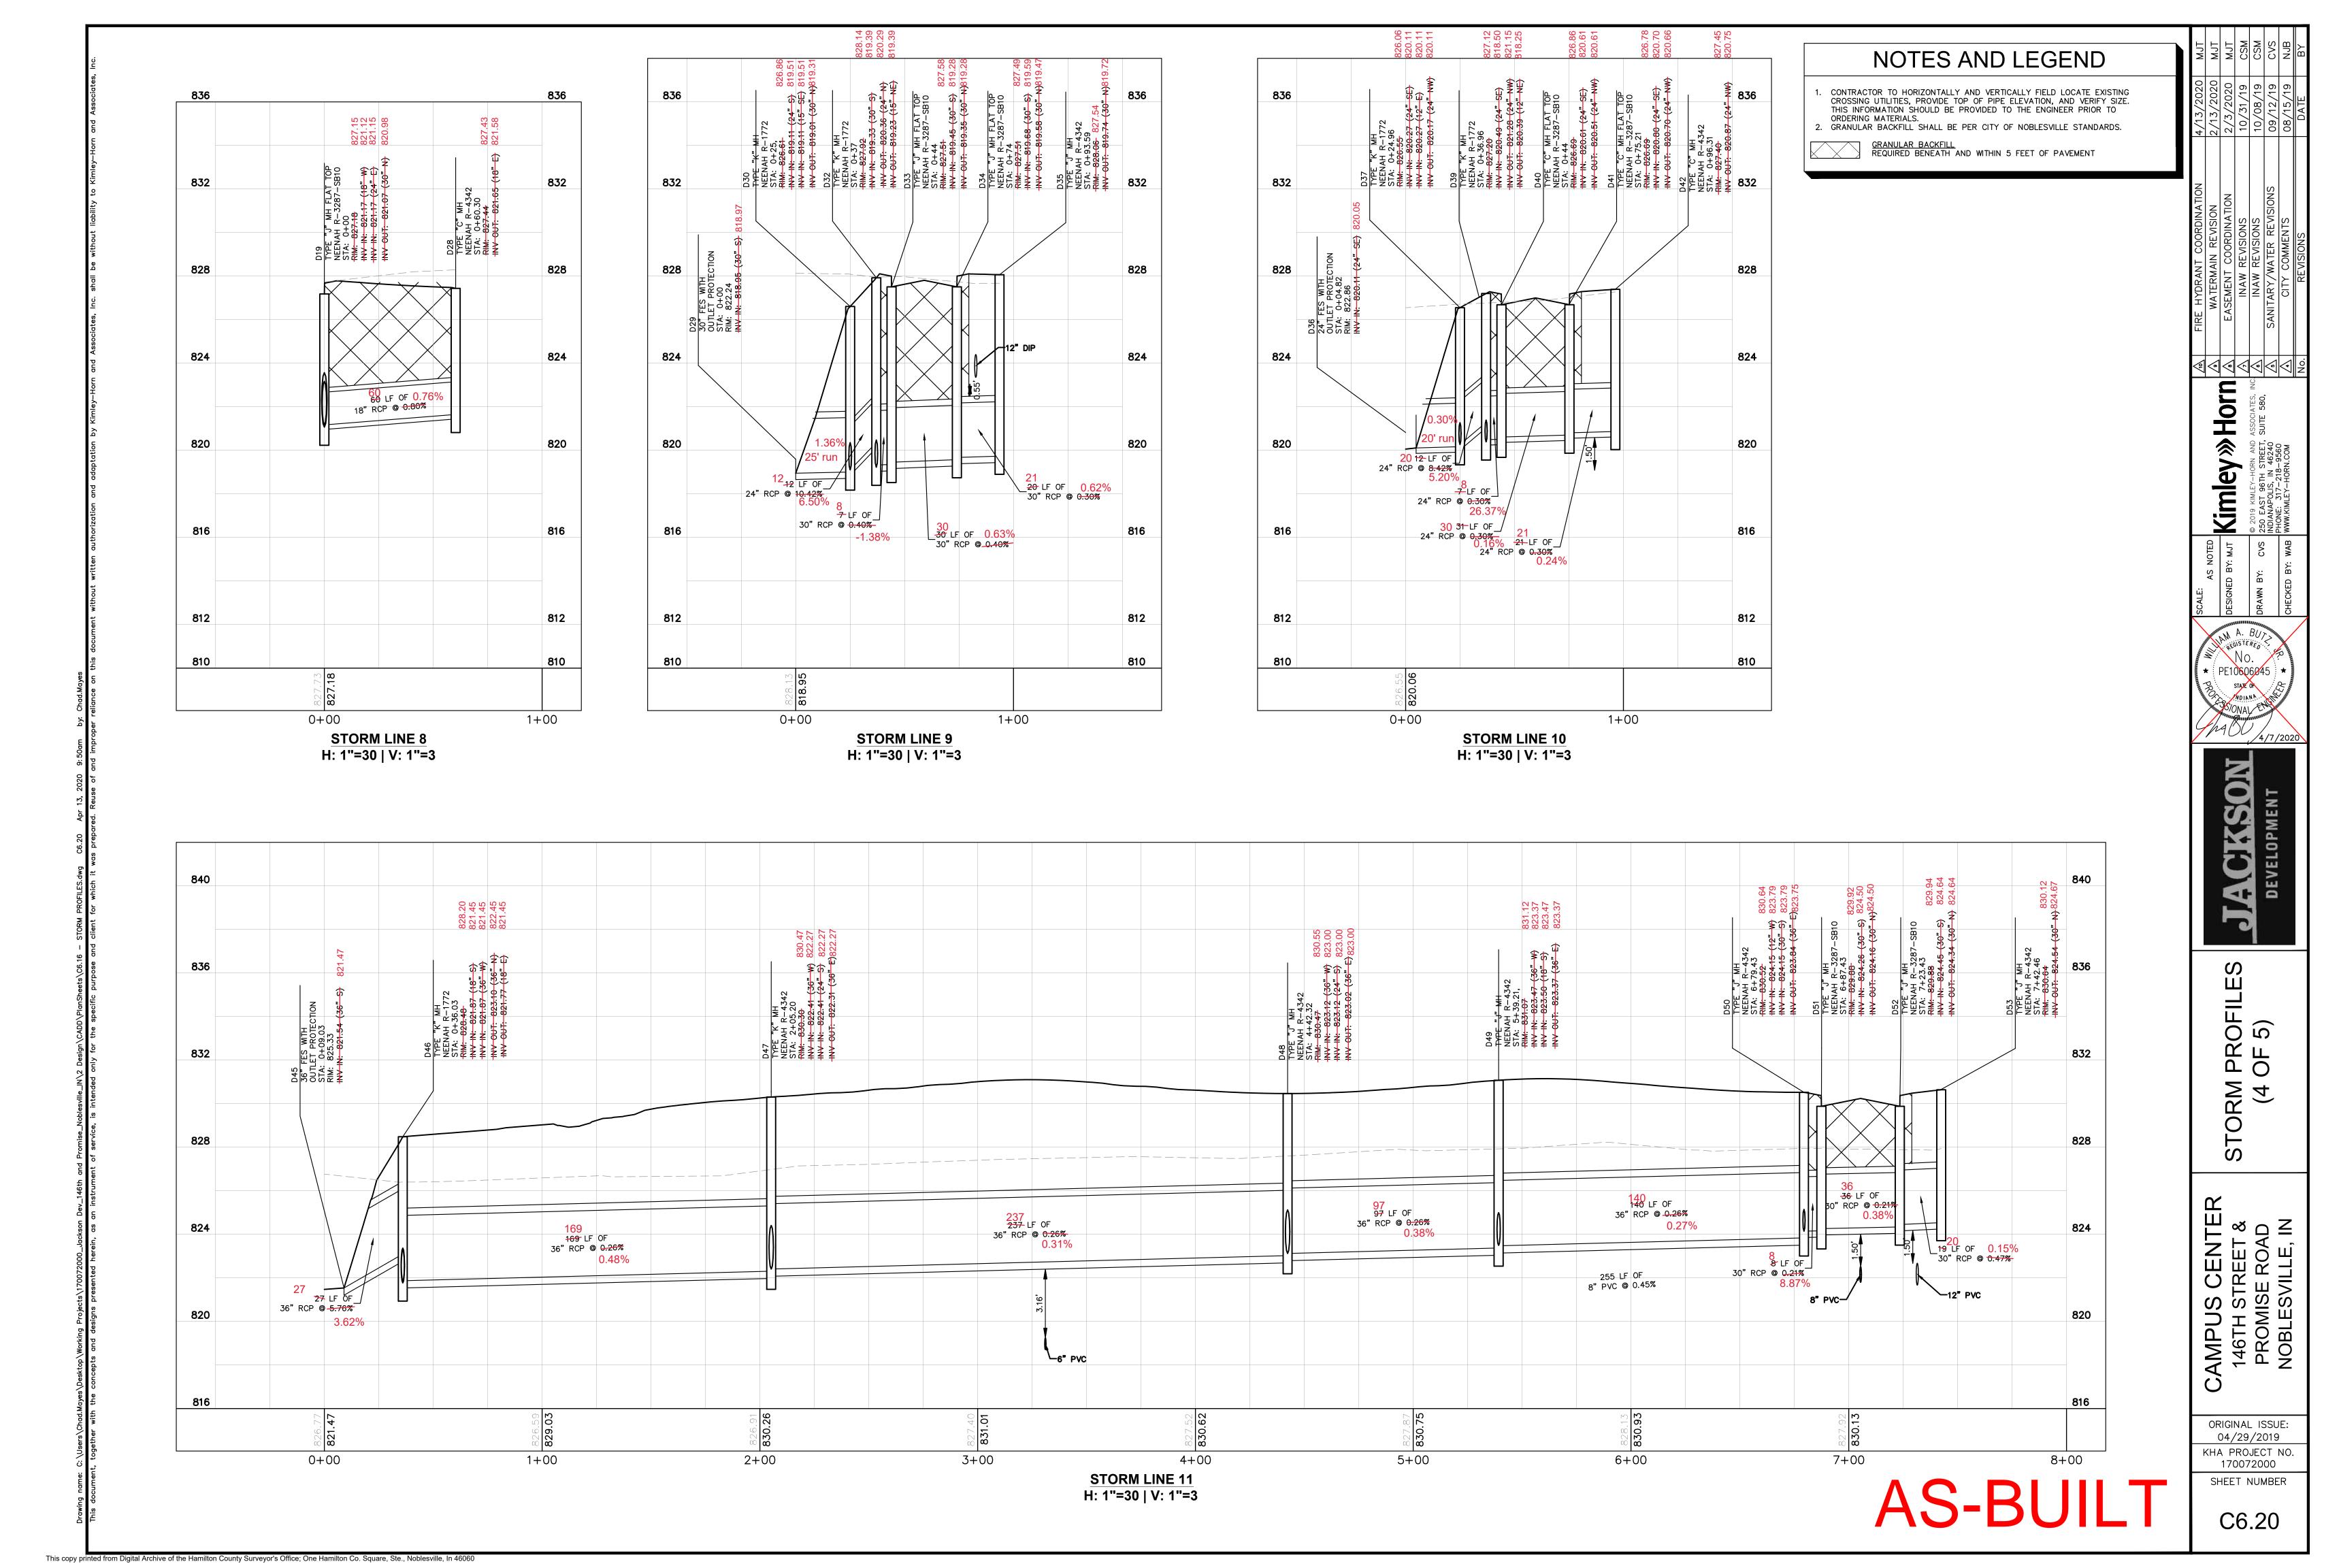

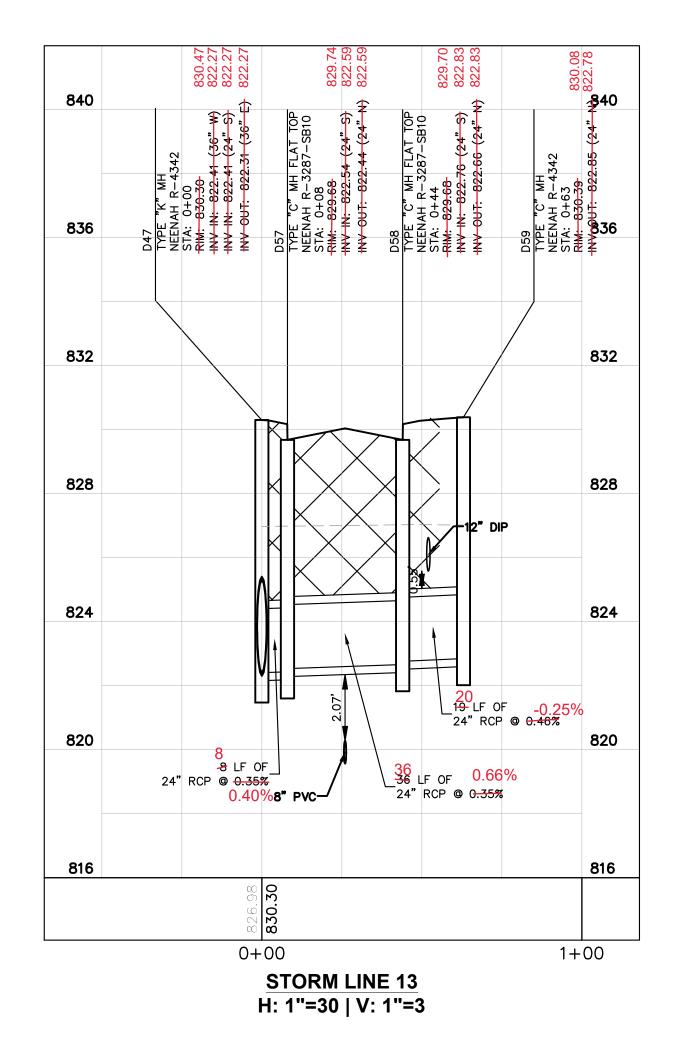

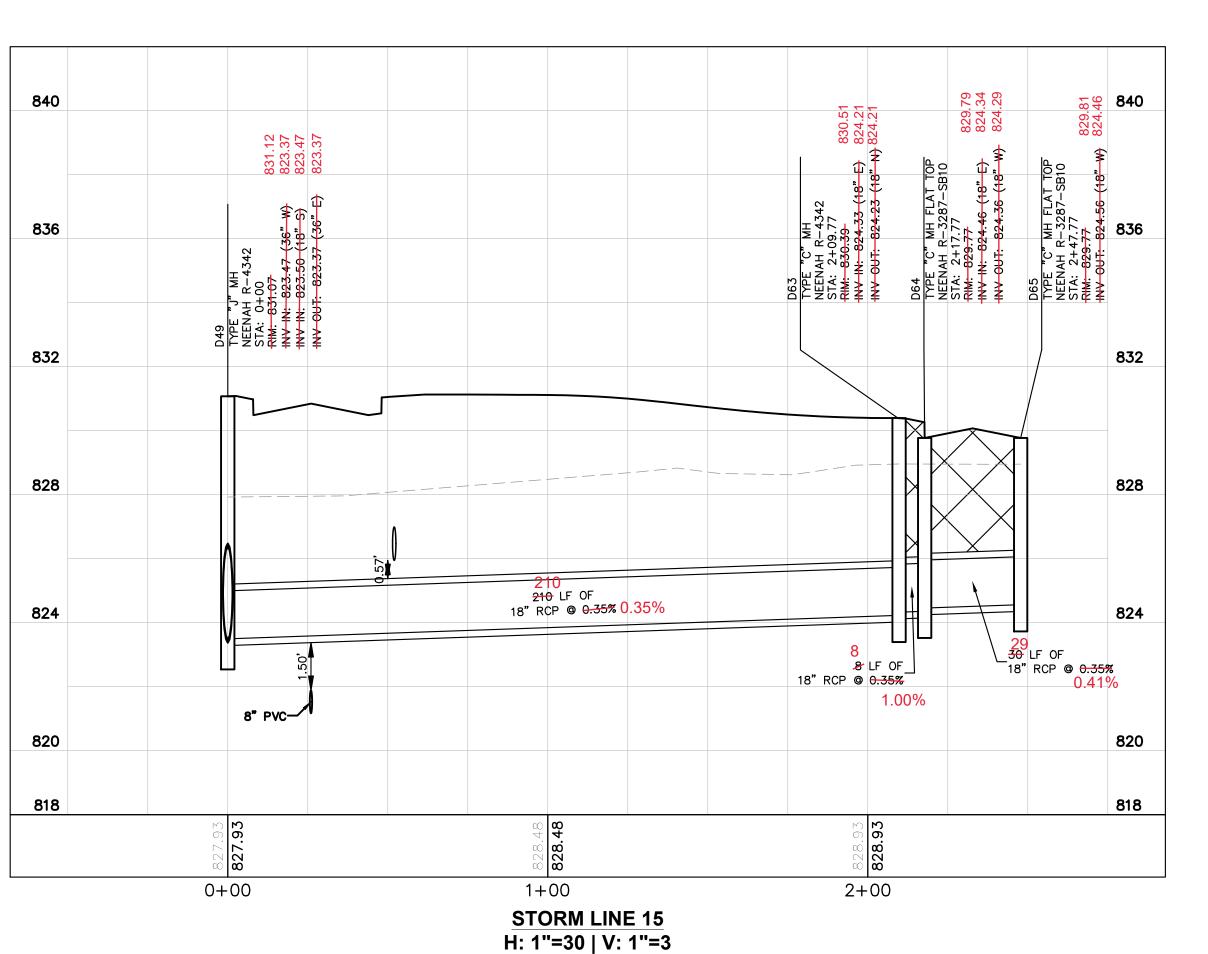

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GRANULAR BACKFILL
REQUIRED BENEATH AND WITHIN 5 FEET OF PAVEMENT

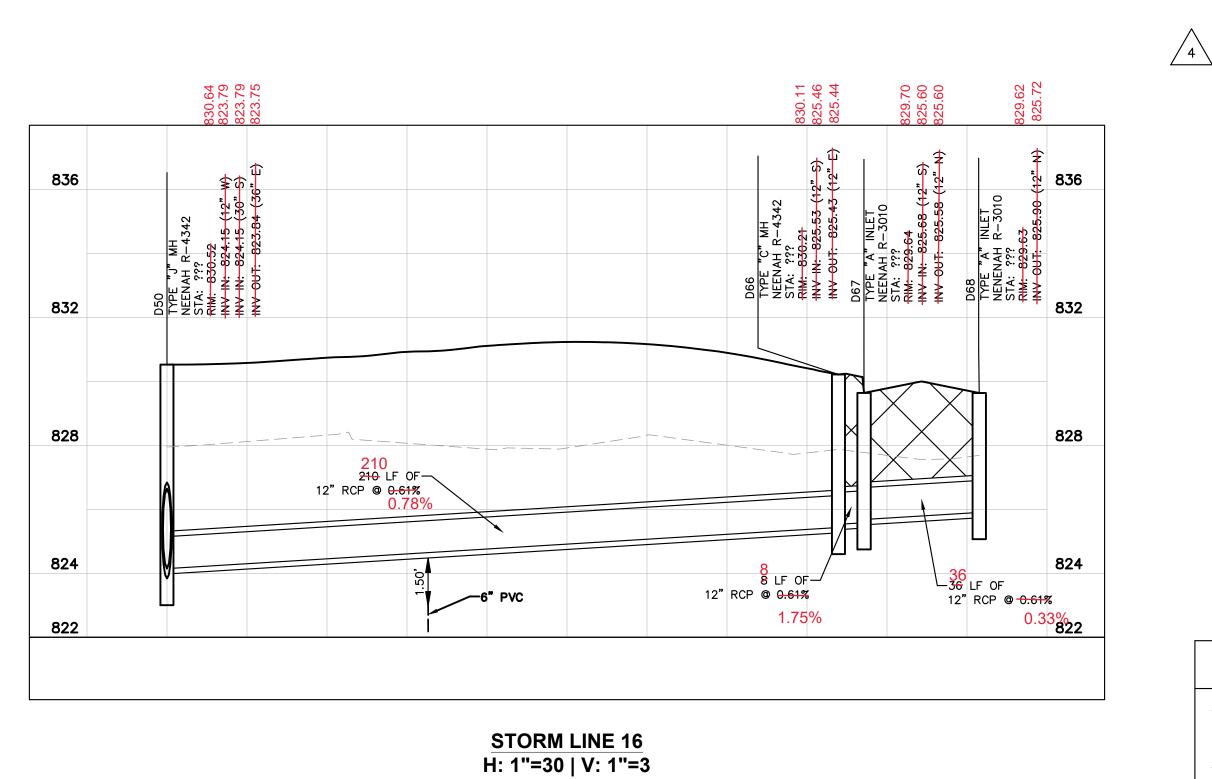C6.21

ORIGINAL ISSUE:

04/29/2019

KHA PROJECT NO. 170072000

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STORM (5 (

CAMPUS CENTER
146TH STREET &
PROMISE ROAD
NOBLESVILLE, IN

Kimley » Horn